ISSUE FOR BID

01.24.2024

PROJECT # SP 23-2
TULSA PERFORMING ARTS CENTER PACKAGE No. 1 AND No. 2

110 E. 2nd STREET TULSA, OKLAHOMA 74103



TULSA
110 WEST SEVENTH, SUITE 710
TULSA, OK 74119
T: 918.583.5300
F: 918.585.1967


OKLAHOMA CITY


131 DEAN A McGEE AVE, SUITE 138
OKLAHOMA CITY, OK 73102

IEW YORK CITY B7 PARK AVENUE SOUTH EW YORK, NY 10010

PROJECT NO: 202331.00



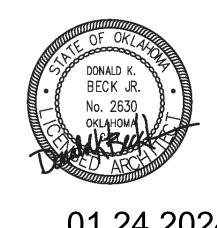

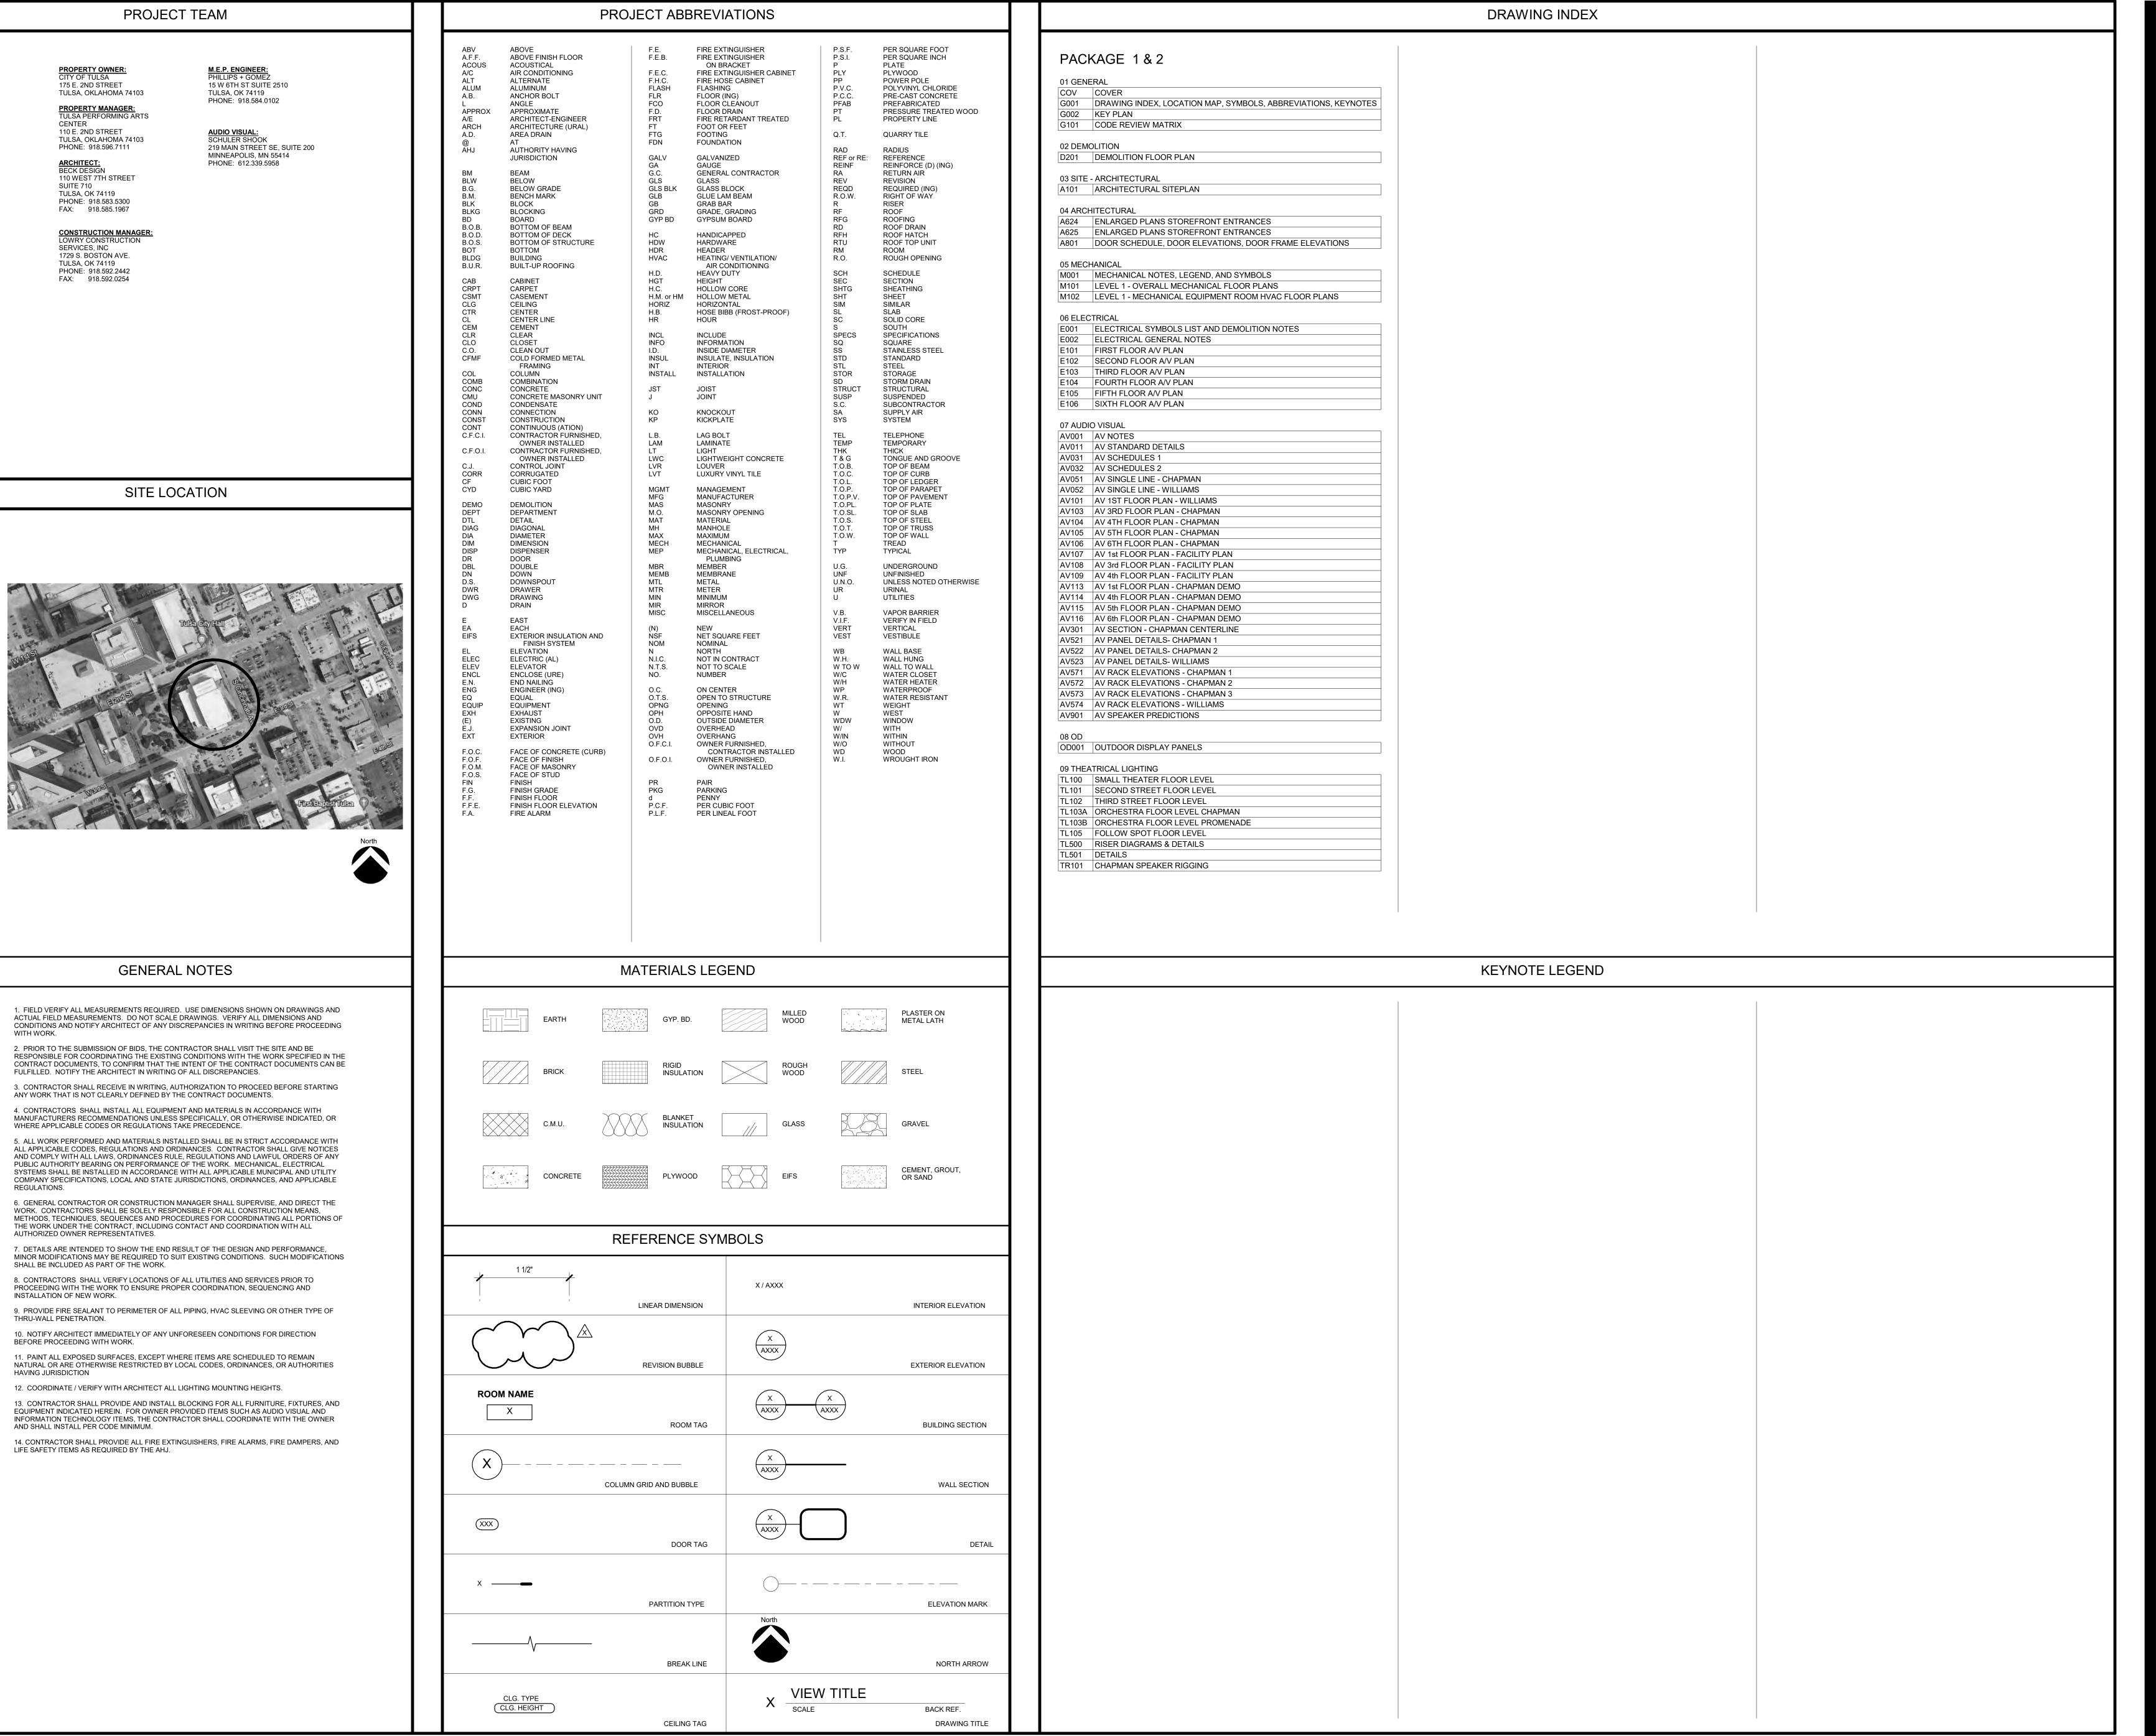



TULSA
110 WEST SEVENTH

OKLAHOMA CITY

131 DEAN A McGEE AVE
SUITE 135
OKLAHOMA CITY, OK 73102

TULSA. OK 74119

918.585.1967

PROJECT:
PROJECT #
SP 23-2
TULSA
PERFORMING
ARTS CENTER PACKAGE No. 1
AND No. 2

PROJECT NUMBER: **202331.00**

CONSULTANT:

REV	REVISIONS:				
No	Description	Date			
1	PERMIT SET	12.13.2023			
2	PERMIT SET EXT. SIGNS	01.17.2024			
3	ISSUE FOR BID	01.24.2024			

AL:





ISSUE DATE: **01.24.2024**


SHEET NUMBER:

G001

DRAWING INDEX, LOCATION MAP, SYMBOLS, ABBREVIATIONS, KEYNOTES

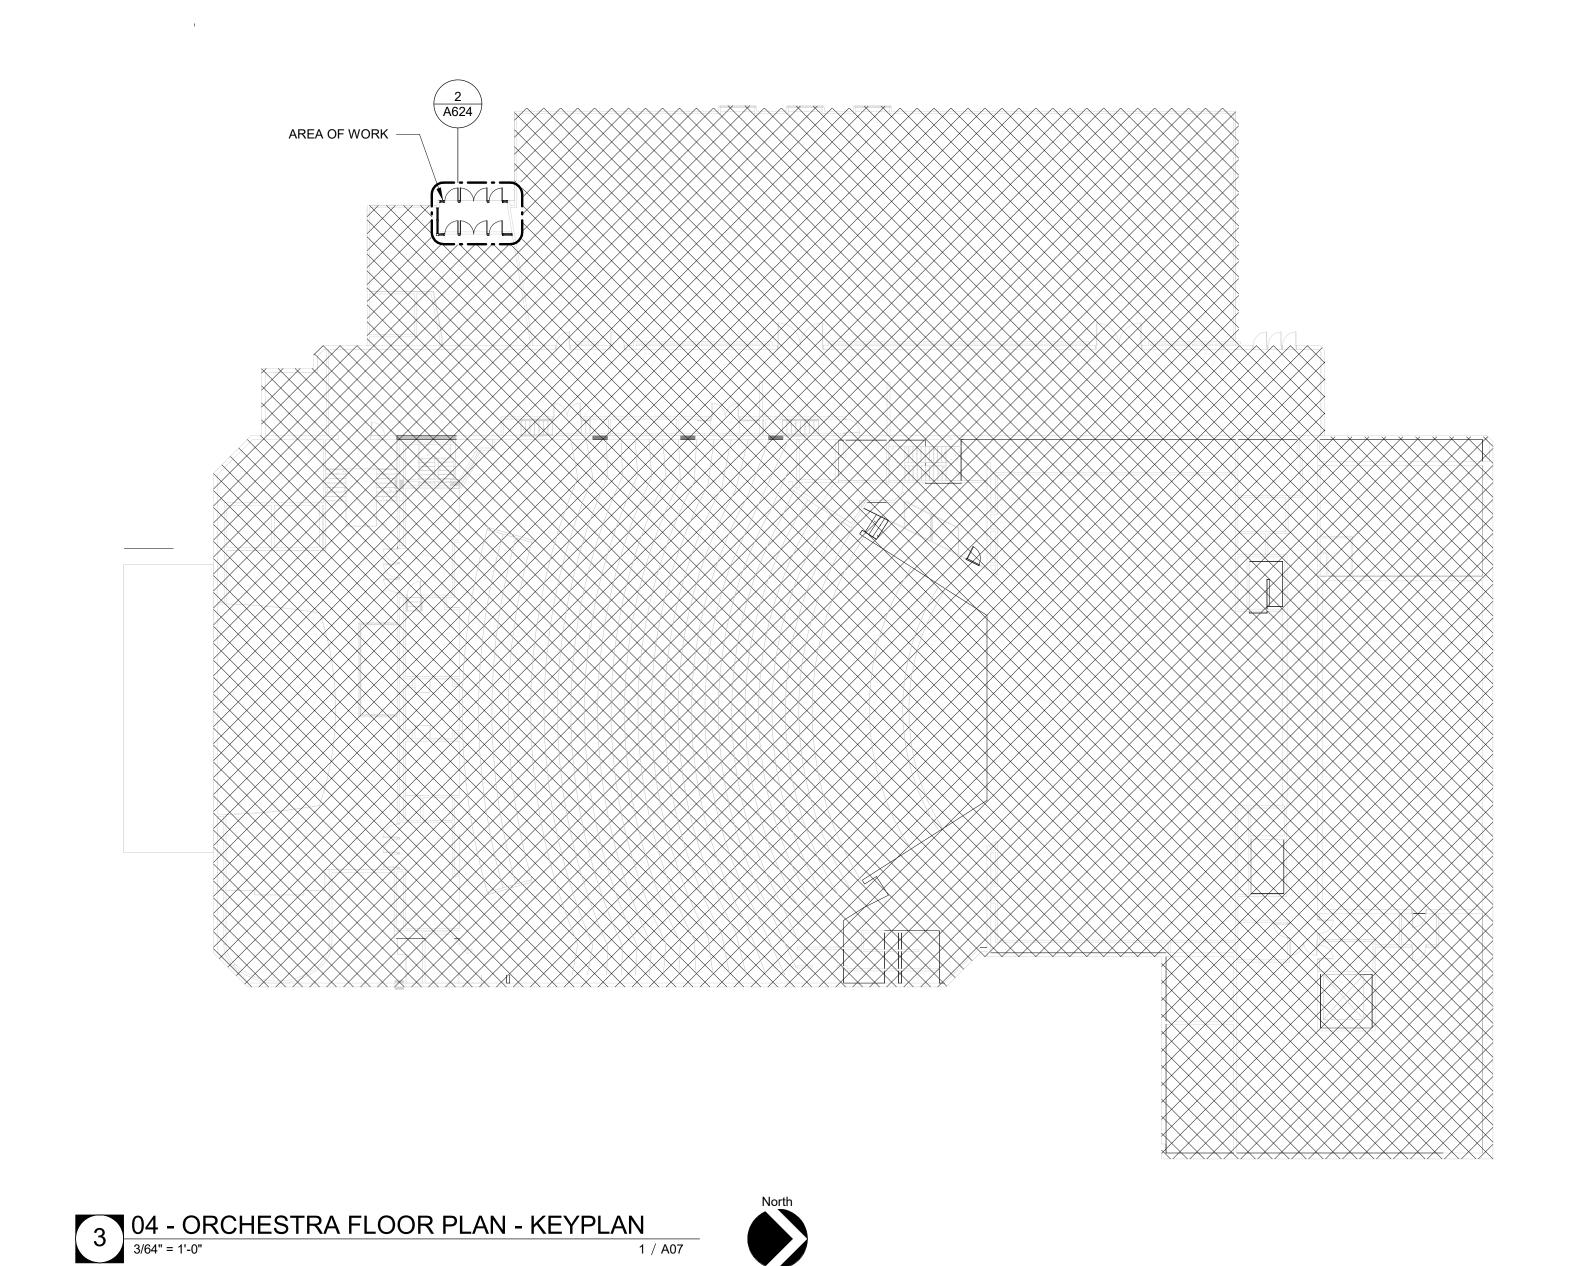


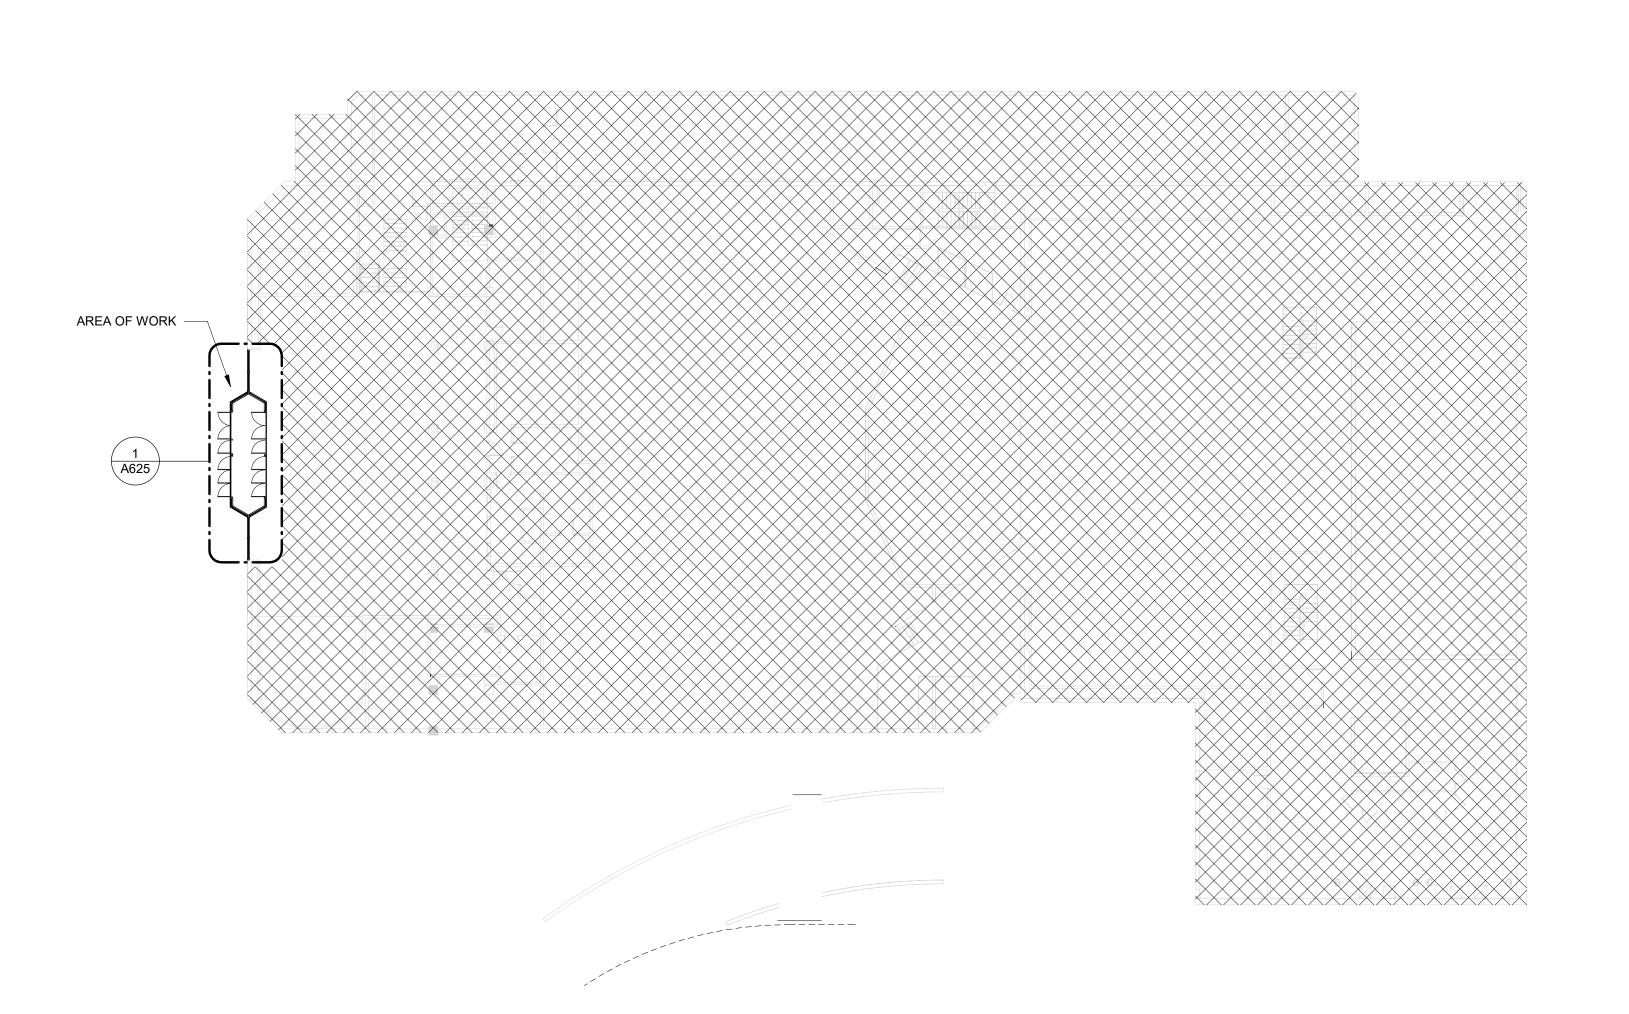

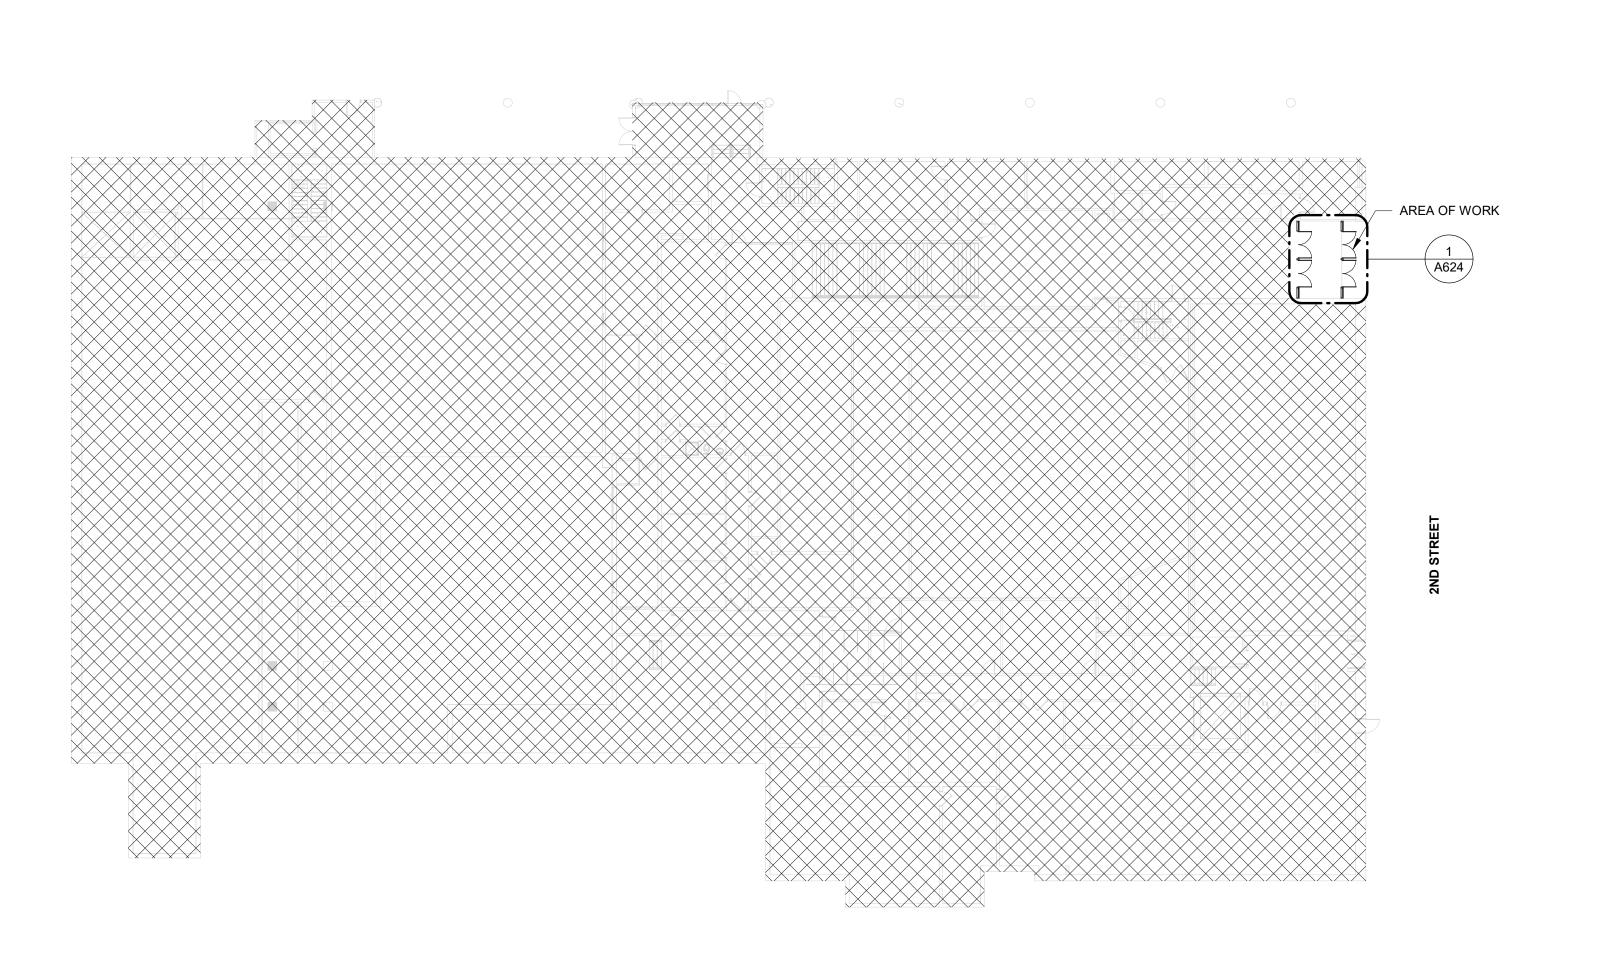





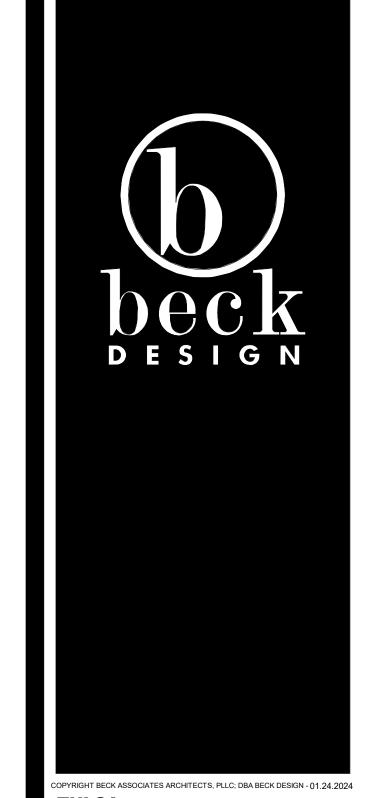

TULSA
110 WEST SEVENTH
SUITE 710
TULSA, OK 74119
T: 918.583.5300
F: 918.585, 1967

OKLAHOMA CITY


131 DEAN A McGEE AVE
SUITE 135
OKLAHOMA CITY. OK 73102

PROJECT:
PROJECT #
SP 23-2
TULSA
PERFORMING
ARTS CENTER PACKAGE No. 1
AND No. 2

PROJECT NUMBER: **202331.00**

CONSULTANT:

REVISIONS:					
No	Description	Date			
1	PERMIT SET	12.13.2023			
3	ISSUE FOR BID	01.24.2024			

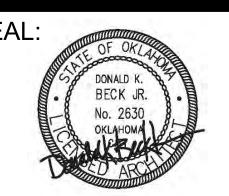

01.24.2024
ISSUE DATE:


01.24.2024SHEET NUMBER:

G002


KEY PLAN

GENERAL NOTE:

CONSTRUCTION MANAGER TO PROVIDE 36-IN TEMPORARY EXIT DOOR WITH TEMPORARY EXIT SIGN DURING CONSTRUCTION ON EACH RENOVATED ENTRANCE WHEN THE THEATERS ARE NO IN USE FOR PERFORMANCES.

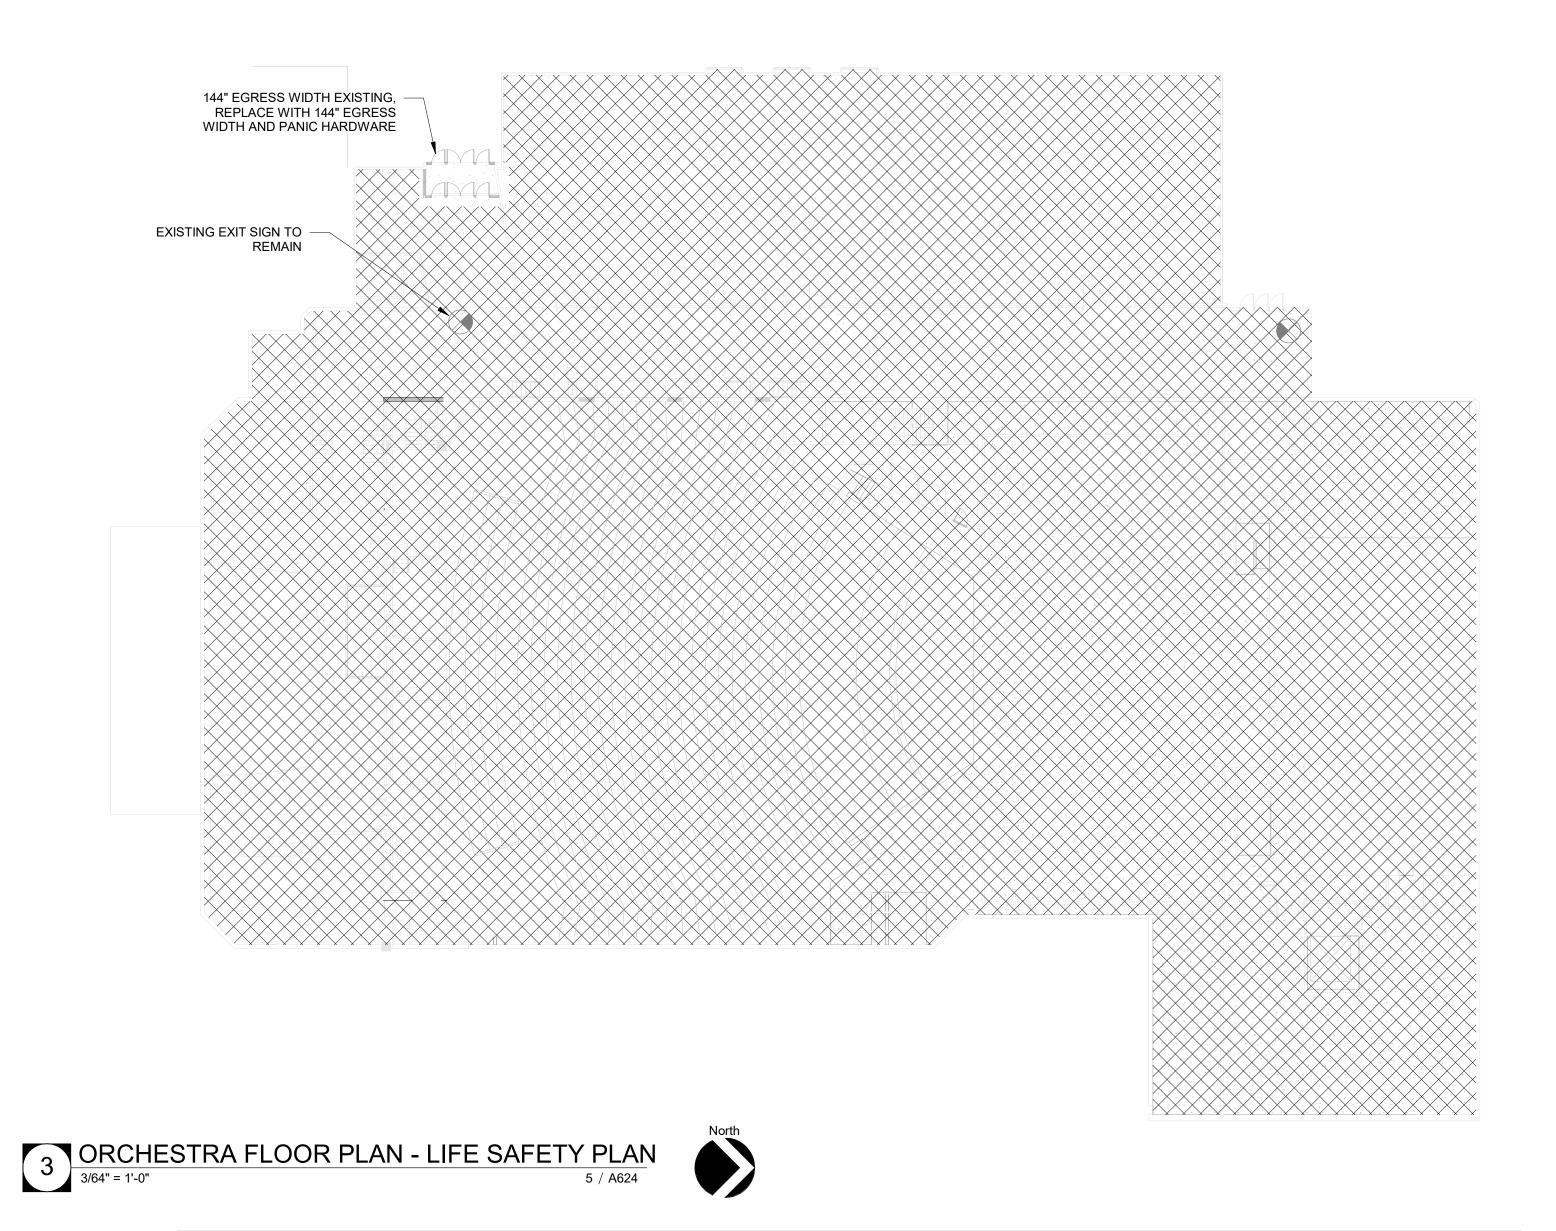

FIRE PROTECTION AT VESTIBULE - REFER TO FIRE PROTECTION LETTER DATED NOVEMBER 9, 2023. APPROVED BY FIRE MARSHAL, TULSA **OKLAHOMA**

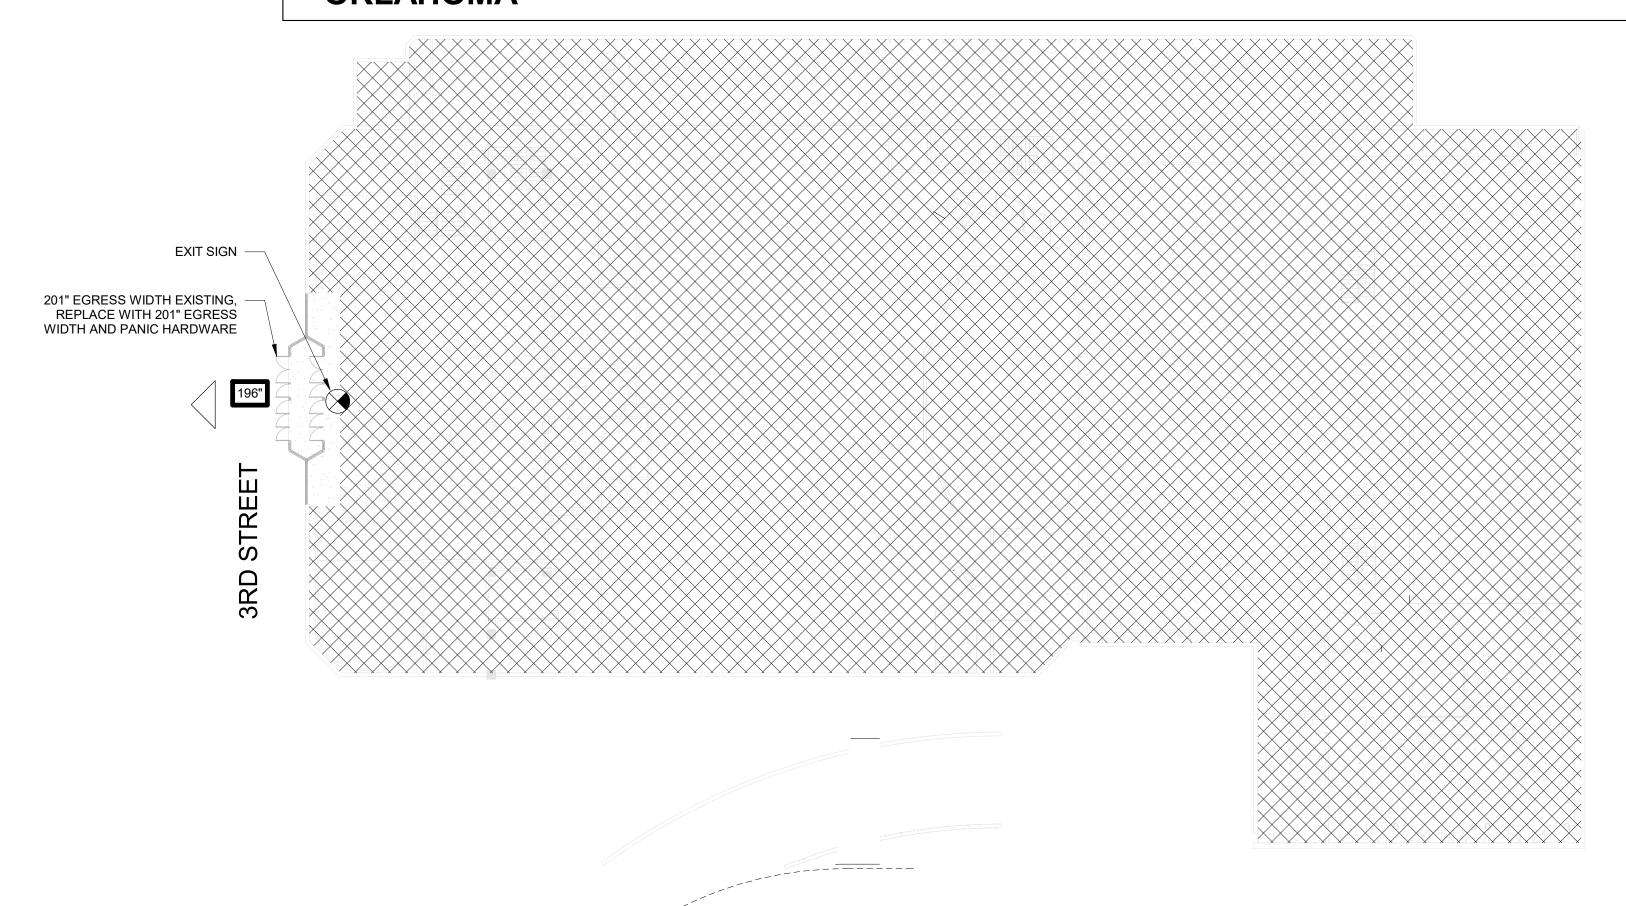





AUTHORITY HAVING JURISDICTION

CITY OF TULSA

ADOPTED CODES

INTERNATIONAL BUILDING CODE®, 2018 EDITION INTERNATIONAL EXISTING BUILDING CODE®, 2018 EDITION

NATIONAL ELECTRIC CODE®, 2014 EDITION

2010 ADA STANDARDS FOR ACCESSIBLE DESIGN ACCESSIBLE AND USABLE BUILDINGS AND FACILITIES, ICC A117.1, 2009 EDITION, AMERICAN NATIONAL STANDARDS INSTITUTE®

CODE STUDY

BUILDING USE OR OCCUPANCY NO CHANGES IN PRIMARY OVERALL BUILDING USE OR OCCUPANCY

IEBC 101.4.2 BUILDING PREVIOUSLY OCCUPIED SHALL BE PERMITTED TO CONTINUE WITHOUT A CHANGE

LEVEL 1 ALTERATIONS INCLUDE THE REMOVAL AND REPLACEMENT OR THE COVERING OF EXISTING MATERIALS, ELEMENTS, EQUIPMENT, OR FIXTURES USING NEW

IBC 302 / 305 PRIMARY BUILDING OCCUPANCY REPLACE EXISTING STOREFRONTS FOR NEW STOREFRONTS, NO CHANGES TO DOOR WIDTHS AND QUANTITY

BUILDING CONSTRUCTION

NO CHANGES TO BUILDING TYPE OF CONSTRUCTION

IBC TABLE 803.13 | CEILING FINISH REQUIREMENT BY OCCUPANCY.

CONSTRUCTION TYPE ASSUME TO BE I-B FULLY SPRINKLERED

THRESHOLD (FIRE AREA, SF) BASED ON OCCUPANCY

AUTOMATIC SPRINKLER SYSTEMS

NO CHANGES TO EXISTING SPRINKLER SYSTEM

SPRINKLER REQUIRED?

SPRINKLER PROVIDED?

ROOMS AND ENCLOSE SPACES

ASSEMBLY A-1 (THEATER)

NEWLY INSTALLED CEILING FINISHES SHALL COMPLY WITH CHAPTER 8 ON THE INTERNATIONAL BUILDING CODE

NEWLY INSTALLED INTERIOR FLOOR FINISH, INCLUDING NEW RECESSED FLOOR MAT AND PORCELAIN TILE USED AS A INTERIOR FLOOR FINISH MATERIAL, SHALL COMPLY WITH SECTION 804 OF THE INTERNATION BUILDING CODE. IT SHALL MEET THE REQUIREMENTS OF A CLASS II MATERIAL (804.2)

INT. EXIT STAIRWAYS AND RAMPS | CORRIDORS AND ENCLOSURE FOR AND EXIT PASSAGEWAYS EXIT ACCESS STAIRWAYS AND RAMP

ASSEMBLY A-3 (SPRINKLERED)

OCCUPANT LOAD CALCULATIONS

NO CHANGES TO OCCUPANT LOAD.

MEANS OF EGRESS NO CHANGES TO MEANS OF EGRESS

REPAIRS SHALL BE DONE IN A MANNER THAT MAINTAINS THE LEVEL OF PROTECTION PROVIDED FOR THE MEANS OF EGRESS

EXIT ACCESS

NO CHANGES TO EXIT ACCESS AND TRAVEL DISTANCE. EXITS REMAIN AT THE SAME LOCATIONS.

PLUMBING FIXTURE CALCULATION NO CHANGES TO PLUMBING FIXTURES.

GENERAL NOTES

1. BUILDING SHALL BE FULLY SPRINKLED

2. BUILDING SHALL HAVE FULL FIRE ALARM COVERAGE 3. ALL DOORS IN 1 HOUR WALLS SHALL BE RATED 45 MINUTES

NO CHANGES TO FIRE EXTINGUISHERS LOCATIONS OR AMOUNT.

4. PROVIDE EXIT SIGNAGE PER CODE. 5. PROVIDE EMERGENCY LIGHTING, NOT LESS THAN 1 FOOT CANDLE AVERAGE, PER CODE

6. ALL COMBUSTIBLE MATERIALS SHALL MEET THE REQUIREMENTS OF IBC 603 & 805 7. ALL INTERIOR WALL AND CEILING FINISHES SHALL COMPLY WITH IBC 803 & IFC 804

8. ALL INTERIOR FLOORING SHALL MEET THE REQUIREMENTS OF A CLASS II MATERIAL

9. TEMPERED GLASS SHALL BE PROVIDED WITHIN 2 FEET OF ALL EXITS 10. PROVIDE HANDICAP SIGNAGE THROUGHOUT AS PER IBC 111

11. CONSTRUCTION MANAGER TO PROVIDE 36-IN TEMPORARY EXIT DOOR WITH TEMPORARY EXIT SIGN DURING CONSTRUCTION ON EACH RENOVATED ENTRANCE WHEN THE THEATERS ARE NO IN USE FOR PERFORMANCES.


LEGEND - LIFE SAFETY

1 WAY EXIT SIGN, 90 MIN BATTERY BACKUP EXISTING 1 WAY EXIT SIGN

34"

EXIT ACCESS

EGRESS WIDTH PROVIDED

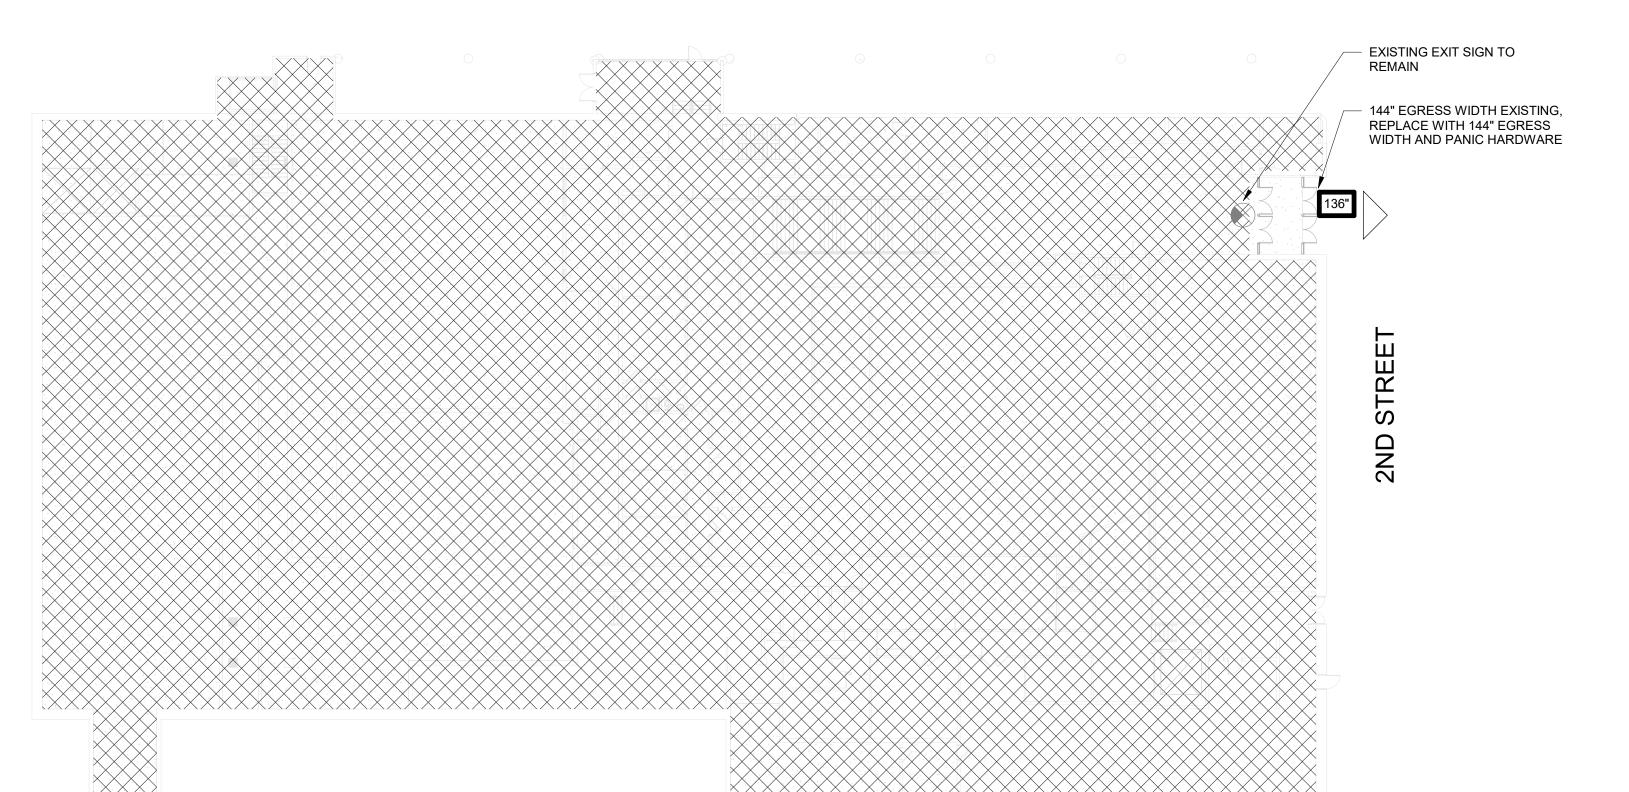







PYRIGHT BECK ASSOCIATES ARCHITECTS, PLLC; DBA BECK DESIGN - 01.24.2024 TULSA

TULSA, OK 74119 T: 918.583.5300 918.585.1967


OKLAHOMA CITY SUITE 135 OKLAHOMA CITY, OK 73102

SP 23-2 TULSA PERFORMING ARTS CENTER -PACKAGE No. 1 AND No. 2

PROJECT NUMBER:

202331.00 **CONSULTANT:**

REVISIONS:

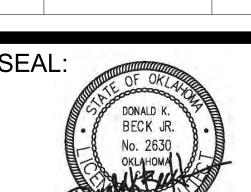


01.24.2024


ISSUE DATE: 01.24.2024


SHEET NUMBER:


G101 **CODE REVIEW MATRIX**

SHEET NOTES - SITE PLAN ANY DAMAGED SIDEWALKS OR PAVING DUE TO
CONSTRUCTION ACTIVITY SHALL BE REPLACED TO MATCH
ORIGINAL CONDITION.

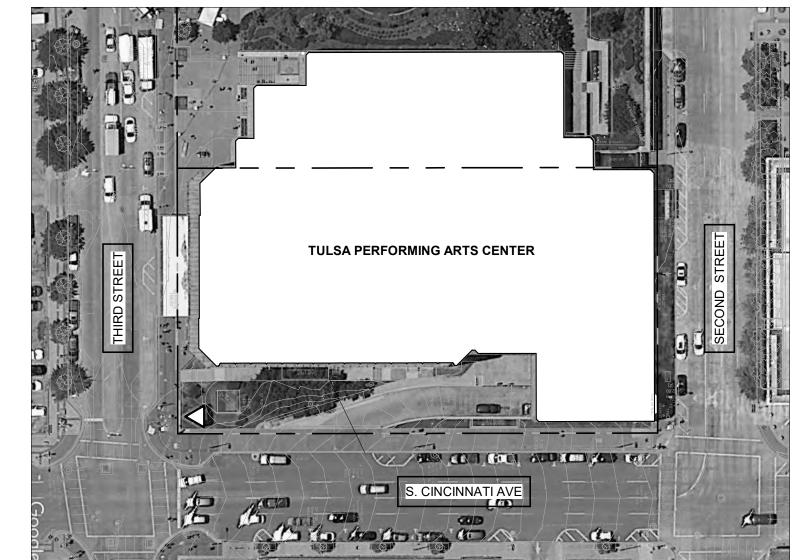

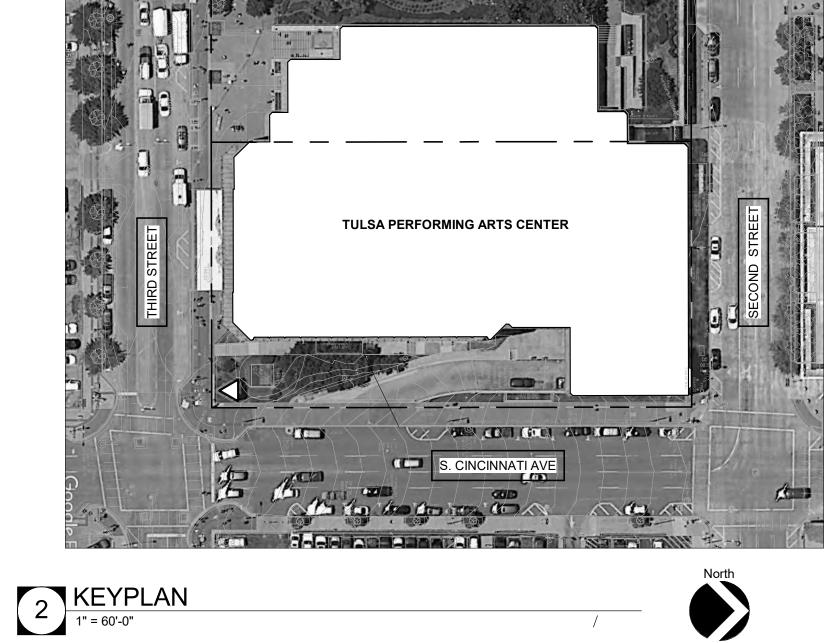

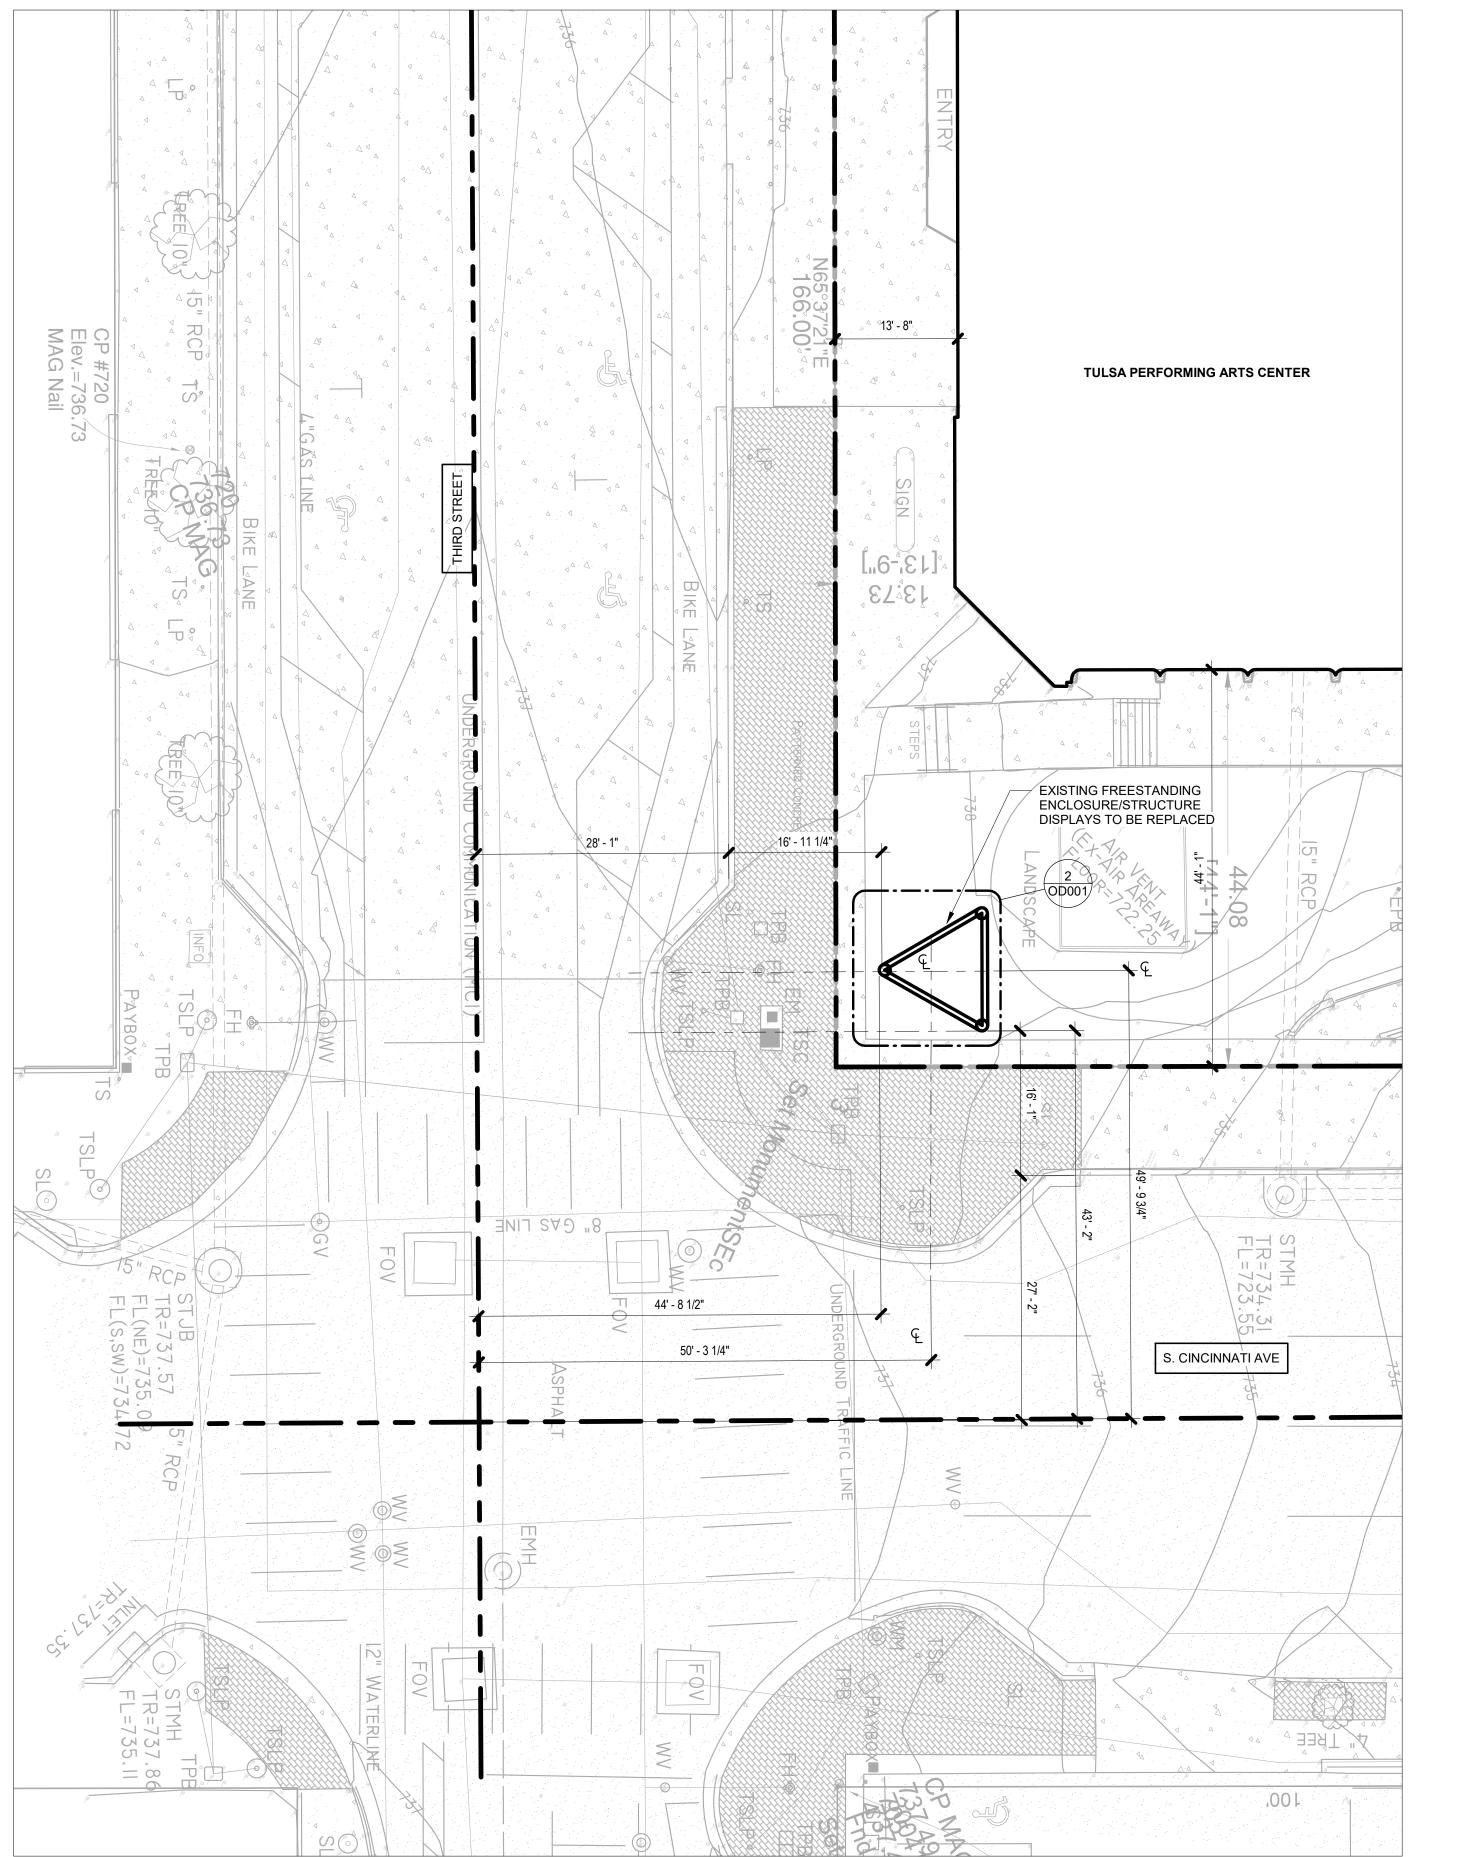

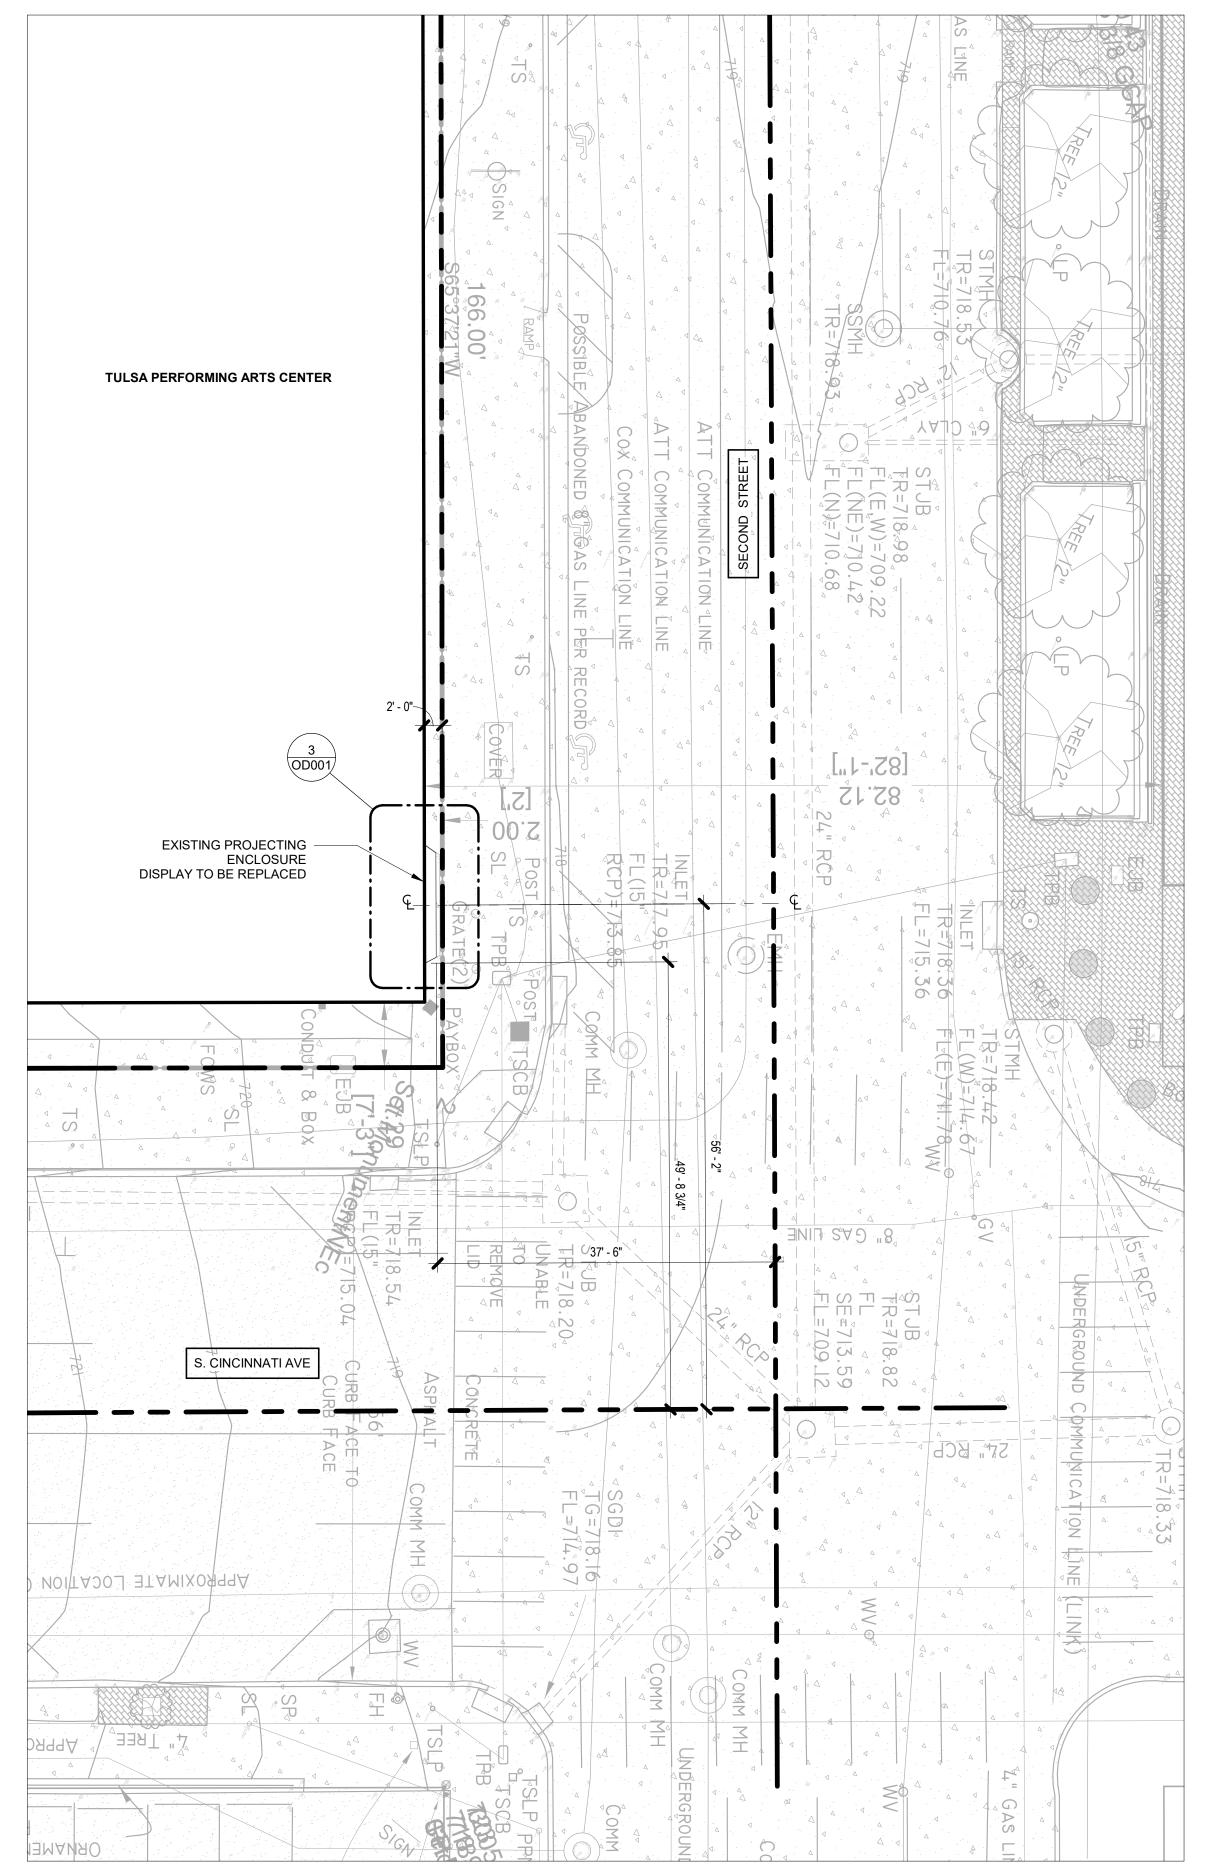







TULSA
110 WEST SEVENTH SUITE 710 TULSA, OK 74119 T: 918.583.5300 F: 918.585.1967


OKLAHOMA CITY
131 DEAN A McGEE AVE
SUITE 135
OKLAHOMA CITY, OK 73102
T: 405.232.7007

PROJECT: PROJECT # SP 23-2 TULSA **PERFORMING ARTS CENTER -**PACKAGE No. 1 AND No. 2

PROJECT NUMBER: 202331.00

CONSULTANT:


REVISIONS: ISSUE FOR BID

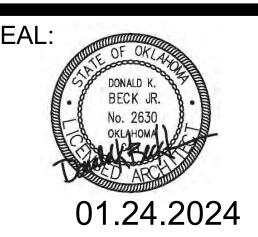


ISSUE DATE: 01.24.2024

SHEET NUMBER:

A101 ARCHITECTURAL SITEPLAN

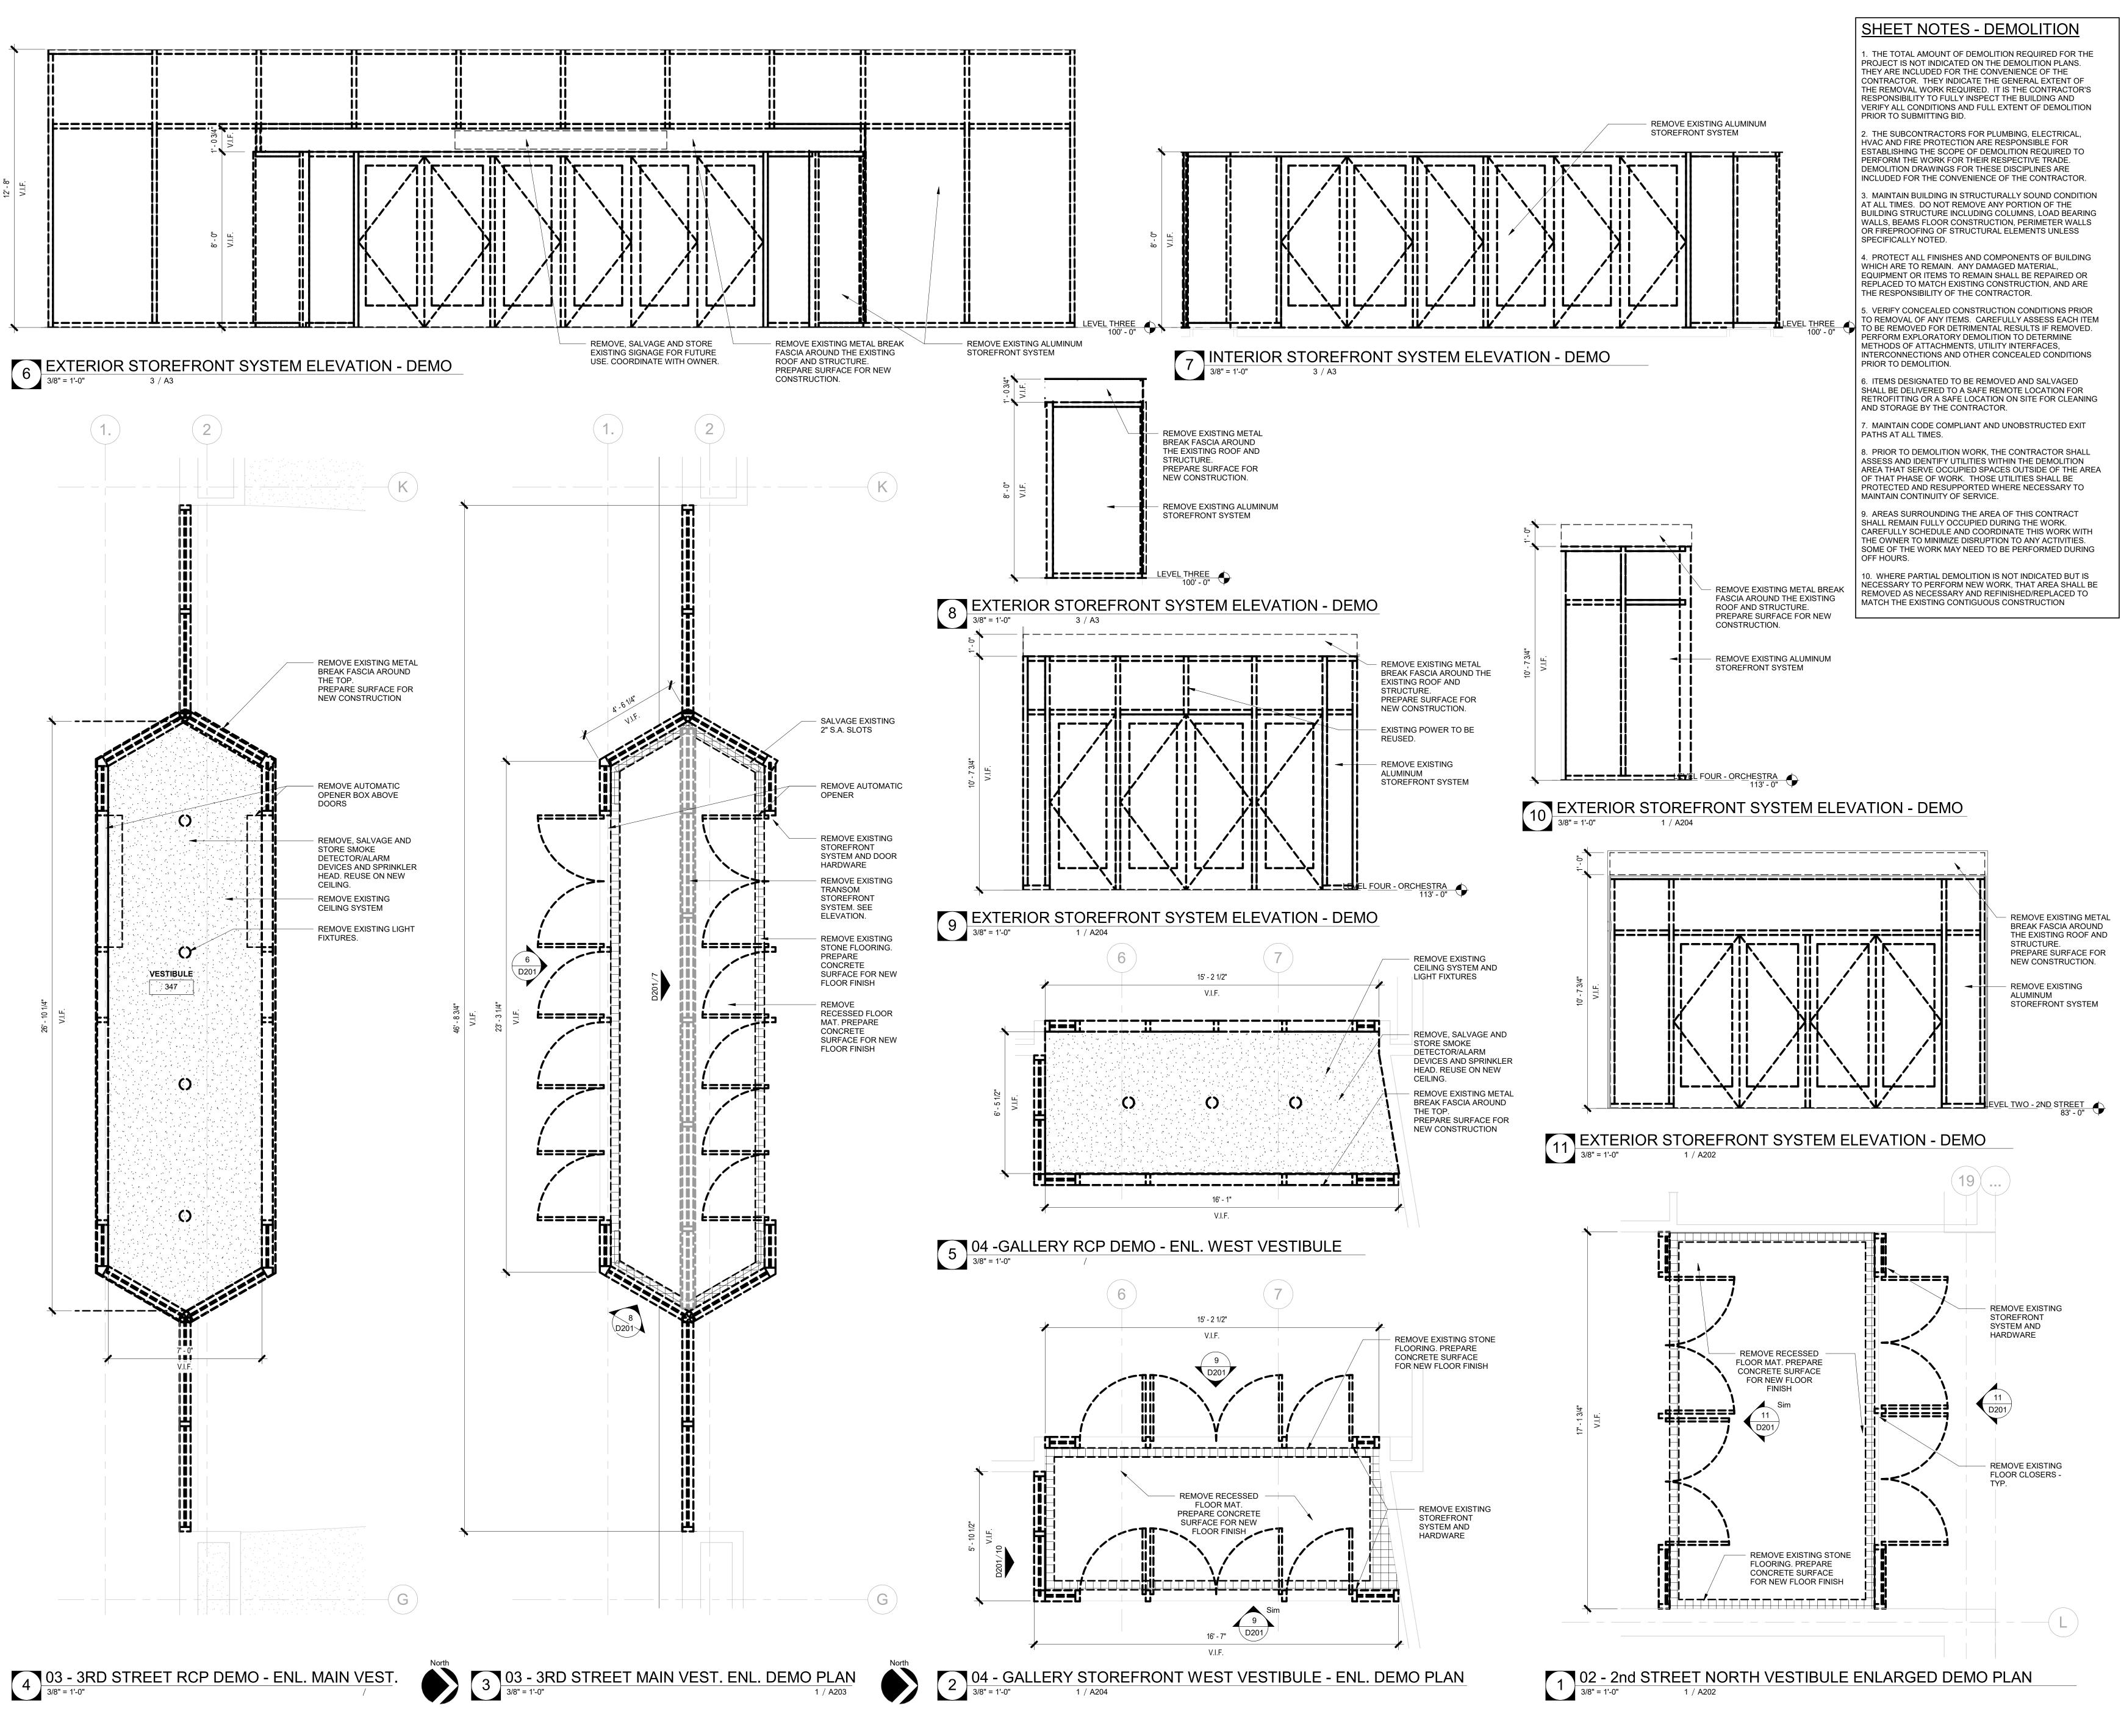

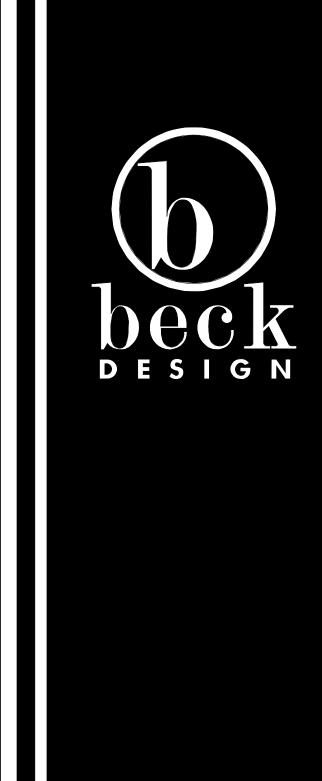

TULSA
110 WEST SEVENTH
SUITE 710
TULSA, OK 74119
T: 918.583.5300
F: 918.585.1967

OKLAHOMA CITY
131 DEAN A McGEE AVE
SUITE 135
OKLAHOMA CITY, OK 73102

T: 405.232.7007

PROJECT:
PROJECT #
SP 23-2
TULSA
PERFORMING
ARTS CENTER PACKAGE No. 1
AND No. 2


PROJECT NUMBER: **202331.00**

CONSULTANT:

 No
 Description
 Date

 1
 PERMIT SET
 12.13.2023

 3
 ISSUE FOR BID
 01.24.2024

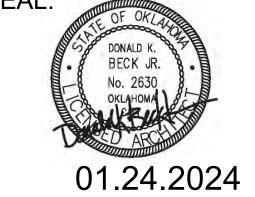



ISSUE DATE: **01.24.2024**


SHEET NUMBER:


D201
DEMOLITION FLOOR


SHEET NOTES - GLAZING TYPES 1. NOT ALL GLAZING IN THE PROJECT IS REPRESENTED IN THESE GLAZING TYPE SHEETS. REFERENCE PLANS, ELEVATIONS, SECTIONS, AND DOOR FRAME SCHEDULE FOR ALL GLAZING IN PROJECT. 2. ALL DIMENSIONS MUST BE VERIFIED IN FIELD PRIOR TO 3. TEMPERED GLASS SHALL BE PROVIDED WITHIN 2 FEET OF ALL EXITS, OR WHERE NOTED. T = TEMPERED SAFETY GLASS

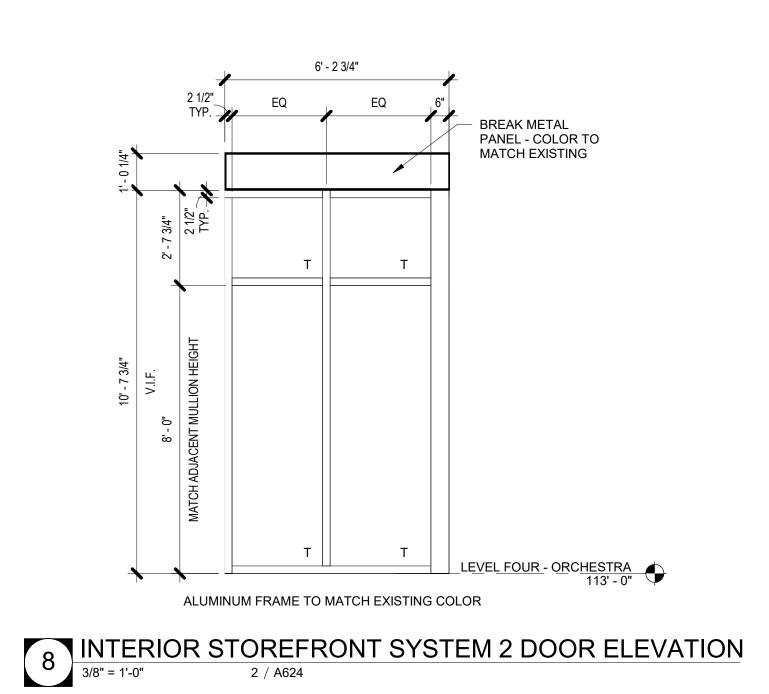


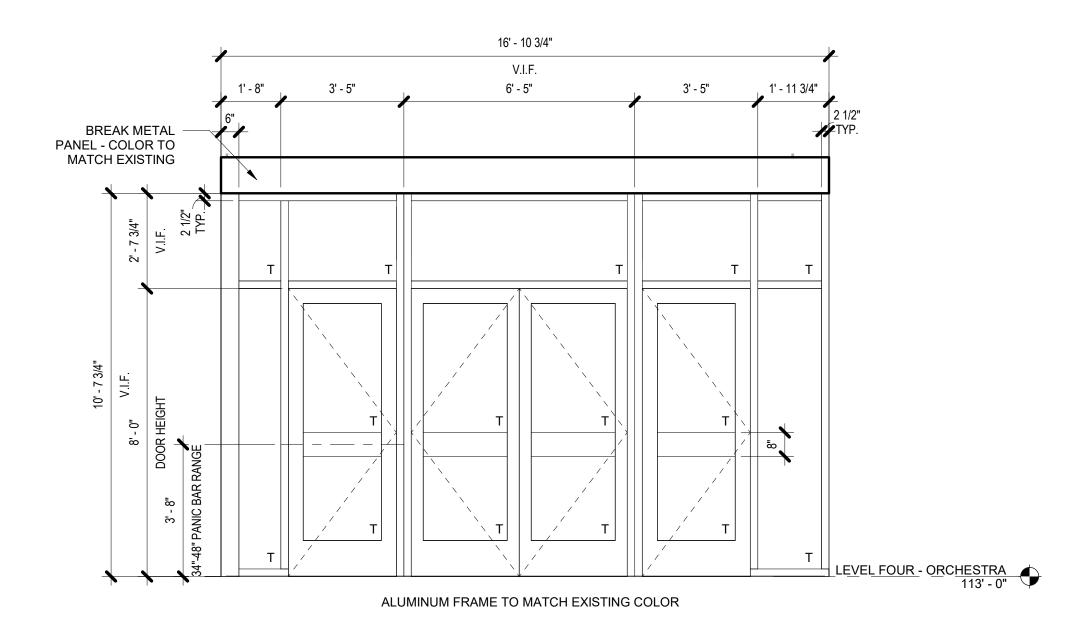

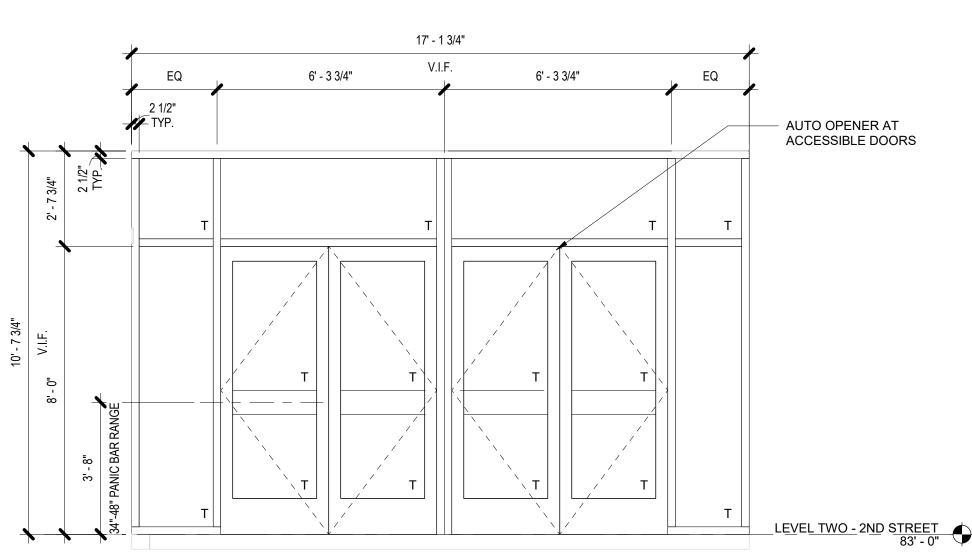


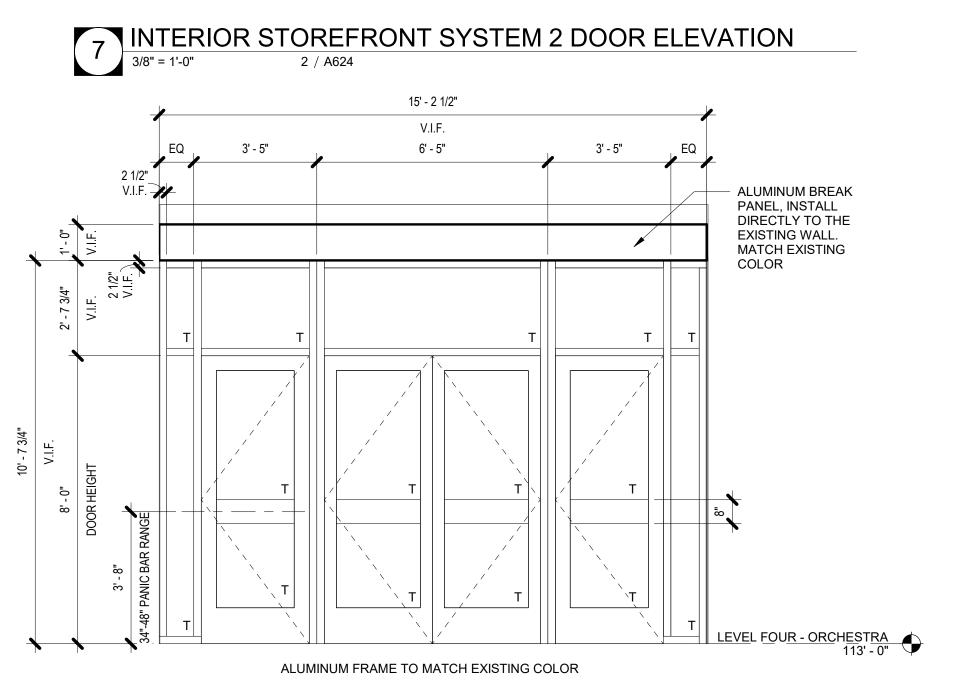


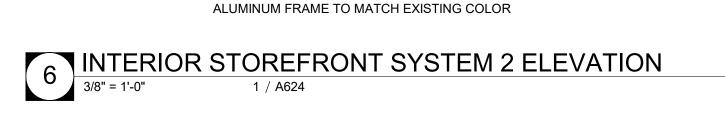


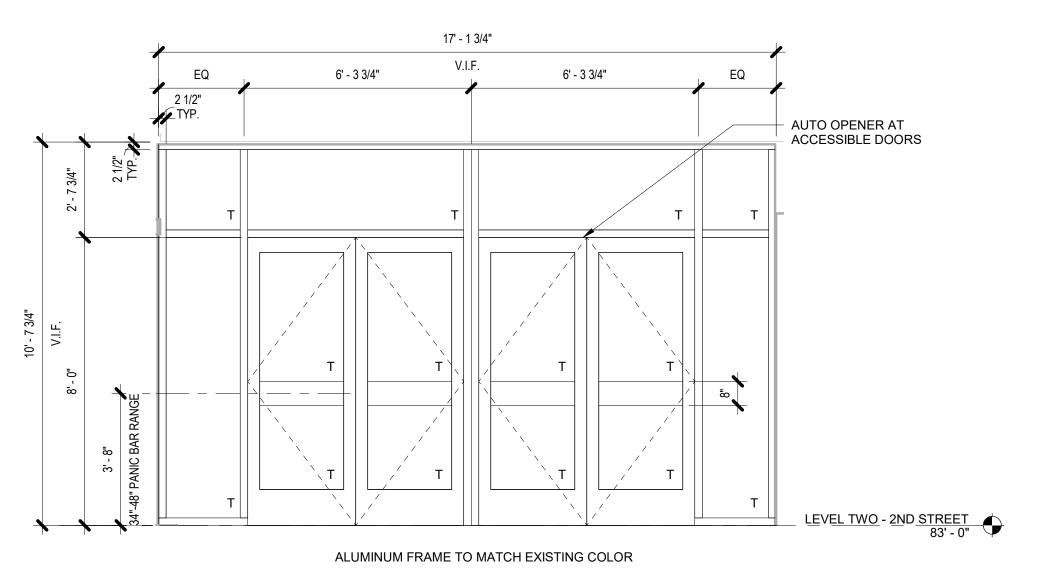




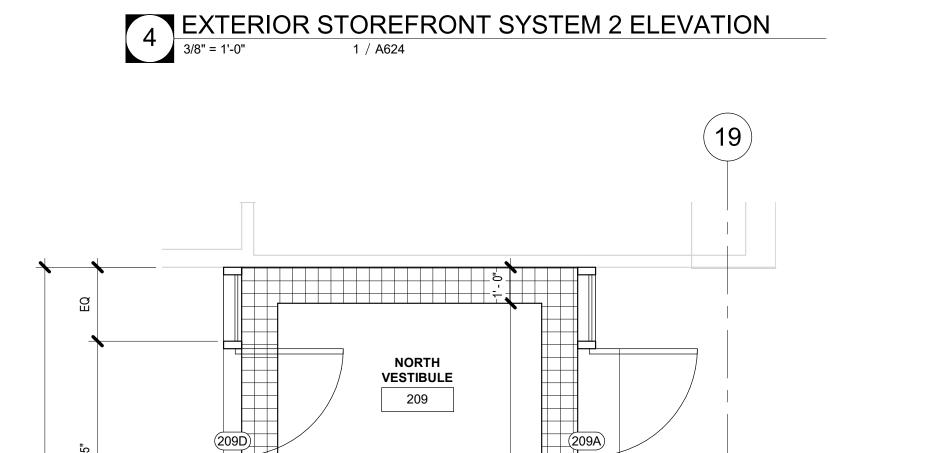


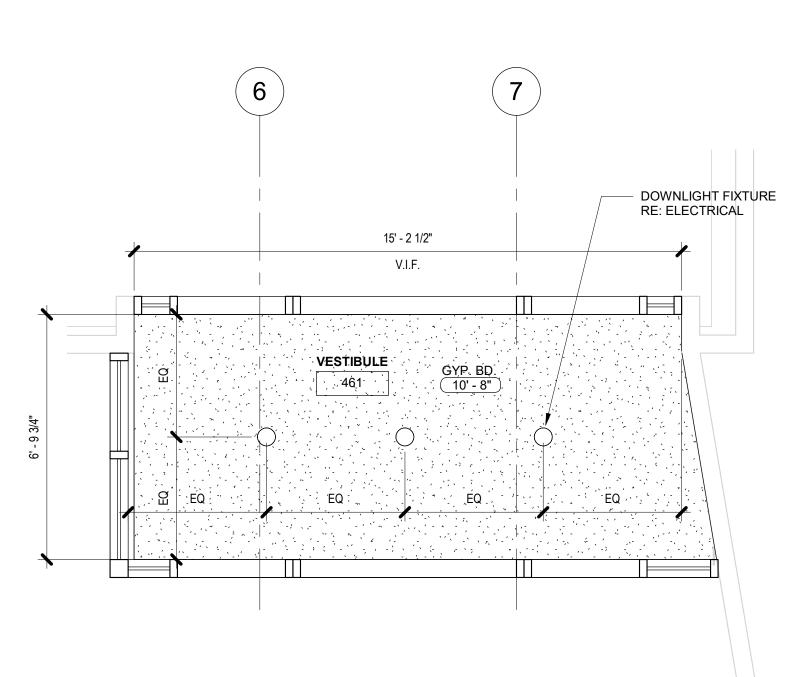

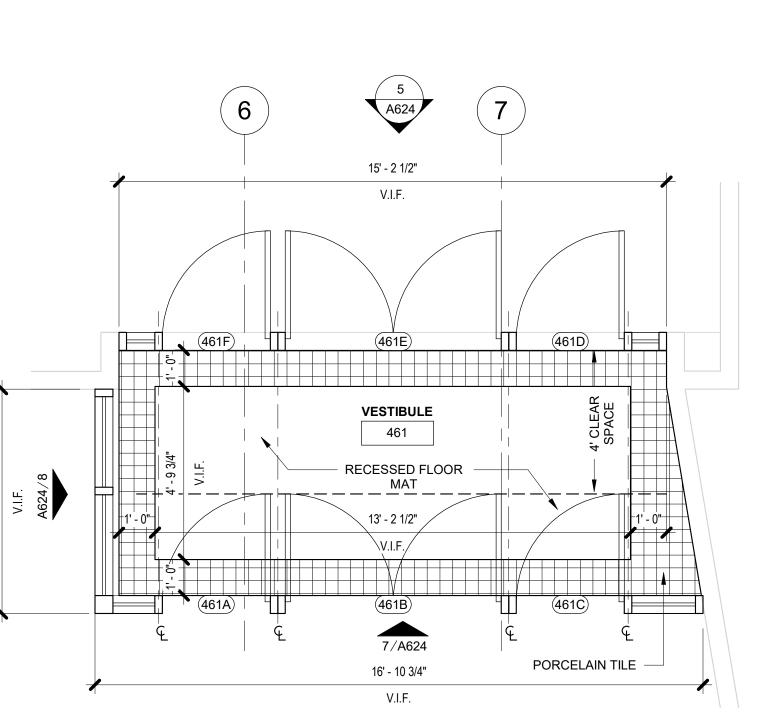

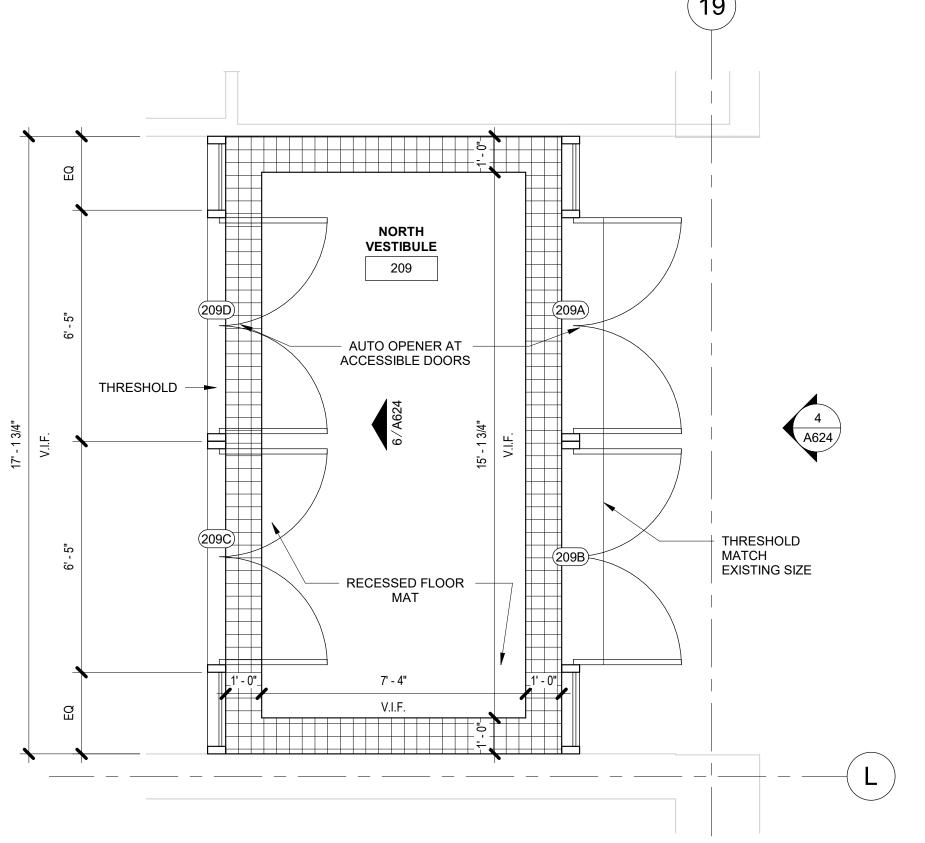



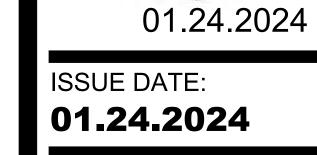

DPYRIGHT BECK ASSOCIATES ARCHITECTS, PLLC; DBA BECK DESIGN - 01.24.2024

TULSA 110 WEST SEVENTH

SUITE 710 TULSA, OK 74119 T: 918.583.5300

: 918.585.1967

OKLAHOMA CITY 131 DEAN A McGEE AVE

SUITE 135 OKLAHOMA CITY, OK 73102 T: 405.232.7007

PROJECT:

SP 23-2

TULSA

PROJECT #

AND No. 2

PERFORMING

ARTS CENTER -

PACKAGE No. 1

PROJECT NUMBER:

202331.00


CONSULTANT:

REVISIONS:


ISSUE FOR BID

SHEET NUMBER: A624


ENLARGED PLANS STOREFRONT ENTRANCES

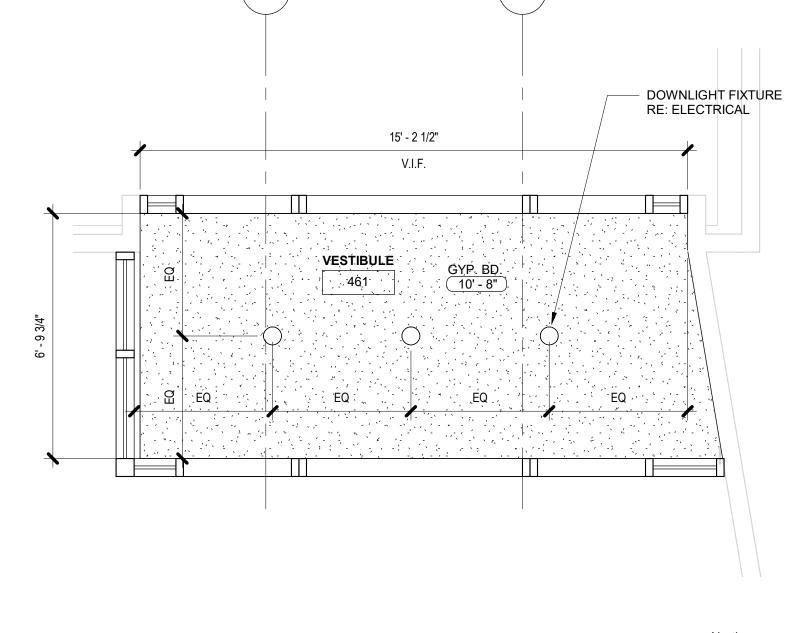

3 04 -GALLERY RCP - ENL. WEST VESTIBULE

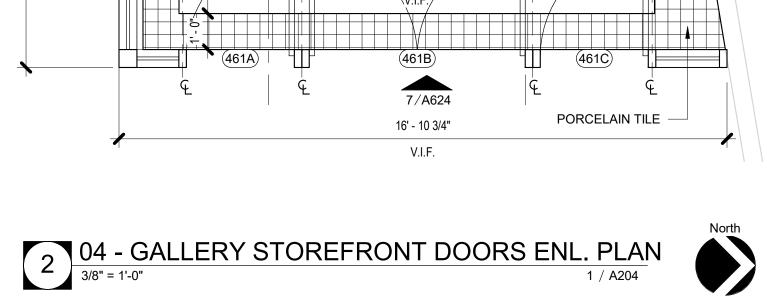



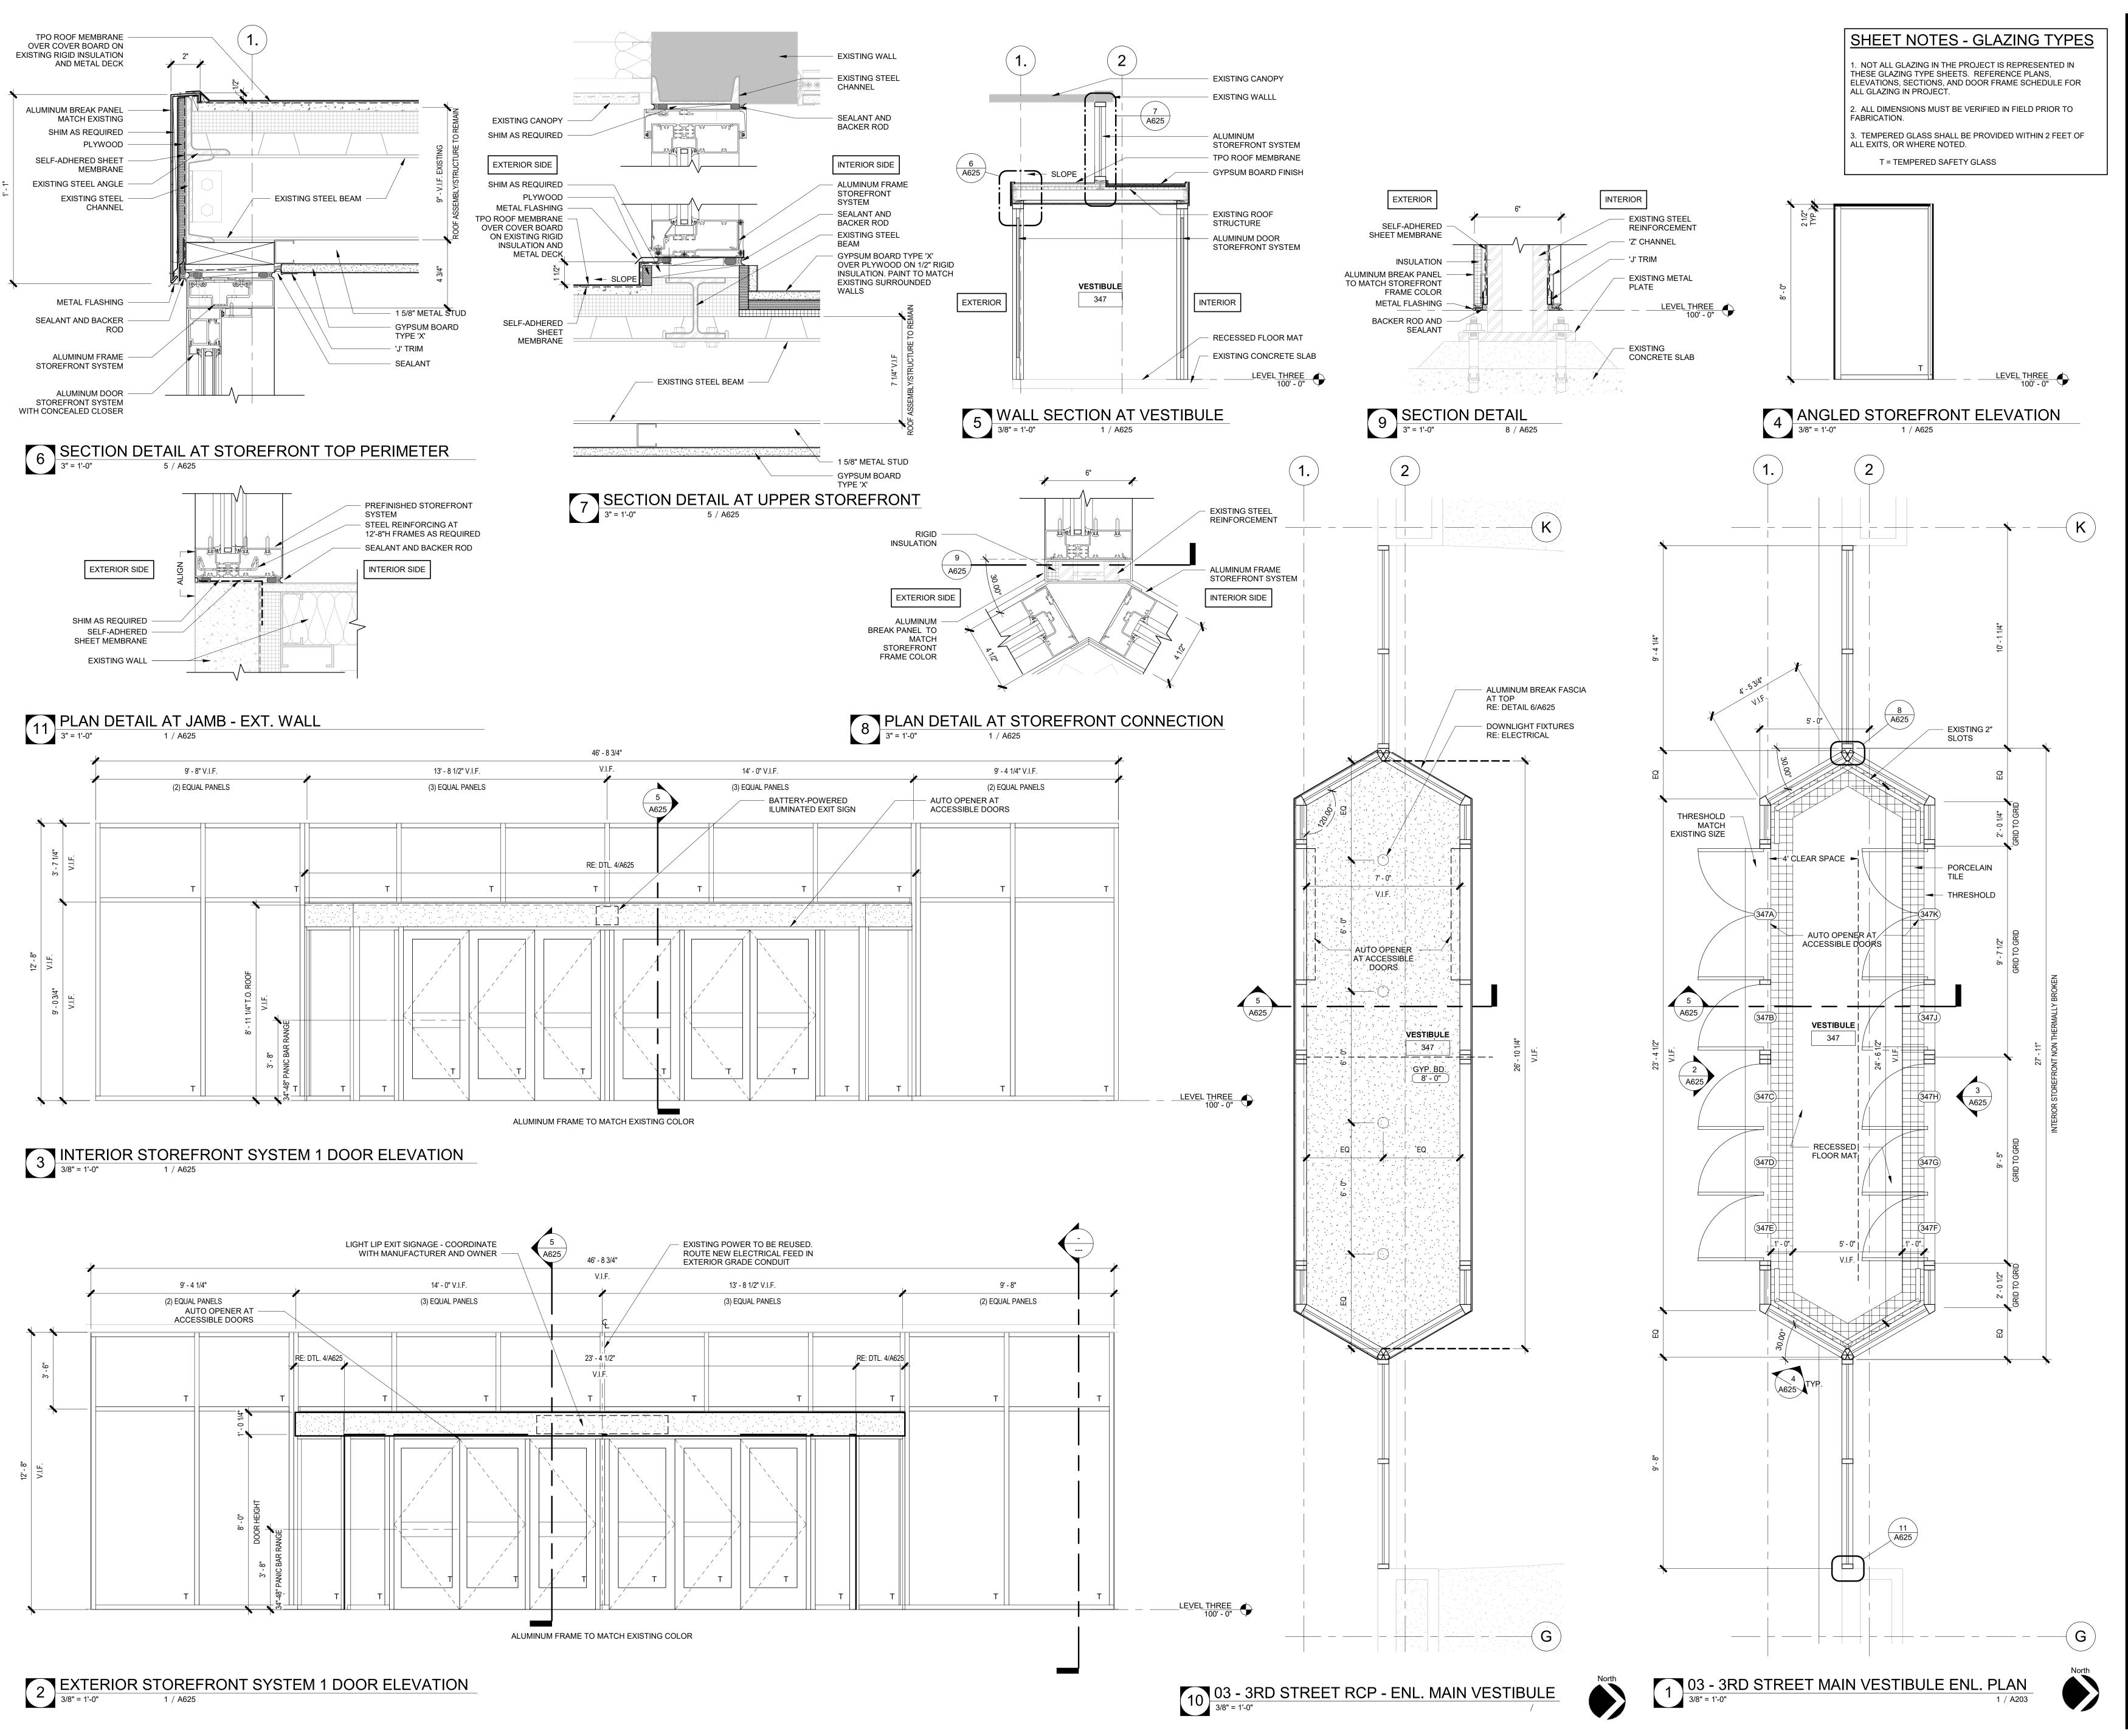

beck Design

TULSA
110 WEST SEVENTH
SUITE 710
TULSA, OK 74119
T: 918.583.5300
F: 918.585.1967

131 DEAN A McGEE AVE

OKLAHOMA CITY, OK 73102

SUITE 135

Г: 405.232.7007

PROJECT:
PROJECT #
SP 23-2
TULSA
PERFORMING
ARTS CENTER PACKAGE No. 1
AND No. 2


PROJECT NUMBER: **202331.00**

CONSULTANT:

 No
 Description
 Date

 1
 PERMIT SET
 12.13.2023

 3
 ISSUE FOR BID
 01.24.2024

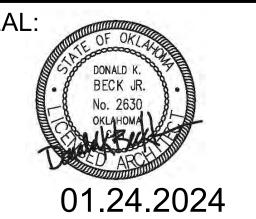


ISSUE DATE: **01.24.2024**

SHEET NUMBER:


A625

ENLARGED PLANS STOREFRONT ENTRANCES


					DOOR S	SCHEDULE		
		DO	OR			FRA	ME	
	OPENI	NG SIZE	DOOR	DOOR	DOOR	FRAME	FRAME	
DOOR NO.	WIDTH	HEIGHT	TYPE	MATERIAL	FINISH	MATERIAL	FINISH	REMARKS
209A	6' - 0"	8' - 0"	Н	ALUM / GLS	FACTORY	ALUM	FACTORY	STOREFRONT SYSTEM, AUTO OPENER, ACCESSIBLE DOORS
209B	6' - 0"	8' - 0"	H	ALUM / GLS	FACTORY	ALUM	FACTORY	STOREFRONT SYSTEM
209C	6' - 0"	8' - 0"	H	ALUM / GLS	FACTORY	ALUM	FACTORY	STOREFRONT SYSTEM
209D	6' - 0"	8' - 0"	Н	ALUM / GLS	FACTORY	ALUM	FACTORY	STOREFRONT SYSTEM, AUTO OPENER, ACCESSIBLE DOORS
347A	6' - 0"	7' - 9 1/2"	Н	ALUM / GLS	FACTORY	ALUM	FACTORY	STOREFRONT SYSTEM, AUTO OPENER, ACCESSIBLE DOORS
347B	3' - 0"	7' - 9 1/2"	D	ALUM / GLS	FACTORY	ALUM	FACTORY	STOREFRONT SYSTEM
347C	3' - 0"	7' - 9 1/2"	D	ALUM / GLS	FACTORY	ALUM	FACTORY	STOREFRONT SYSTEM
347D	3' - 0"	7' - 9 1/2"	D	ALUM / GLS	FACTORY	ALUM	FACTORY	STOREFRONT SYSTEM
347E	3' - 0"	7' - 9 1/2"	D	ALUM / GLS	FACTORY	ALUM	FACTORY	STOREFRONT SYSTEM
347F	3' - 0"	7' - 9 1/2"	D	ALUM / GLS	FACTORY	ALUM	FACTORY	STOREFRONT SYSTEM
347G	3' - 0"	7' - 9 1/2"	D	ALUM / GLS	FACTORY	ALUM	FACTORY	STOREFRONT SYSTEM
347H	3' - 0"	7' - 9 1/2"	D	ALUM / GLS	FACTORY	ALUM	FACTORY	STOREFRONT SYSTEM
347J	3' - 0"	7' - 9 1/2"	D	ALUM / GLS	FACTORY	ALUM	FACTORY	STOREFRONT SYSTEM
347K	6' - 0"	7' - 9 1/2"	Н	ALUM / GLS	FACTORY	ALUM	FACTORY	STOREFRONT SYSTEM, AUTO OPENER, ACCESSIBLE DOORS
461A	3' - 0"	8' - 0"	D	ALUM / GLS	FACTORY	ALUM	FACTORY	STOREFRONT SYSTEM
461B	6' - 0"	8' - 0"	Н	ALUM / GLS	FACTORY	ALUM	FACTORY	STOREFRONT SYSTEM
461C	3' - 0"	8' - 0"	D	ALUM / GLS	FACTORY	ALUM	FACTORY	STOREFRONT SYSTEM
461D	3' - 0"	8' - 0"	D	ALUM / GLS	FACTORY	ALUM	FACTORY	STOREFRONT SYSTEM
461E	6' - 0"	8' - 0"	Н	ALUM / GLS	FACTORY	ALUM	FACTORY	STOREFRONT SYSTEM
461F	3' - 0"	8' - 0"	D	ALUM / GLS	FACTORY	ALUM	FACTORY	STOREFRONT SYSTEM

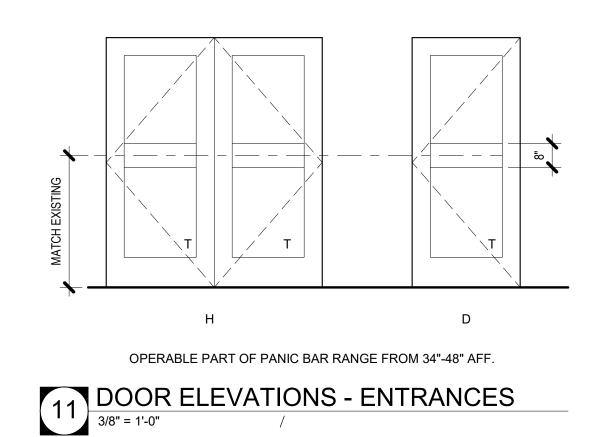


SHEET NOTES - DOORS 1. ALL HARDWARE SHALL CONFORM TO APPLICABLE PROVISIONS OF ICC A117.1, ACCESSIBLE AND USABLE BUILDINGS AND FACILITIES. 2. KEYING CRITERIA WILL BE ESTABLISHED BY THE OWNER AFTER BID. ALLOW FOR INDIVIDUAL LOCK KEYING AND MULTIPLE MASTERS AND SUBMASTERS. THE HARDWARE CONTRACTOR SHALL PREPARE A SEPARATE KEYING SCHEDULE BASED UPON THE OWNERS CRITERIA. 3. PROVIDE NON REMOVABLE PINS AT ALL DOOR HINGES WHERE THE HINGE IS EXPOSED TO THE LOCK SIDE OF THE 4. DOORS SHALL NOT BE LOCKABLE IN THE DIRECTION OF 5. PROVIDE UL LISTED HARDWARE AT ALL FIRE RATED 6. IN GENERAL DOOR CLOSERS SHALL BE LOCATED ON THE ROOM SIDE OF THE DOOR. PROVIDE REGULAR OR PARALLEL ARMS AS NECESSARY. 7. PROVIDE HOLLOW METAL ASTRAGALS AT DOOR PAIRS WHERE REQUIRED TO ACHIEVE SPECIFIED UL LABEL. 8. THE CONTRACTOR SHALL COORDINATE THE VARIOUS HARDWARE COMPONENTS FOR EACH DOOR AND MAKE NECESSARY MODIFICATIONS TO PROVIDE FOR A FULLY FUNCTIONING DOOR OPERATION. 9. PROVIDE SEALANT AT JUNCTION OF ALL FRAMES AND 10. WIDTH OF HOLLOW METAL FRAMES ARE ACTUAL PARTITION THICKNESS PLUS 1 INCH, EXCEPT FOR CMU PARTITIONS. PARTITION TYPES ARE KEYED ON FLOOR 11. PROVIDE SPECIFIED FRAME ANCHORS LISTED IN THE SPECIFICATIONS TO ACCOMMODATE PARTITION TYPES AND REQUIREMENTS FOR FIRE RATINGS. 12. AT GYPSUM BOARD PARTITIONS PROVIDE DOUBLE METAL STUDS AT ALL DOOR OR BORROWED LITE JAMBS. 13. PAINT ALL HOLLOW METAL DOORS UNLESS NOTED 14. MAXIMUM DOOR OPERATING PRESSURES ARE 5 LBS. FOR INTERIOR DOORS AND 8 LBS. FOR EXTERIOR DOORS. 15. ALL RATED DOORS SHALL BE SELF CLOSING. 16. PROVIDE THRESHOLD AND WEATHERSTRIPPING AT ALL EXTERIOR DOORS, WHETHER SCHEDULED OR NOT. 17. 90 MINUTE DOORS SHALL HAVE A MAXIMUM VISION LITE OF 100 SQUARE INCHES.

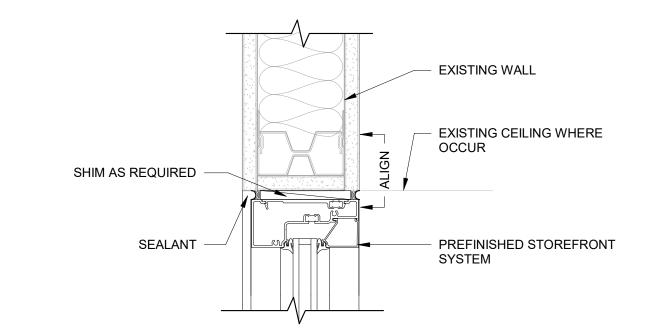


TYPICAL STOREFRONT WINDOW HEAD @ GYP BD 3" = 1'-0"

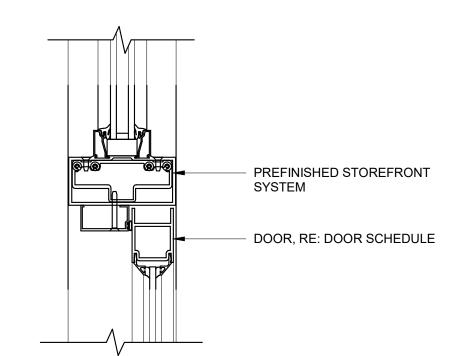


7 TYPICAL STOREFRONT DOOR HEAD WITH TRANSOM

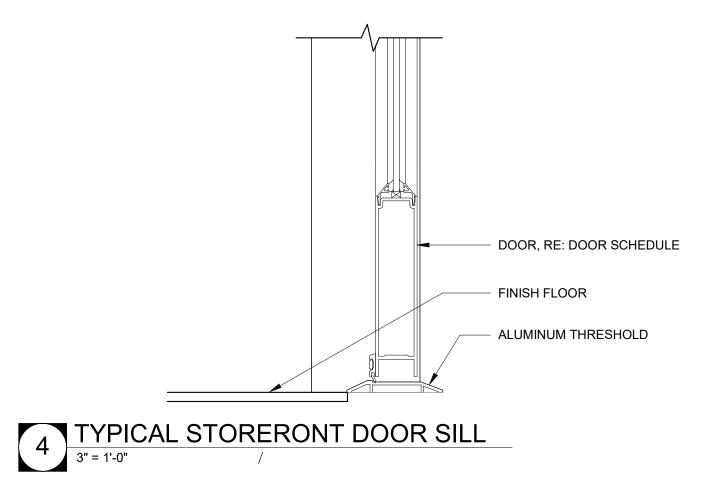

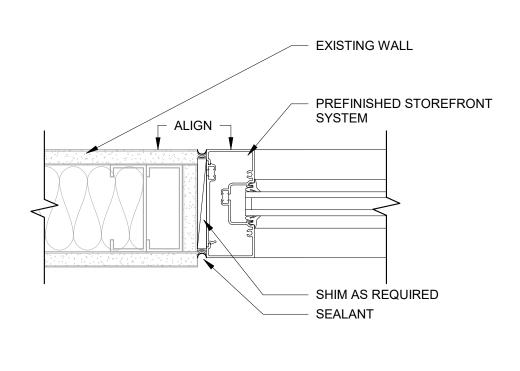


3 TYPICAL STOREFRONT WINDOW JAMB @ GYP BD

/

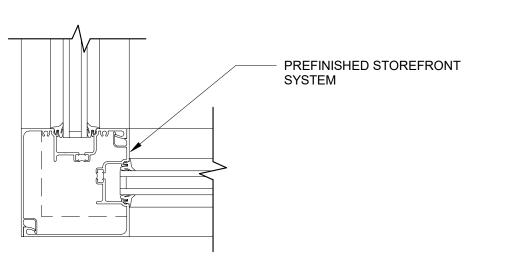


9 TYPICAL STOREFRONT MULLION CORNER JAMB

3" = 1'-0"

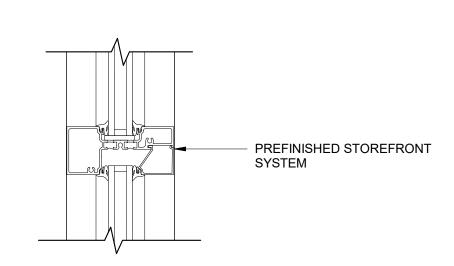


6 TYPICAL STOREFRONT HORIZONTAL MULLION

/

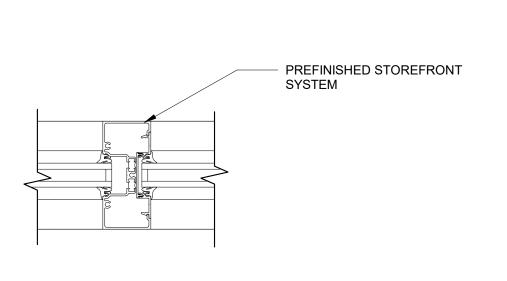


TYPICAL STOREFRONT VERTICAL MULLION


3" = 1'-0"

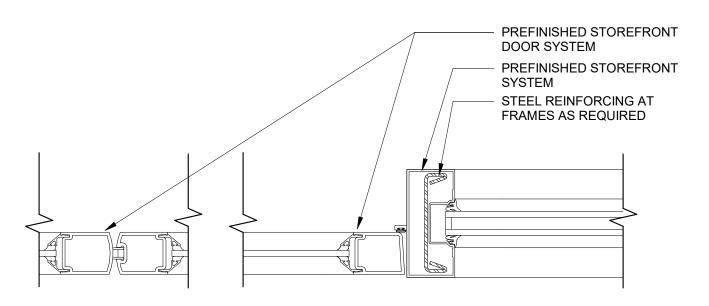


8 TYPICAL STOREFRONT DOOR JAMB/SIDELIGHT
/

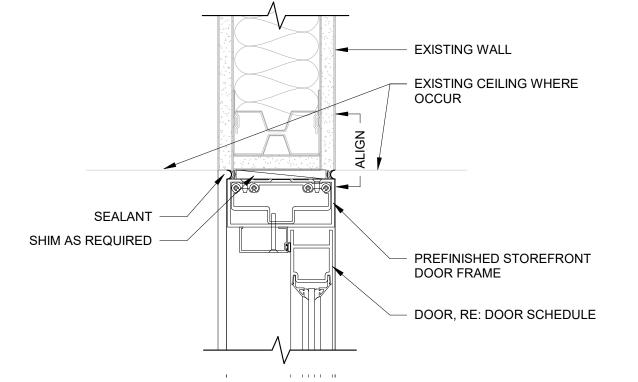

5 TYPICAL STOREFRONT DOOR HEAD @ GYP BD

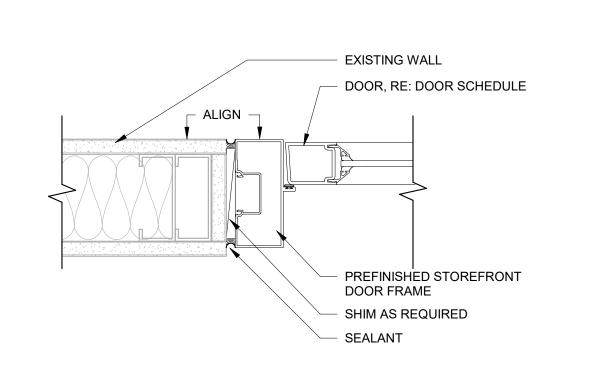

TYPICAL STOREFRONT DOOR JAMB @ GYP BD
3" = 1'-0"

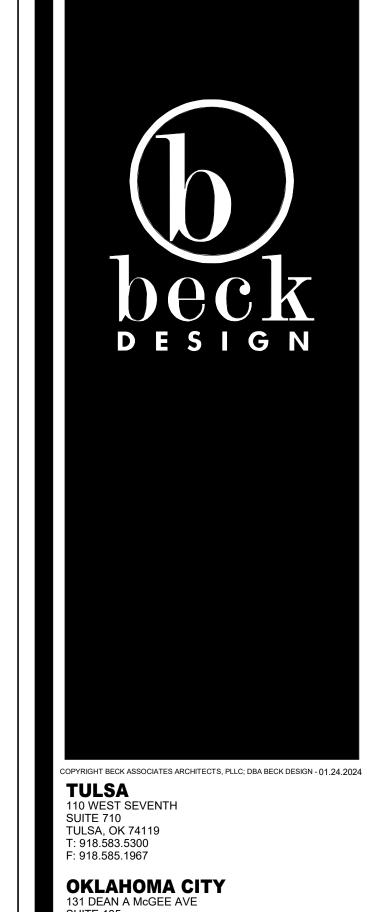

PROJECT:
PROJECT #
SP 23-2
TULSA
PERFORMING
ARTS CENTER -

PACKAGE No. 1


AND No. 2


SUITE 135

OKLAHOMA CITY, OK 73102 T: 405.232.7007

PROJECT NUMBER: **202331.00**

CONSULTANT:

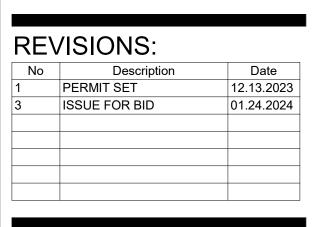

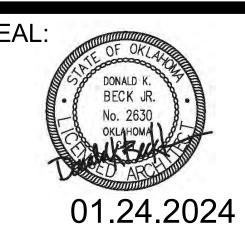



ISSUE DATE: **01.24.2024**

SHEET NUMBER:

A801

DOOR SCHEDULE, DOOR ELEVATIONS, DOOR FRAME ELEVATIONS

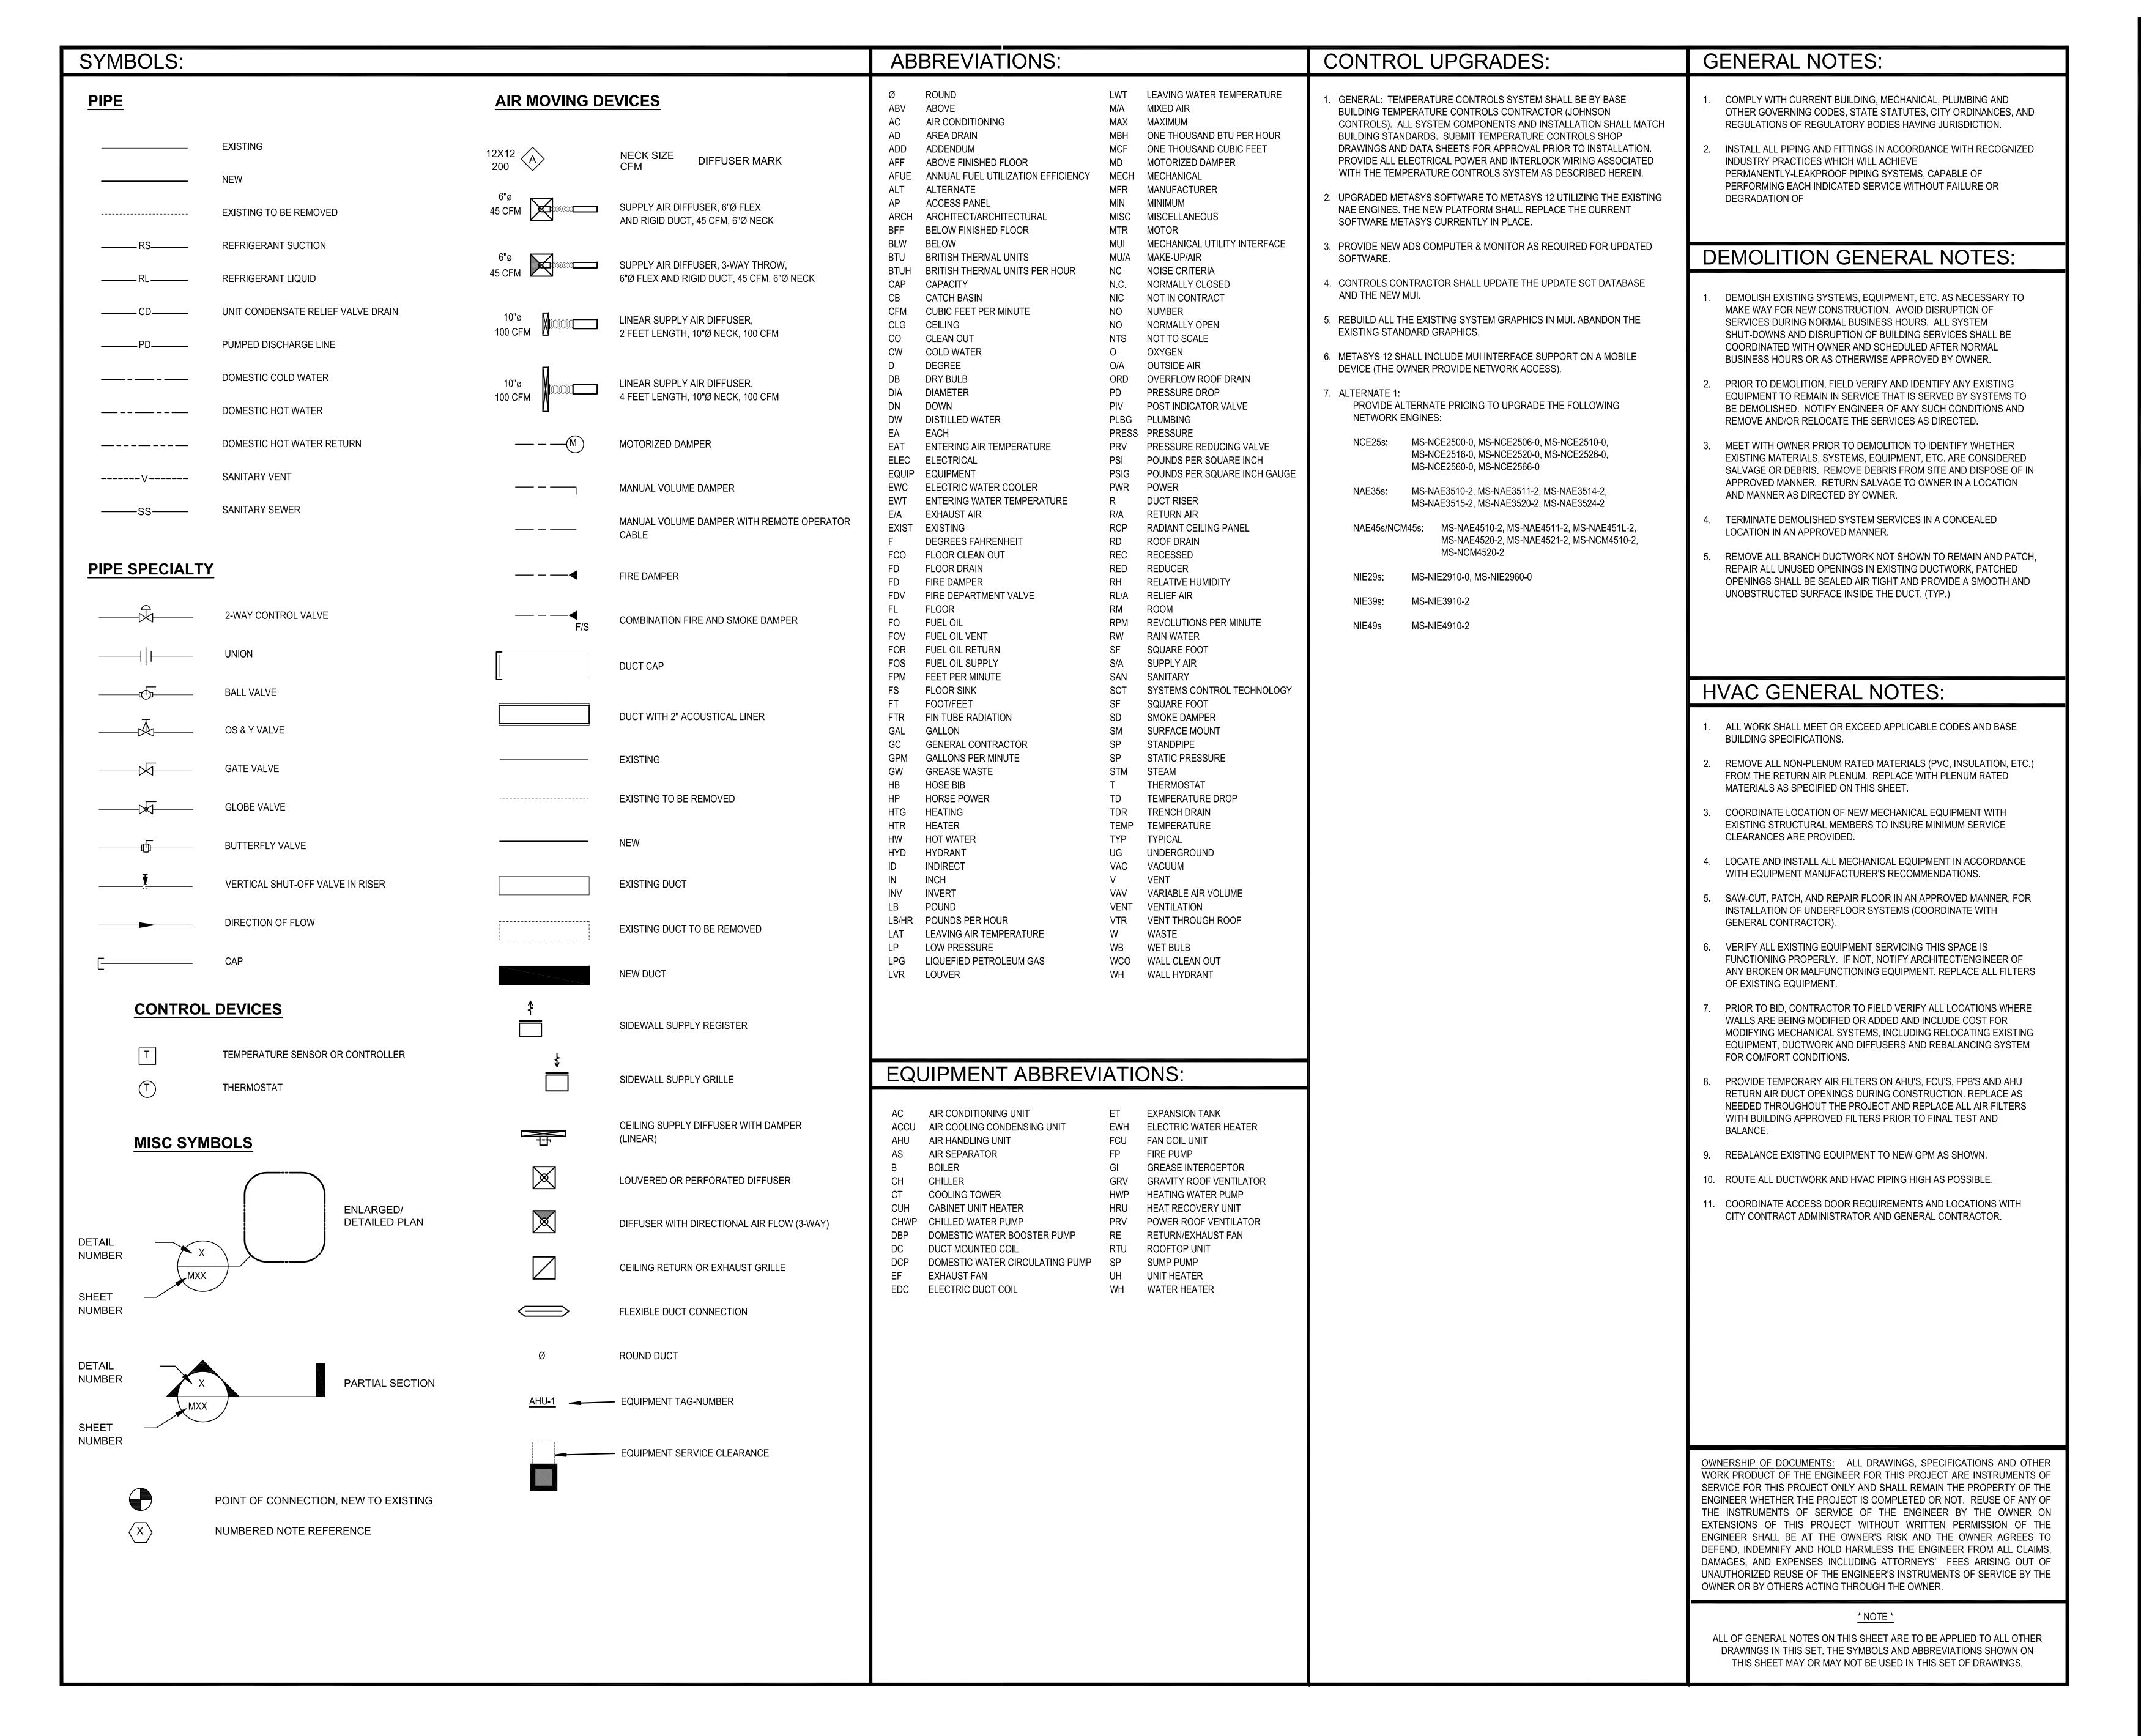

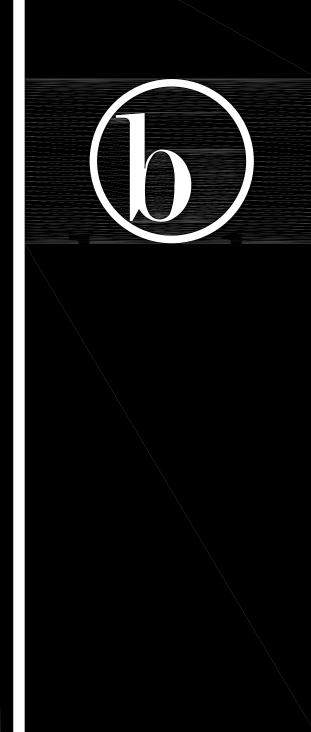

COPYRIGHT BECK ASSOCIATES ARCHITECTS, PLLC; DBA BECK DESIGN 12.19.2023

TULSA
110 WEST SEVENTH

SUITE 710 TULSA, OK 74119 T: 918.583.5300 F: 918.585.1967

OKLAHOMA CITY

OKLAHOMA CITY, OK 73102 T: 405.232.7007

PROJECT:
PROJECT #
SP 23-2
TULSA
PERFORMING
ARTS CENTER PACKAGE No. 2
MECH., AV AND
THEATRICAL
LIGHTING
UPGRADES

PROJECT NUMBER: **202331.00**

CONSULTANT:
PHILLIPS+GOMEZ
MEP CONSULTING ENGINEERS

Phillips + Gomez

15 W 6th Street, Suite 2510 Tulsa, Oklahoma 74119 Telephone: 918-584-0102 Fax: 918-582-2819

REVISIONS:

No Description Date

Oklahoma Certificate of Authority (Engineers) - #CA1395

SEAL:




ISSUE DATE: **01.24.2024**


SHEET NUMBER:

M001

MECHANICAL NOTES LEGEND, AND SYMBOLS

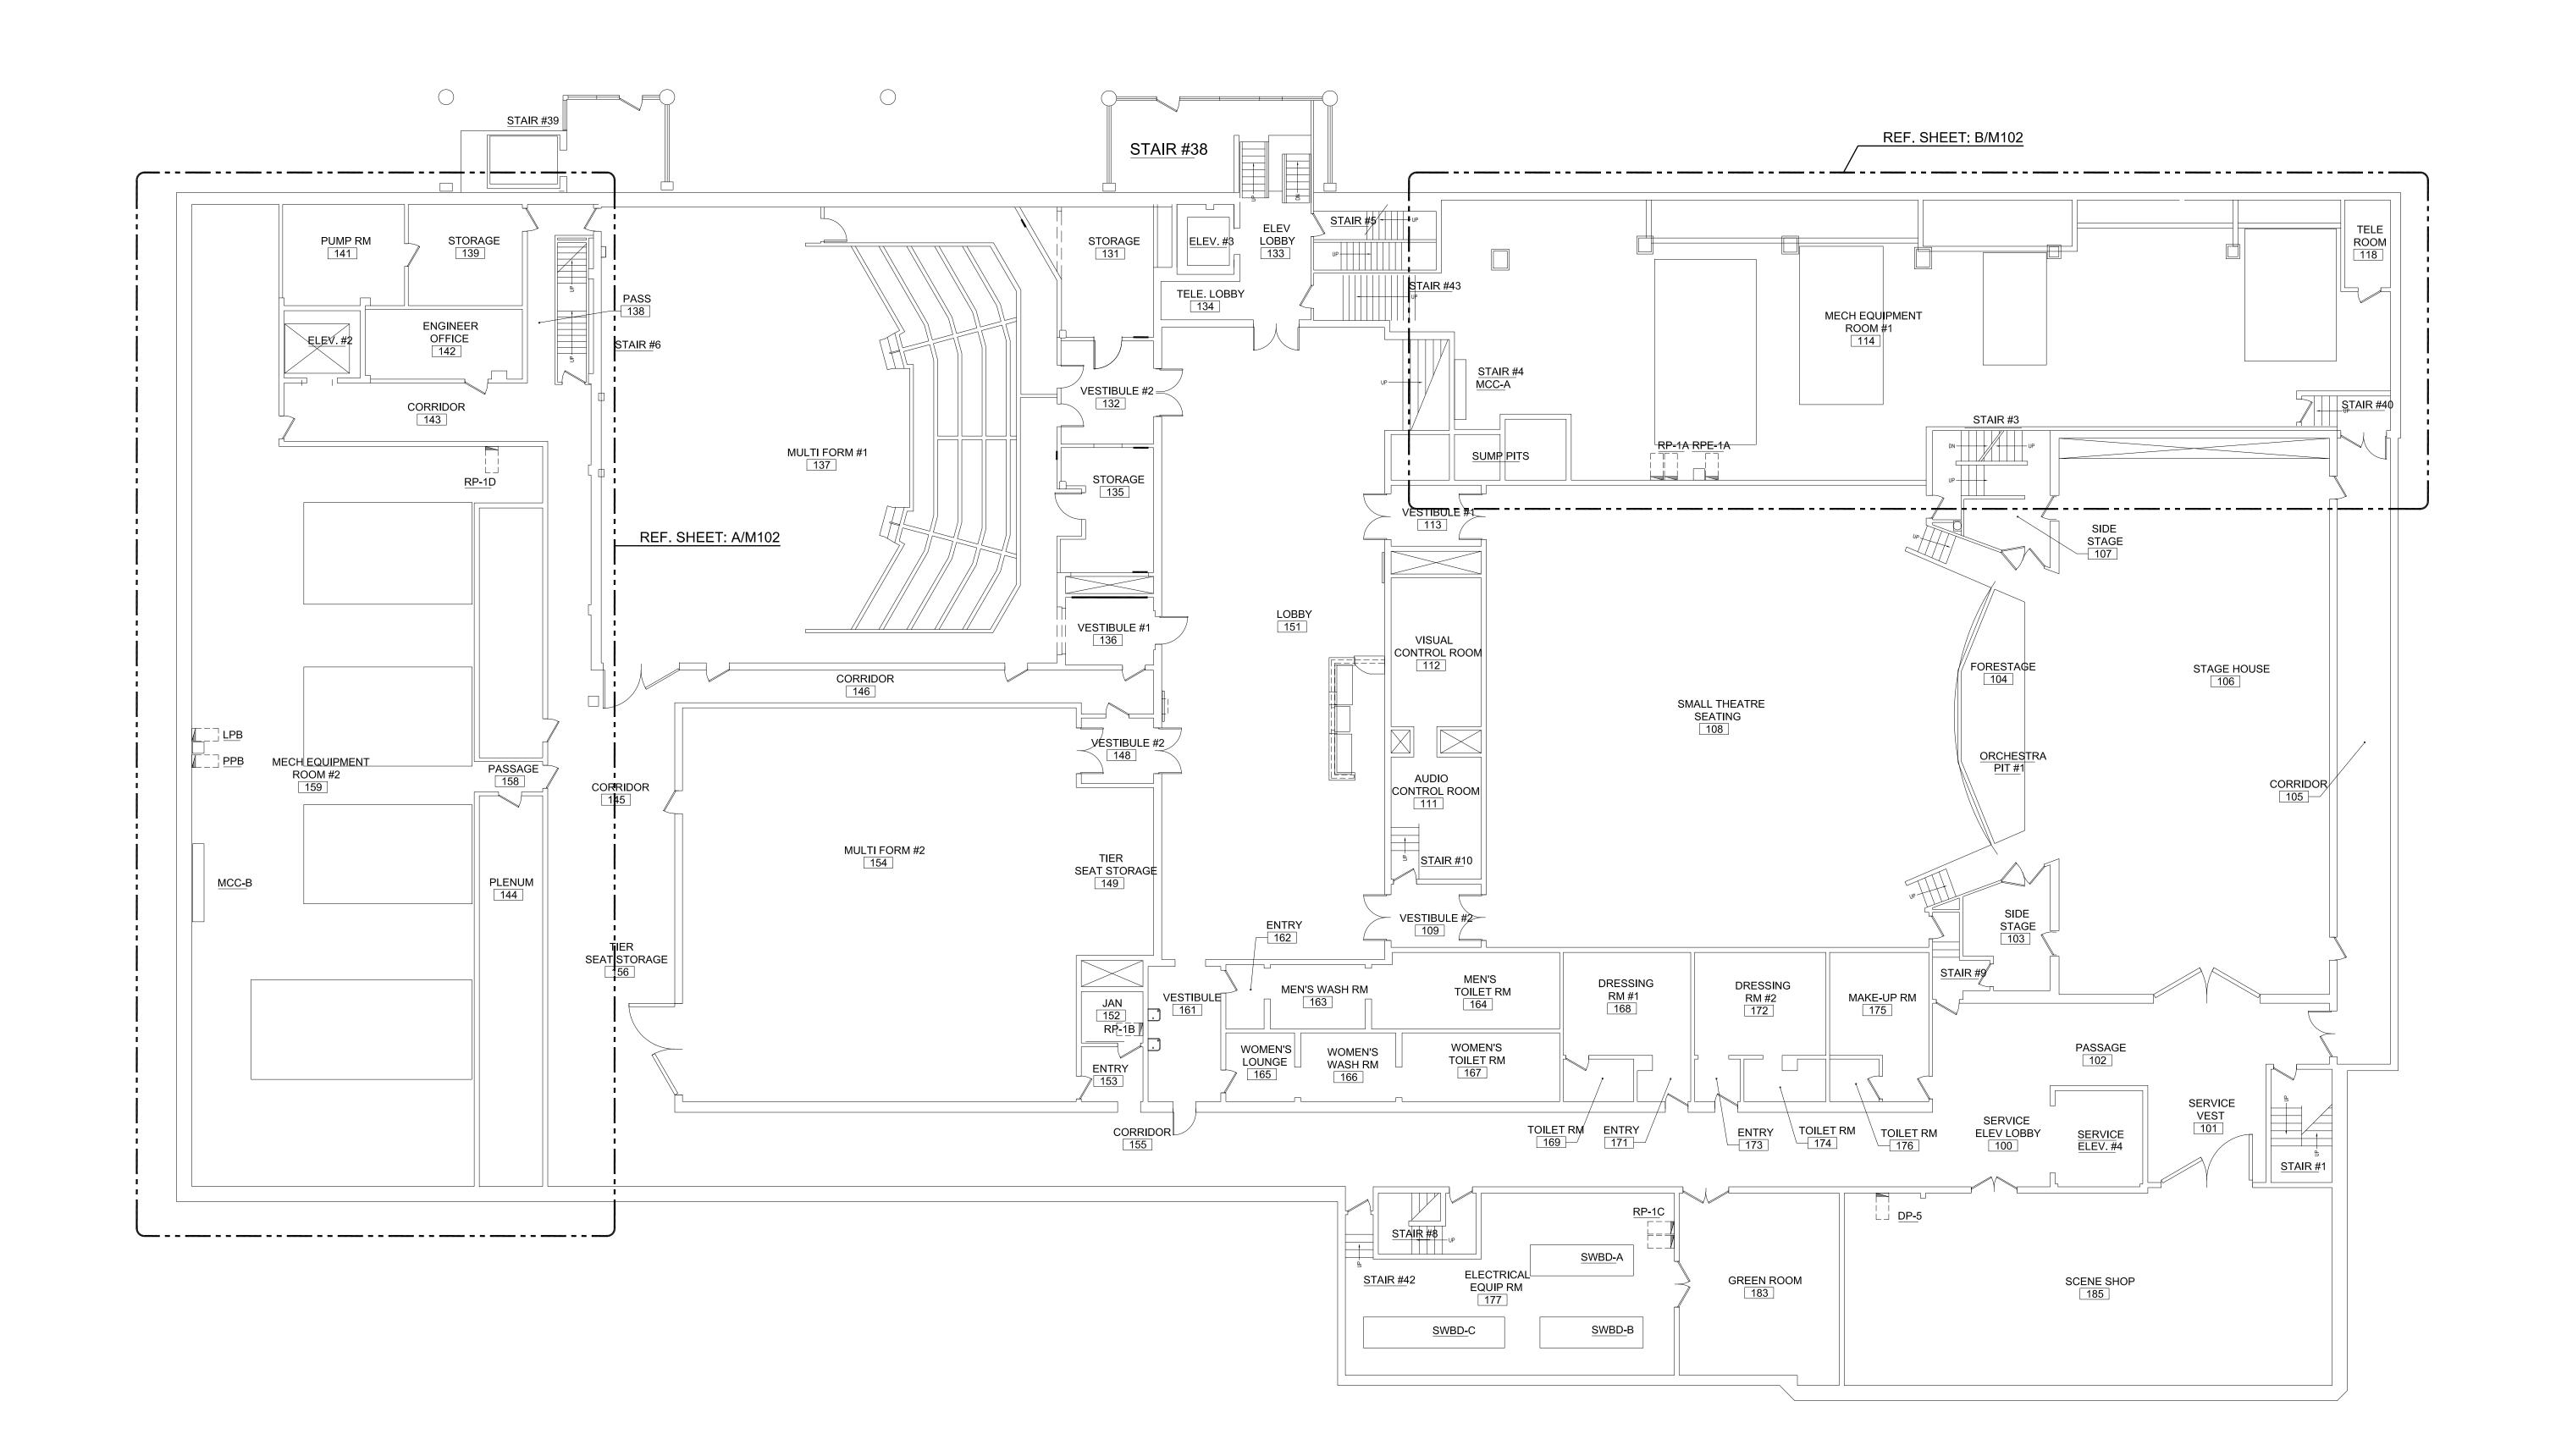



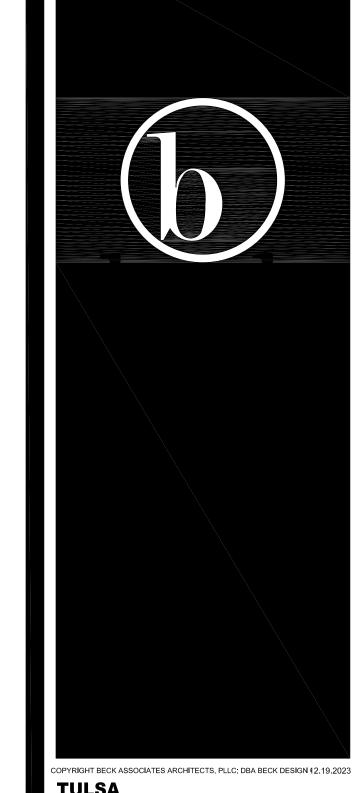

TULSA
110 WEST SEVENTH
SUITE 710
TULSA, OK 74119
T: 918.583.5300

OKLAHOMA CITY

131 DEAN A McGEE AVE

F: 918.585.1967

131 DEAN A McGEE AVE SUITE 135 OKLAHOMA CITY, OK 73102 T: 405.232.7007

PROJECT:
PROJECT #
SP 23-2
TULSA
PERFORMING
ARTS CENTER PACKAGE No. 2
MECH., AV AND
THEATRICAL
LIGHTING
UPGRADES

PROJECT NUMBER: **202331.00**

CONSULTANT:
PHILLIPS+GOMEZ
MEP CONSULTING ENGINEERS
15 W 6th Street, Suite 2510
Tulsa, Oklahoma 74119
Telephone: 918-584-0102
Fax: 918-582-2819

Phillips + Gomez
Oklahoma Certificate of Authority (Engineers) - #CA1395

REV	ISIONS:	
No	Description	Date
I		
I ——		

SEAL:




ISSUE DATE: **01.24.2024**

SHEET NUMBER:

M101

LEVEL 1 - OVERALL MECHANICAL FLOOR PLAN

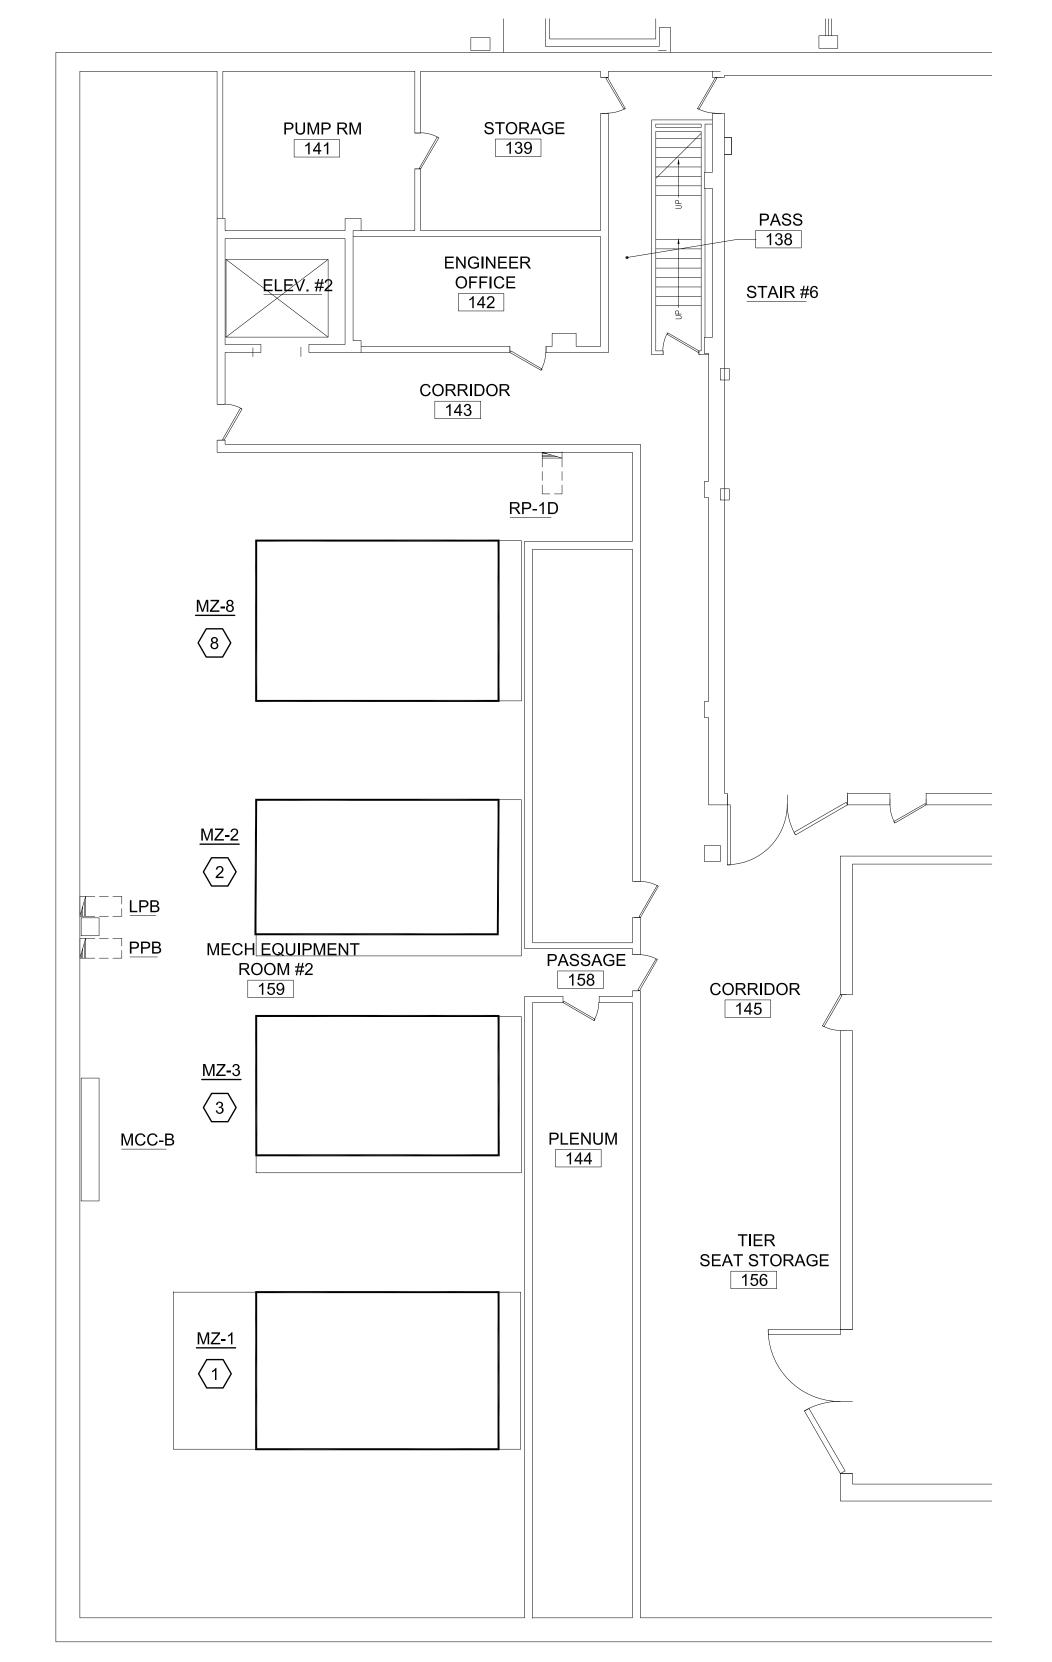


HVAC NUMBERED NOTES:

- 1. REPLACE EXISTING PNEUMATIC OPERATED CHILLED WATER CONTROL VALVE WITH NEW ELECTRIC ACTUATED CONTROL VALVE. (5" VALVE BODY WITH 237 CV, 339 GPM, FAIL CLOSE)
- 2. REPLACE EXISTING PNEUMATIC OPERATED CHILLED WATER CONTROL VALVE WITH NEW ELECTRIC ACTUATED CONTROL VALVE. (5" VALVE BODY WITH 237 CV, 306 GPM, FAIL CLOSE)
- 3. REPLACE EXISTING PNEUMATIC OPERATED CHILLED WATER CONTROL VALVE WITH NEW ELECTRIC ACTUATED CONTROL VALVE. (5" VALVE BODY WITH 237 CV, 306 GPM, FAIL CLOSE)
- 4. REPLACE EXISTING PNEUMATIC OPERATED CHILLED WATER CONTROL VALVE WITH NEW ELECTRIC ACTUATED CONTROL VALVE. (5" VALVE BODY WITH 237 CV, 305 GPM, FAIL CLOSE)
- 5. REPLACE EXISTING PNEUMATIC OPERATED CHILLED WATER CONTROL VALVE WITH NEW ELECTRIC ACTUATED CONTROL VALVE. (3" VALVE BODY WITH 83 CV, 152 GPM, FAIL CLOSE)
- 6. REPLACE EXISTING PNEUMATIC OPERATED CHILLED WATER CONTROL VALVE WITH NEW ELECTRIC ACTUATED CONTROL VALVE. (3" VALVE BODY WITH 83 CV, 122 GPM, FAIL CLOSE)
- 7. NOT USED
- 8. REPLACE EXISTING PNEUMATIC OPERATED CHILLED WATER CONTROL VALVE WITH NEW ELECTRIC ACTUATED CONTROL VALVE. (4" VALVE BODY WITH 150 CV, 173 GPM, FAIL CLOSE)






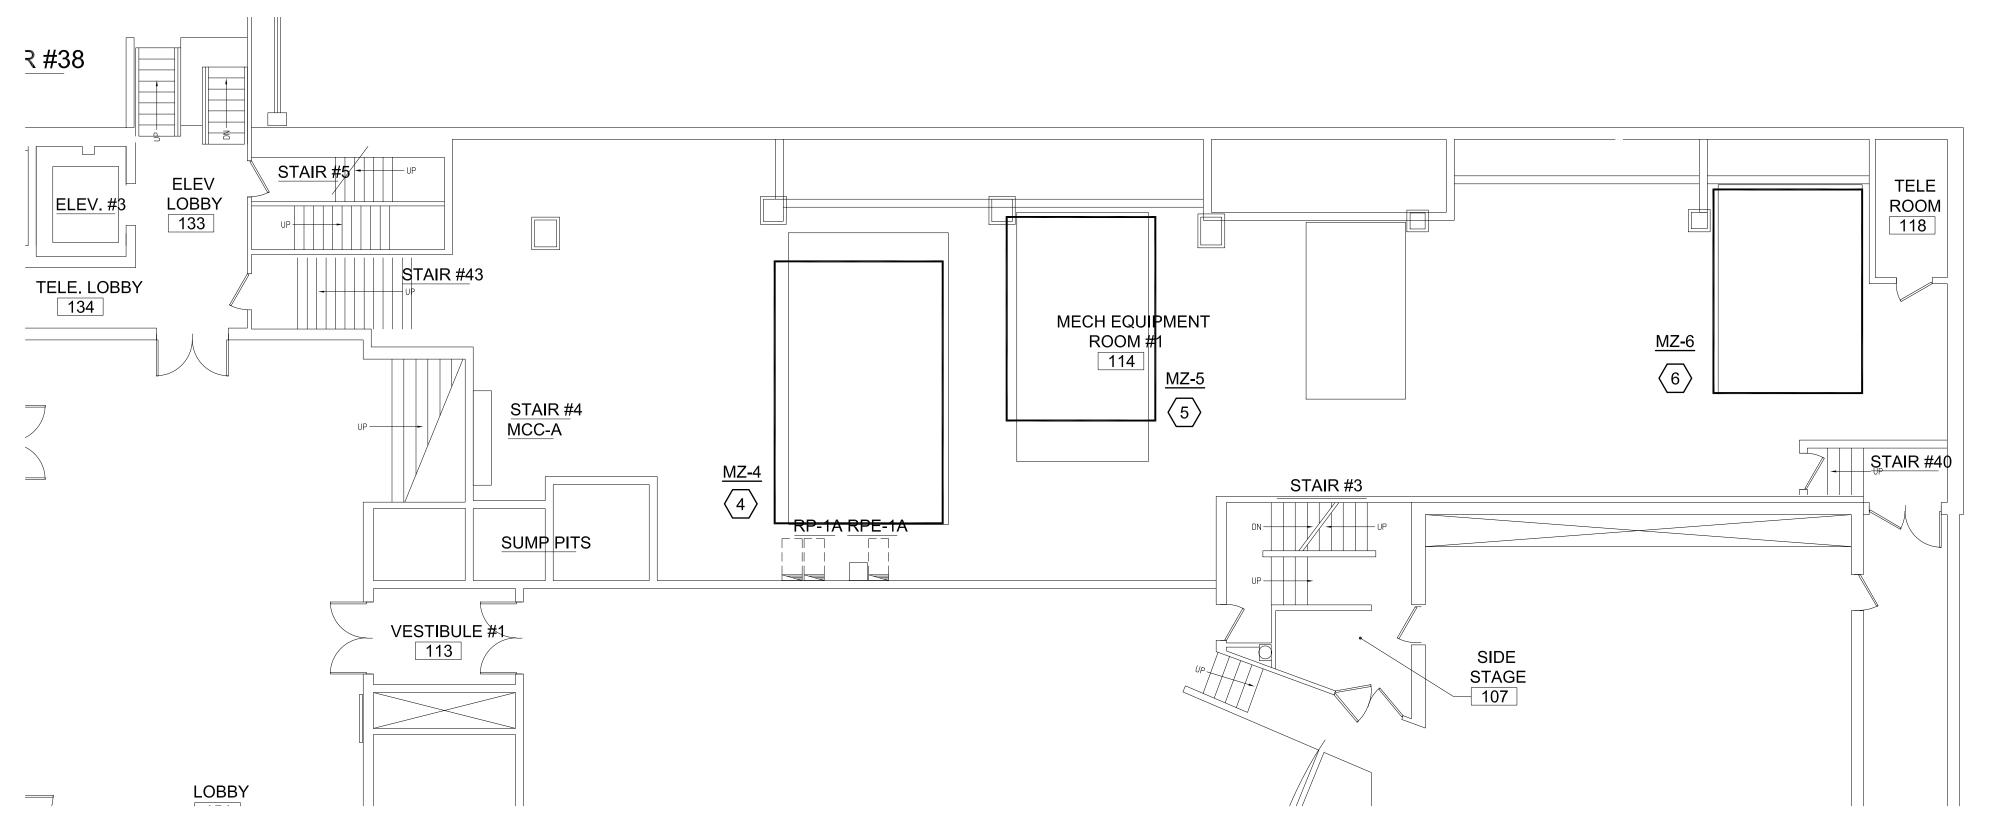





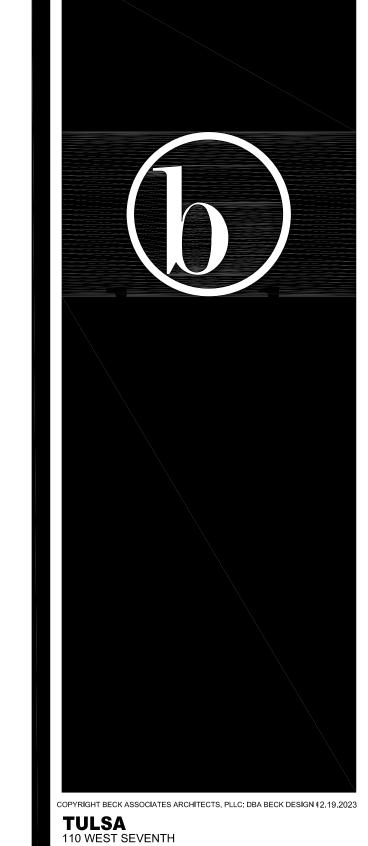

SUITE 710 TULSA, OK 74119

T: 918.583.5300

F: 918.585.1967 OKLAHOMA CITY

SUITE 135 OKLAHOMA CITY, OK 73102 T: 405.232.7007

PROJECT: PROJECT # SP 23-2 TULSA PERFORMING **ARTS CENTER -**PACKAGE No. 2 MECH., AV AND THEATRICAL

PROJECT NUMBER: 202331.00

CONSULTANT: PHILLIPS+GOMEZ
MEP CONSULTING ENGINEERS
15 W 6th Street, Suite 2510
Tulsa, Oklahoma 74119
Telephone: 918-584-0102
Fax: 918-582-2819

Phillips + Gomez Oklahoma Certificate of Authority (Engineers) - #CA1395

REV	ISIONS:	
No	Description	Date
		I

SEAL:



ISSUE DATE: 01.24.2024

SHEET NUMBER:

M102

LEVEL 1 - MECHANICAL **EQUIPMENT ROOM HVAC** FLOOR PLANS

ELECTRICAL SYMBOLS LIST DISCONNECT SWITCH, FUSED. DUPLEX CONVENIENCE OUTLET, +18" A.F.F. U.O.N., NUMBER DENOTES CIRCUIT, (EXAMPLE 3). DISCONNECT SWITCH, NON-FUSED. SIMPLEX CONVENIENCE OUTLET, +18" A.F.F. U.O.N., NUMBER COMBINATION STARTER, FUSED. DENOTES CIRCUIT, (EXAMPLE 2). COMBINATION STARTER, NON-FUSED. GFI DENOTES GROUND FAULT INTERRUPTER. MANUAL MOTOR STARTER WITH THERMAL OVERLOAD. WP DENOTES IN-USE WEATHERPROOF COVER. VARIABLE FREQUENCY CONTROLLER, PROVIDED BY ELECTRICAL IG DENOTES ISOLATED GROUND. ELECTRIC MOTOR, NIEC, MAKE CONNECTIONS ONLY. NUMBER SPECIAL RECEPTACLE OUTLET CONFIGURATION. DENOTES HORSEPOWER. (EXAMPLE: 2HP) DOUBLE DUPLEX RECEPTACLE OUTLET. PANELBOARD, SURFACE MOUNTED. WALL MOUNTED JUNCTION BOX FOR POWER SERVICE TO PANEL PANELBOARD, RECESSED MOUNTED. SYSTEM. NUMBER DENOTES CIRCUIT, EXAMPLE: 1) — — — CONDUIT RUN BELOW SLAB OR UNDERGROUND. JUNCTION BOX, NUMBER DENOTES CIRCUIT (EXAMPLE 1) — CONDUIT HOMERUN, CONTINUOUS RUN TO PANEL OR EQUIPMENT FLOOR MOUNTED OUTLET FOR POWER SERVICE, DATA SERVICE, AND CABINET. TELEPHONE SERVICE TO PANEL SYSTEM. PROVIDE FINAL CONNECTIONS TO PANEL SYSTEM. NUMBER DENOTES CIRCUIT CROSSMARKS ON BRANCH CIRCUIT CONDUIT RUNS INDICATE THE TYPICAL (EXAMPLE: 1). QUANTITY OF CONDUCTORS, EXCEPT NO CROSSMARKS INDICATE TWO #12 AWG CONDUCTORS. COMBINATION POWER/TELEPHONE/DATA FLOOR BOX SERVICE FITTING. LONG CROSSMARKS INDICATE PHASE CONDUCTORS AND SHORT POWER SERVICE FOR FLOOR BOX SERVICE FITTING. CROSSMARKS WITHOUT DESIGNATION ARE NEUTRAL CONDUCTORS. SV SHORT CROSSMARKS WITH "G" ARE SEPARATE EQUIPMENT TELEPHONE SERVICE FOR FLOOR BOX SERVING FITTING. INSTALL GROUNDING CONDUCTORS. DM TELEPHONE COVERPLATE IN SERVICE FITTING. ALL CONDUCTORS SHALL BE #12 AWG U.O.N. DATA CABLE SERVICE, +18" A.F.F U.O.N., PROVIDE PLASTER RING AND PULL STRING TO ACCESSIBLE CEILING SPACE. ALL PVC CONDUITS SHOULD HAVE SEPARATE GROUNDING CONDUCTOR. JUNCTION BOX WITH BLANK COVER PLATE +18" A.F.F U.O.N., PROVIDE PLASTER RING AND PULL STRING TO ACCESSIBLE CEILING FLEXIBLE METALLIC CONDUIT. SPACE EMERGENCY POWER OFF PUSHBUTTON WITH LIFT COVER +46" A.F.F. OUTLET FOR CABLE TV. +18" A.F.F. U.O.N. FURNISH AND INSTALL CONDUIT AND CABLE AS REQUIRED TO COMPLETE A FULLY OPERABLE SYSTEM. SINGLE POLE TOGGLE OR MOMENTARY CONTACT SWITCH, +46" A.F.F. U.O.N. "a" INDICATES FIXTURES SWITCHED. ALSO USED IN LOW COMBINATION TELEPHONE/DATA SERVICE, +18" A.F.F. U.O.N. VOLTAGE SWITCHING TO CONTROL REMOTE CONTACTOR OR IN DIRECT PROVIDE PLASTER RING AND PULL STRING TO ACCESSIBLE CEILING LINE VOLTAGE SWITCHING. SPACE THREE-WAY TOGGLE SWITCH, +46" A.F.F. U.O.N. TELEPHONE OUTLET, +18" A.F.F. U.O.N. PROVIDE PLASTER RING AND PULL STRING TO ACCESSIBLE CEILING SPACE. WALL BOX DIMMER SWITCH, +46" A.F.F. U.O.N. ✓ W TELEPHONE OUTLET. WALL MOUNTED +46" A.F.F. U.O.N. PROVIDE SOS WALL MOUNTED OCCUPANCY SENSOR WITH MANUAL OVER-RIDE PLASTER RING AND PULL STRING TO ACCESSIBLE CEILING SPACE. SWITCH. +46" A.F.F. U.O.N. FIRE ALARM CONTROL PANEL. CEILING MOUNTED OCCUPANCY SENSOR. ADA COMPLIANT FIRE ALARM MANUAL PULL STATION, +46" A.F.F. WALL MOUNTED OCCUPANCY SENSOR. U.O.N. INTERFACE TO BASE BUILDING FIRE ALARM SYSTEM. LED OR FLUORESCENT FIXTURE. LOWER CASE LETTER INDICATES ADA COMPLIANT STROBE LIGHT. MATCH BUILDING STANDARD. MOUNT CONTROLLING SWITCH. "a". UPPER CASE LETTER INDICATES FIXTURE BOTTOM OF DEVICE AT 80" A.F.F. INTERCONNECT TO BASE BUILDING TYPE, i.e. "B". NUMERAL INDICATES PANEL CIRCUIT NUMBER, i.e. FIRE ALARM SYSTEM. PROVIDE POWER SUPPLIES AS REQUIRED. "3". SWITCH, FIXTURE TYPE, AND CIRCUIT NUMBERS ARE TYPICAL FOR ALL LIGHTING FIXTURES. WHERE TWO SWITCHING DESIGNATIONS ADA COMPLIANT STROBE LIGHT WITH AUDIBLE ALARM. MATCH ARE SHOWN CIRCUIT ONE LAMP OF TWO LAMP FIXTURES AND OUTER BUILDING STANDARD. MOUNT BOTTOM OF DEVICE AT 80" A.F.F. LAMPS OF 3 AND 4 LAMP FIXTURES TO THE FIRST SWITCHING INTERCONNECT TO BASE BUILDING FIRE ALARM SYSTEM. PROVIDE DESIGNATION SHOWN. AND THE REMAINING LAMP(S) TO THE SECOND POWER SUPPLIES AS REQUIRED. GND DESIGNATION SHOWN. ADA COMPLIANT CEILING MOUNTED STROBE LIGHT. MATCH BUILDING LED OR FLUORESCENT STRIP FIXTURE. STANDARD. INTERCONNECT TO BASE BUILDING FIRE ALARM SYSTEM. PROVIDE POWER SUPPLIES AS REQUIRED. LED, INCANDESCENT, FLUORESCENT OR H. I. D. FIXTURE. ADA COMPLIANT CEILING MOUNTED STROBE LIGHT WITH AUDIBLE LED, INCANDESCENT, FLUORESCENT OR H. I. D. FIXTURE, WALL ALARM. MATCH BUILDING STANDARD. INTERCONNECT TO BASE BUILDING FIRE ALARM SYSTEM. PROVIDE POWER SUPPLIES AS LED, INCANDESCENT, FLUORESCENT OR H. I. D. SCONCE. ADA COMPLIANT FIRE ALARM VOICE ALARM SPEAKER. INTERFACE LED, INCANDESCENT, FLUORESCENT OR H. I. D. WALL WASHER. WITH FIRE ALARM SYSTEM. WALL MOUNTED EGRESS FIXTURE. ADA COMPLIANT SMOKE DETECTOR, INTERCONNECT TO BASE BUILDING FIRE ALARM SYSTEM. CEILING MOUNTED EGRESS FIXTURE. ADA COMPLIANT SMOKE DETECTOR, DUCT MOUNTED, SINGLE FACE EXIT FIXTURE, CEILING OR WALL MOUNTED, PROVIDE INTERCONNECT TO BASE BUILDING FIRE ALARM SYSTEM. DETECTOR DIRECTIONAL ARROW IF SHOWN. BRACKET DENOTES WALL MOUNTING. TO SHUTDOWN ASSOCIATED HVAC UNIT UPON ALARM. MOUNT FIXTURE FACE PARALLEL TO ADJACENT DOOR WHERE APPLICABLE. ADA COMPLIANT FIRE ALARM HORN, RECESSED, INTERCONNECT TO

DOUBLE FACE EXIT FIXTURE, CEILING OR WALL MOUNTED, PROVIDE

MOUNTING. MOUNT FIXTURE FACE PERPENDICULAR TO ADJACENT

NUMBERED NOTE: REFER TO SHEET CONTAINING NUMBERED NOTES.

DIRECTIONAL ARROWS AS SHOWN. BRACKET DENOTES WALL

DOOR WHERE APPLICABLE.

BASE BUILDING FIRE ALARM SYSTEM.

FIRE SYSTEM.

ALARM SYSTEM.

ALARM SYSTEM.

FIREMAN'S COMMUNICATION JACK.

SOUND SYSTEM PAGING SPEAKER.

ADA COMPLIANT CARBON MONOXIDE DETECTOR. MOUNT AT LEAST

SPRINKLER SYSTEM FLOW SWITCH. INTERCONNECT TO BASE BUILDING

VALVE POSITION INDICATOR, INTERCONNECT TO BASE BUILDING FIRE

DOOR HOLD OPEN DEVICE, INTERCONNECT TO BASE BUILDING FIRE

SWITCH HEIGHT AND AT LEAST 6" FROM CEILING AND IN

ACCORDANCE WITH MANUFACTURERS RECOMMENDATIONS.


INTERCONNECT TO BASE BUILDING FIRE SYSTEM.

WIRELESS ACCESS POINT, FURNISHED AND INSTALLED BY OWNER. CABLING, TERMINATIONS, TESTING AND MAPPING BY THE CONTRACTOR. SECURITY CAMERAS, FURNISHED AND INSTALLED BY OWNER. CABLING, TERMINATIONS, TESTING AND MAPPING BY THE CONTRACTOR. DOOR STRIKE FOR SECURITY/ACCESS CONTROL. CABLING, TERMINATIONS. TESTING AND MAPPING BY THE CONTRACTOR. BREAK GLASS DEVICE, CEILING MOUNTED FOR SECURITY/ACCESS CONTRACTOR. AUDIO/VISUAL DEVICE, WALL MOUNTED

- CONTROL. CABLING, TERMINATIONS, TESTING AND MAPPING BY THE
- TELEPHONE / POWER POLE
- MICROPHONE OUTLET, 18" A.F.F. U.O.N., PROVIDE PLASTER RING AND PULL STRING TO ACCESSIBLE CEILING SPACE.
- CEILING OR WALL MOUNTED PHOTOCELL.
- RECESSED CLOCK OUTLET, +80" A.F.F. U.O.N., NUMBER DENOTES CIRCUIT (EXAMPLE 1).
- CARD READER, +46" A.F.F U.O.N.
- SOLENOID VALVE.
- DOOR POSITION MONITOR SWITCH.
- DOOR SWITCH, COORDINATE EXACT LOCATION WITH DOOR FRAMING.
- ELECTRIC DOOR LOCK, INTERCONNECT TO BASE BUILDING FIRE ALARM SYSTEM.
- HEAT DETECTOR, INTERCONNECT TO BASE BUILDING FIRE ALARM
- GAS SENSOR
- GAS HORN, RECESSED TYPE.
- LIQUID SENSOR LOCATED BELOW RAISED FLOOR.
- DOOR RELEASE PUSHBUTTON, +46" A.F.F. U.O.N.
- KEY PAD.
- KEY OVERRIDE.
- INTERCOM. +46" A.F.F. U.O.N.
- BACKGROUND MUSIC SPEAKER
- WALL MOUNTED PUSHBUTTON FOR INTERCOM, +46" A.F.F. U.O.N.
- INTERRUPTION CAPACITY
- AMPS
- VOLTS
- ISOLATED GROUND
- GROUND
- PHASE DESIGNATION (EXAMPLE 3 PHASE)
- NUMBER OF CONDUCTORS (EXAMPLE 3 WIRES)
- 3"C CONDUIT SIZE (EXAMPLE 3" CONDUIT)

ELECTRICAL DEMOLITION NOTES

- CONTRACTOR SHALL BE RESPONSIBLE FOR MAINTAINING EXISTING ELECTRICAL SERVICE TO ALL REMAINING AREAS OF THE FACILITY THROUGHOUT THE PROJECT EXCEPT DURING SCHEDULED SHUTDOWN TIMES. ANY SHUTDOWNS OF THE EXISTING FACILITY SHALL BE MUTUALLY AGREED UPON BY OWNER AND CONTRACTOR. CONTRACTOR SHALL GIVE OWNER MINIMUM OF TWO WEEKS NOTICE OF ANY SHUTDOWNS OF EXISTING FACILITY.
- CONTRACTOR SHALL SURVEY THE SITE TO CONFIRM FIELD CONDITIONS. THE CONTRACTOR IS RESPONSIBLE FOR FIELD VERIFYING THESE CONDITIONS.
- PRIOR TO REMOVAL OF ANY EXISTING WIRING OR CONDUIT, CONTRACTOR TO IDENTIFY POINT OF ORIGIN AND TERMINATION OF ANY EXITING TO REMAIN WIRING AND CONDUIT EFFECTED BY THIS SCOPE OF WORK. CONTRACTOR TO LABEL EXISTING TO REMAIN WIRING AND CONDUIT WITH WITH PANEL AND CIRCUIT NUMBER.
- 4. CONTRACTOR TO COORDINATE DEMOLITION WITH OWNER.
- CONTRACTOR SHALL COORDINATE WITH THE OWNER AS TO DISPOSITION OF ANY EXISTING SALVAGEABLE ELECTRICAL DEVICES, LIGHT FIXTURES, OR ELECTRICAL EQUIPMENT.
- 6. CONTRACTOR SHOULD NOT START ANY OF THE DEMOLITION UNTIL ALL EQUIPMENT AND DEVICES ARE REMOVED THAT THE OWNER WANTS TO SALVAGE.
- CONTRACTOR SHOULD NOT BEGIN REMOVAL OF ANY OF THE TELEPHONE, DATA OR FIRE ALARM SYSTEMS UNTIL:
- A. OWNER HAS REMOVED TELEPHONE OR DATA DEVICES.
- B. CONTRACTOR HAS COORDINATED WITH OWNER THE DISPOSITION OF ALL TELEPHONE, DATA AND FIRE ALARM EQUIPMENT.
- 8. REFER TO THE ARCHITECTURAL DEMOLITION PLANS AND DIVISION 1 SPECIFICATION FOR FURTHER
- CONTRACTOR COORDINATE THE REUSE OF ANY EXISTING OUTLET/SWITCH BOXES IN WALLS SCHEDULED TO REMAIN. REFER TO THE ARCHITECTURAL DEMOLITION DOCUMENTS. CONTRACTOR SHALL REMOVE BRANCH CIRCUIT WIRING TO NEAREST ACCESSIBLE JUNCTION BOX.
- 10. CONTRACTOR SHALL DIRECTLY SUPERVISE THE WORK FROM BEGINNING TO COMPLETION.
- 11. ALL EXISTING FLOOR OUTLETS SHALL BE REMOVED AND THE SLAB PENETRATION SHALL BE REPAIRED TO RESTORE ORIGINAL FIRE RESISTANCE AND STRUCTURAL INTEGRITY.

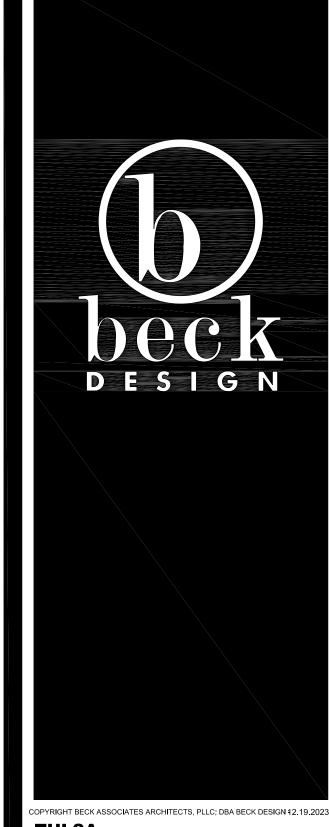

TULSA

TULSA, OK 74119 · 918 583 5300 918 585 1967

OKLAHOMA CITY SUITE 135 OKLAHOMA CITY, OK 73102

PROJECT: PROJECT #

SP 23-2 TULSA PERFORMING **ARTS CENTER -**PACKAGE No. 2 MECH., AV AND **THEATRICAL** LIGHTING

PROJECT NUMBER:

UPGRADES

202331.00

CONSULTANT: PHILLIPS+GOMEZ MEP CONSULTING ENGINEERS 15 W 6th Street, Suite 2510 Tulsa, Oklahoma 74119 Telephone: 918-584-0102

Fax: 918-582-2819

Phillips + Gomez Oklahoma Certificate of Authority (Engineers) - #CA1395

REV	ISIONS:	
No	Description	Date

SEAL:



ISSUE DATE: 01.24.2024

SHEET NUMBER:

IE001

ELECTRICAL SYMBOLS LIST AND DEMOLITION NOTES

ELECTRICAL GENERAL NOTES

1. COMBINATION OF HOMERUN CIRCUITS SHALL BE AS FOLLOWS:

D. MINIMUM BRANCH CIRCUIT CONDUCTOR SHALL BE #12AWG. THHN.

- A. ALL CIRCUITS WITH SEPARATE HOMERUN ARROWS SHALL BE INSTALLED IN DEDICATED CONDUITS. DO NOT COMBINE WITH OTHER BRANCH CIRCUITS.
- B. ALL BRANCH CIRCUITS LARGER THAN 20A SHALL BE SEPARATELY HOMERUN TO PANEL.
- C. A MAXIMUM OF SIX 20A BRANCH CIRCUIT PHASE CONDUCTORS IN COMMON HOMERUN.
- E. ALL 120V CIRCUITS SERVING NON-LIGHTING BRANCH CIRCUITS SHALL HAVE SEPARATE #12 AWG EQUIPMENT GROUNDING CONDUCTOR.
- 2. GROUNDING SYSTEM:
- A. GENERAL:
- 1. EXCEPT AS OTHERWISE NOTED, THE COMPLETE ELECTRICAL INSTALLATION, INCLUDING THE NEUTRAL CONDUCTOR, METALLIC CONDUITS AND RACEWAYS, BOXES, CABINETS, AND EQUIPMENT SHALL BE COMPLETELY AND EFFECTIVELY GROUNDED IN ACCORDANCE WITH ALL CODE REQUIREMENTS, WHETHER OR NOT SUCH CONNECTIONS ARE SPECIFICALLY SHOWN OR SPECIFIED.
- 2. RESISTANCE FROM GROUNDED SURFACE OF THE ELECTRICAL SYSTEM TO THE GROUND ELECTRODE AND TO EARTH SHALL NOT EXCEED 5 OHMS.
- B. DISTRIBUTION SYSTEM GROUNDING:
- 1. A BARE COPPER GROUND CONDUCTOR SHALL BE INSTALLED IN A NON-METALLIC CONDUIT OR DUCT; THIS CONDUCTOR IS NOT SHOWN ON THE DRAWINGS.
- C. BRANCH CIRCUIT GROUNDING:
- 1. ALL 120V CIRCUITS SERVING NON-LIGHTING BRANCH CIRCUITS SHALL HAVE SEPARATE GROUNDING CONDUCTORS.
- IDENTIFYING DEVICES:

NAMEPLATES: TYPE NP; ENGRAVED BLACK BAKELITE, 1" X 3 1/2" MINIMUM, WITH 1/2" HIGH WHITE LETTERS. MACHINE SCREW RETAINED. FOR PERMANENT IDENTIFICATION OF ALL SWITCHBOARDS, CIRCUIT BREAKERS IN SEPARATE ENCLOSURES, MOTOR STARTERS, RELAYS, TIME SWITCHES AND OTHER CABINET-ENCLOSED APPARATUS INCLUDING TERMINAL CABINETS. THIS APPLIES TO ALL NEW EQUIPMENT AND ANY EXISTING ELECTRICAL EQUIPMENT.

4. CUTTING, PAINTING, AND PATCHING:

STRUCTURAL MEMBERS OR FLOOR SHALL IN NO CASE BE DRILLED, BORED OR NOTCHED IN SUCH A MANNER THAT WILL IMPAIR THEIR STRUCTURAL VALUE. CUTTING OF HOLES, IF REQUIRED, SHALL BE DONE WITH CORE DRILL AND ONLY WITH THE APPROVAL OF THE OWNER REPRESENTATIVE.

SUPERVISION:

CONTRACTOR SHALL PERSONALLY OR THROUGH AN AUTHORIZED AND COMPETENT REPRESENTATIVE CONSTANTLY SUPERVISE THE WORK FROM BEGINNING TO COMPLETION AND WITHIN REASON, KEEP THE SAME WORKMEN AND FOREMAN ON THE PROJECT THROUGHOUT THE PROJECT DURATION.

- 6. PENETRATIONS:
- a. METAL SLEEVES: EXPOSED EXTERIOR CONDUIT RUNS PASSING THROUGH CONCRETE FLOORS OR WALLS. FOLLOWING CONDUIT INSTALLATION, SEAL ALL PENETRATIONS USING NON-IRON BEARING, CHLORIDE FREE, NON-SHRINKING, DRY-PACK GROUTING COMPOUND. CONDUITS PENETRATING EXTERIOR BUILDING WALLS AND BUILDING FLOOR SLAB SHALL BE RIGID STEEL.
- b. FIRE SEPARATION WALLS/FLOORS: PACK OPENING AROUND CONDUITS OR CABLES WITH FIRE 26. DRAWINGS SHOW FINAL LOCATION OF LIGHTING FIXTURES AND POWER OUTLETS. THEY DO BARRIER CAULK 3M CP 25 NELSON FLAMESEAL
- 7. ACCURACY:
- a. DRAWINGS FOR THE WORK UNDER THIS SECTION ARE DIAGRAMMATIC.
- b. CONTRACTOR SHALL VERIFY LINES, LEVELS AND DIMENSIONS SHOWN ON THE DRAWINGS AND SHALL BE RESPONSIBLE FOR THE ACCURACY OF THE SETTING OUT OF WORK AND FOR ITS STRICT CONFORMANCE WITH EXISTING CONDITIONS AT THE SITE.
- 8. LOCATIONS OF CONDUIT RUNS:

PLAN IN ADVANCE OF THE INSTALLATION AND COORDINATE WITH DUCTWORK, PLUMBING, CEILING AND WALL CONSTRUCTION IN THE SAME AREAS AND NOT NECESSARILY CROSS OTHER CONDUITS OR PIPE, NOR PREVENT REMOVAL OF CEILING TILES OR PANELS, NOR BLOCK ACCESS TO MECHANICAL OR ELECTRICAL EQUIPMENT.

- 9. WHERE PRACTICAL, INSTALL CONDUITS IN GROUPS IN PARALLEL, VERTICAL, OR HORIZONTAL RUNS AND AT ELEVATIONS THAT AVOID UNNECESSARY OFF-SETS.
- 10. PROTECTION OF EQUIPMENT:

KEEP CONDUITS, JUNCTION BOXES, OUTLET BOXES AND OTHER OPENINGS CLOSED TO PREVENT ENTRY OF FOREIGN MATTER. COVER FIXTURES, EQUIPMENT, DEVICES, AND APPARATUS TO PROTECT THEM AGAINST DIRT, PAINT, WATER, CHEMICAL OR MECHANICAL DAMAGE, BEFORE AND DURING CONSTRUCTION PERIOD. RESTORE TO ORIGINAL CONDITION ANY FIXTURE, APPARATUS OR EQUIPMENT DAMAGED PRIOR TO FINAL ACCEPTANCE. INCLUDE RESTORATION OF DAMAGED SHOP COATS OF PAINT BEFORE FINAL ACCEPTANCE. PROTECT BRIGHT FINISHED SURFACES AND SIMILAR ITEMS UNTIL IN SERVICE. NO RUST OR DAMAGE WILL BE PERMITTED.


11. MATERIALS AND WORK SHALL BE DONE ACCORDING TO BASE BUILDING STANDARDS AND PRACTICES.

- 12. WORK SHALL BE PERFORMED IN ACCORDANCE WITH ALL APPLICABLE REQUIREMENTS OF ALL GOVERNING CODES, RULES AND REGULATIONS, INCLUDING THE FOLLOWING MINIMUM STANDARDS, WHETHER STATUTORY OR NOT:
- NATIONAL ELECTRICAL CODE (NEC).
- 13. NATIONAL FIRE PROTECTION ASSOCIATION (NFPA).
- 14. INTERNATIONAL BUILDING CODE (IBC).
- 15. INTERNATIONAL MECHANICAL CODE (IMC)
- 16. AMERICAN DISABILITIES ACT (ADA)
- 17. BASE BUILDING SPECIFICATIONS
- 13. EQUIPMENT AND MATERIALS SPECIFIED UNDER THIS DIVISION SHALL CONFORM TO THE FOLLOWING STANDARDS WHERE APPLICABLE:
- UNDERWRITER'S LABORATORIES (UL).
- AMERICAN SOCIETY FOR TESTING MATERIALS (ASTM).
- CERTIFIED BALLAST MANUFACTURERS (CBM).
- 4. INSULATED POWER CABLE ENGINEERS ASSOCIATION (IPCEA). NATIONAL ELECTRICAL MANUFACTURERS ASSOCIATION (NEMA).
- AMERICAN NATIONAL STANDARDS INSTITUTE (ANSI).
- 7. ELECTRICAL TESTING LABORATORIES (ETL)
- 14. WHERE CEILING SPACE IS A RETURN AIR PLENUM. ALL WIRING IN CEILING SPACE MUST BE IN CONDUIT OR USE TEFLON JACKETED CABLE TO MEET RETURN AIR PLENUM REQUIREMENTS.
- 15. ALL BASE BUILDING 2X2 AND 2X4 RECESSED FLUORESCENT FIXTURES TO REMAIN SHALL HAVE THE LOUVER CLEANED AND RELAMPED. ALL ELECTRICAL DEVICES, 2X2 AND 2X4 FIXTURES SHALL BE BUILDING STANDARD U.O.N.
- 16. LIGHTING FIXTURES DESIGNATED AS "BUILDING STANDARD" MAY BE PURCHASED FROM OWNER STOCK (IF AVAILABLE) OR SHALL EXACTLY MATCH THE BUILDING STANDARD FIXTURES AS DEFINED BY THE OWNER.
- 17. CONTRACTOR TO LOCATE ALL LIGHTING FIXTURES PER ARCHITECTURAL REFLECTED CEILING PLANS.
- 18. ELECTRICAL CONTRACTOR TO COORDINATE THE MOUNTING HEIGHTS AND LOCATIONS OF ALL COMMUNICATION OUTLETS AND RECEPTACLES WITH ARCHITECTURAL DETAILS.
- 19. REFER TO ARCHITECTURAL DRAWINGS FOR EXACT LOCATION OF ALL FLOOR DEVICES. LOCATIONS SHALL BE IN ACCORDANCE WITH ALL UNDERWRITERS LABORATORIES AND LOCAL AUTHORITY REQUIREMENTS. IN NO CASE SHALL FIRE RATED POKE-THROUGH DEVICES BE INSTALLED LESS THAN 24" ON CENTER AND/OR MORE THAN ONE (1) PENETRATION PER 65 SQUARE FEET OF FLOOR AREA OF BEAM SPACE.
- 20. ALL EXISTING FLOOR OUTLETS WHICH ARE NOT USED FOR THIS IMPROVEMENT LEASE SHALL BE REMOVED AND THE SLAB PENETRATION SHALL BE REPAIRED TO RESTORE ORIGINAL FIRE RESISTANCE AND STRUCTURAL INTEGRITY.
- 21. IN AREAS WHERE COMMUNICATION OUTLETS ARE INSTALLED IN A WALL OF ROOM WITH GYPBOARD CEILING, CONTRACTOR SHALL INSTALL 3/4" CONDUIT FROM OUTLET TO ACCESSIBLE CEILING.
- 22. CONTRACTOR SHALL INSTALL A PULL STRING IN ALL EMPTY CONDUITS.
- SHOULD GANG DEVICES, PROVIDE AND INSTALL MULTI-GANG COVERPLATE.
- 24. SURFACE MOUNTED PANELS, DEVICES, AND RACEWAY WILL ONLY BE ALLOWED IN MECHANICAL AREAS U.O.N.
- 25. CONTRACTOR SHALL SURVEY SITE TO CONFIRM FIELD CONDITIONS SUCH AS LOCATION OF LIGHTING AND POWER JUNCTION BOXES, CONFIRM SPARE CIRCUITS IN PANELS, AND CONFIRM FIRE ALARM WIRING.
- NOT NECESSARILY SHOW ALL DEMOLITION OF ELECTRICAL DEVICES OR FIXTURES THAT SHOULD OCCUR. HOWEVER, ALTHOUGH NOT SPECIFICALLY SHOWN TO BE REMOVED, CONTRACTOR SHALL PERFORM NECESSARY DEMOLITION SUCH THAT THE FINAL ELECTRICAL SYSTEM REFLECTS THE LIGHTING AND POWER WHICH SHOWN ON THE PLAN DRAWINGS. THE CONTRACTOR IS RESPONSIBLE FOR FIELD VERIFYING THESE CONDITIONS.
- 27. THE SPACE ALLOCATION SHOWN ON THE PLAN DRAWINGS ARE BASED ON ONLY ONE MANUFACTURER. THE CONTRACTOR SHALL VERIFY THAT THE PROPOSED SWITCH GEAR (INCLUDING SWITCHBOARDS, PANELBOARDS AND TRANSFORMERS) WILL SATISFY THE SPACE 8. METERS REQUIREMENTS SHOWN ON THE DRAWINGS.
- 28. CONTRACTOR SHALL BE RESPONSIBLE FOR MAINTAINING EXISTING ELECTRICAL SERVICE TO ALL REMAINING AREAS OF THE FACILITY THROUGHOUT THE PROJECT EXCEPT DURING SCHEDULED SHUTDOWN TIMES.
- ANY SHUTDOWNS OF THE EXISTING FACILITY SHALL BE MUTUALLY AGREED UPON BY OWNER AND CONTRACTOR. CONTRACTOR SHALL GIVE OWNER MINIMUM OF TWO WEEKS NOTICE OF ANY SHUTDOWNS OF EXISTING FACILITY.
- 29. DURING BIDDING PROCESS, CONTRACTOR SHALL SURVEY EXISTING BUILDING SYSTEMS TO VERIFY EXTENT AND COMPATIBILITY WITH NEW ELECTRICAL SYSTEMS. CONTRACTOR SHALL INCLUDE MISCELLANEOUS DEVICES NECESSARY TO COMPLETE A FULL WORKING SYSTEM, FOR EXAMPLE MOTOR STARTER HEATERS AND STARTER EXHAUST CONTACTS.
- 30. ALL RECEPTACLES SHALL BE NEMA 5-20R U.O.N.
- 31. ALL 120V, 20 AMP HOME RUNS LONGER THAN 100' AND ALL 277V, 20 AMP HOME RUNS LONGER THAN 150' SHALL BE #10 MINIMUM.
- 32. FOLLOWING ADDITION OF NEW LOADS TO PANEL ON FLOOR FOR TENANT DEVELOPMENT, UPDATE PANEL SCHEDULE WITH SPACE AND LOAD ON TYPEWRITTEN CARD. MAKE COPY OF NEW PANEL SCHEDULE AND SUBMIT TO ENGINEER FOR APPROVAL FOLLOWING CONSTRUCTION COMPLETION.

- 33. FOLLOWING ADDITION AND TESTING OF EMERGENCY LIGHTING, UPDATE EMERGENCY LIGHTING PANEL SCHEDULE WITH FLOOR, SPACE AND LOAD. SUBMIT TEST RESULTS AND A COPY OF NEW PANEL SCHEDULE TO ENGINEER FOR APPROVAL FOLLOWING CONSTRUCTION COMPLETION.
- 34. TEST ALL NEW AND EXISTING FIRE ALARM DEVICES WITHIN THE TENANT SPACE, INCLUDING BUT NOT LIMITED TO. MANUAL PULL STATIONS, STROBES AND VOICE EVACUATION SPEAKERS AND SUBMIT TEST RESULTS TO ENGINEER FOR APPROVAL FOLLOWING CONSTRUCTION COMPLETION.
- 35. CONTRACTOR SHALL ALLOW A MAXIMUM OF 5% VOLTAGE DROP ON ALL EMERGENCY BRANCH CIRCUITS THROUGHOUT THE AREAS UNDER THIS CONTRACT. CONTRACTOR SHOULD SIZE THE EMERGENCY BRANCH CIRCUITS FEEDERS ACCORDINGLY TO MAINTAIN THE MAXIMUM VOLTAGE DROP AS LISTED ABOVE.
- 36. CONTRACTOR SHALL MAINTAIN MINIMUM SEPARATION OF 24" BETWEEN TELEPHONE CONDUIT AND PRIMARY CONDUIT.
- 37. THE CONTRACTOR SHALL FIELD VERIFY THE EXISTING CIRCUITS SERVING THE PRESENT LEASE SPACE AND THE EXISTING SPARE CIRCUITS IN THE PANELBOARDS SERVING THIS LEASE SPACE AND SHALL REPORT ANY FIELD CONDITIONS REQUIRING CIRCUITING DEVIATIONS IN WRITING TO THE ENGINEER FOR DIRECTION PRIOR TO PROCEEDING WITH CONSTRUCTION.
- 38. ALL EXISTING CONDUIT AND CONDUCTORS SERVING THE AREA UNDER CONTRACT NOT TO BE RE-USED SHALL BE TERMINATED AT LAST PORTION OF CIRCUIT REQUIRING ENERGIZATION BEFORE THE DEMOLITION AREA. IF A CIRCUIT SERVICES ONLY THE DEMOLITION AREA, REMOVE ALL CONDUITS AND CONDUCTORS BACK TO THE PANELBOARD AND DE-ENERGIZE THE CIRCUIT BREAKER, MAKING IT SPARE. NOTE SPARE ON PANELBOARD DIRECTORY.
- 39. CONTRACTOR SHALL BE RESPONSIBLE FOR COORDINATING STARTER TYPE, OVERLOAD SIZE, AND DISCONNECT SIZE FOR ALL MOTORS IN EACH AIR HANDLER UNIT ROOM WITH MECHANICAL CONTRACTOR.
- 40. CONTRACTOR TO REFER TO PLUMBING DRAWINGS FOR EXACT LOCATION OF ALL FLOW SWITCHES. CONTRACTOR TO PROVIDE CONNECTION TO FLOW SWITCHES FROM FIRE ALARM SYSTEM. CONTRACTOR TO ALSO PROVIDE CONNECTION TO ALL TAMPER SWITCHES FOR EXACT LOCATIONS COORDINATE WITH FIRE PROTECTION (SPRINKLER) CONTRACTOR.

THE TAMPER SWITCHES WILL BE PROVIDED AT ALL FIRE PROTECTION VALVES EXCEPT FIRE DEPARTMENT HOSES.

- 41. ALL NEW ELECTRICAL PANELS SHALL BE INSTALLED A MINIMUM OF 85 FROM ADJACENT PERPENDICULAR WALLS (TO ALLOW FOR FUTURE INSTALLATION OF ELECTRICAL PANELS ON ADJACENT PERPENDICULAR WALLS).
- 42. INSTALL ALL TRANSFORMERS A MINIMUM OF 6" FROM WALLS.
- 43. SUBMITTALS
- GENERAL: REFER TO GENERAL CONDITIONS FOR SUBMITTAL PROCEDURES AND REQUIREMENTS.
- B. FORMAT: FURNISH SUBMITTAL DATA NEATLY BOUND IN AN 8-1/2" X 11" FOLDER OR BINDER WITH A TABLE OF CONTENTS LISTING SPECIFICATION SECTION. SUBMITTAL DATA ON ALL ELECTRICAL EQUIPMENT (PANELBOARDS, LIGHT FIXTURES, ETC.) SHALL BE MODIFIED, AS NECESSARY, TO BECOME "AS BUILT" DOCUMENTS.
- 23. WHERE THERE ARE MORE THAN (1) SWITCH OR DIMMING DEVICE IN A LOCATION, CONTRACTOR C. SUBMITTALS SHALL CONSIST OF DETAILED SHOP DRAWINGS, SPECIFICATIONS, "CATALOG CUTS" AND DATA SHEETS CONTAINING PHYSICAL AND DIMENSIONAL INFORMATION. PERFORMANCE DATA, ELECTRICAL CHARACTERISTICS, MATERIALS USED IN FABRICATION, MATERIAL FINISH AND SHALL CLEARLY INDICATE THOSE OPTIONAL ACCESSORIES WHICH ARE INCLUDED AND THOSE WHICH ARE EXCLUDED.
 - D. SUBMIT SHOP DRAWINGS FOR:
 - PANELBOARDS.
 - E. SUBMIT MANUFACTURER'S DATA FOR:
 - 1. LIGHTING FIXTURES. WIRING DEVICES AND DEVICE PLATES (ALL TYPES).
 - 3. FIRE ALARM DEVICES.
 - 4. TRANSFORMERS. DISCONNECT SWITCHES.
 - 6. PANELBOARDS
 - MOTOR STARTERS
 - 44. THE CONTRACTOR IS RESPONSIBLE FOR SURVEYING THE SITE TO DETERMINE ALL EXISTING CONDITIONS RELATED TO THE NEW WORK. THIS INCLUDES ALL EXISTING UNDERGROUND UTILITIES. CONTRACTOR SHALL MAKE PROVISIONS FOR CROSSING, DISCONNECTING IN THE EVENT NEW UTILITY SERVICE TO BUILDING ARE ROUTED THRU THESE AREAS.

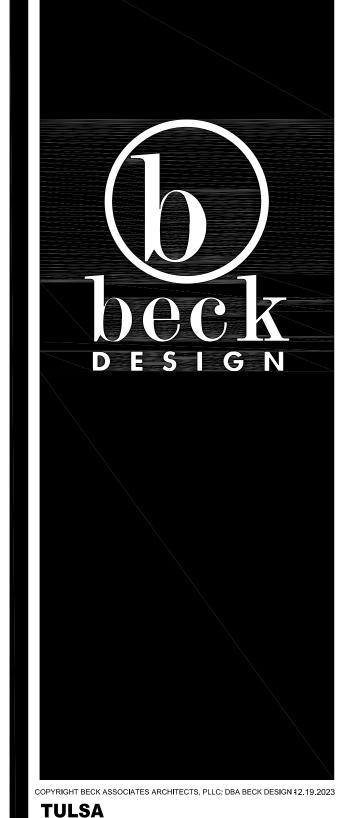

OKLAHOMA CITY 1 DEAN A McGEE AVE SUITE 135

OKLAHOMA CITY, OK 73102

TULSA, OK 74119

T 918 583 5300

918 585 1967

PROJECT:

PROJECT # **SP 23-2 TULSA PERFORMING ARTS CENTER** l PACKAGE No. 2 MECH., AV AND **THEATRICAL** LIGHTING **UPGRADES**

PROJECT NUMBER:

202331.00 **CONSULTANT:**

PHILLIPS+GOMEZ

Fax: 918-582-2819

Phillips + Gomez

15 W 6th Street, Suite 2510 Tulsa, Oklahoma 74119 Telephone: 918-584-0102

Oklahoma Certificate of Authority (Engineers) - #CA1395

MEP CONSULTING ENGINEERS

REVISIONS: Description

SEAL:




ISSUE DATE: 01.24.2024

SHEET NUMBER:

E002 **ELECTRICAL**

GENERAL NOTES

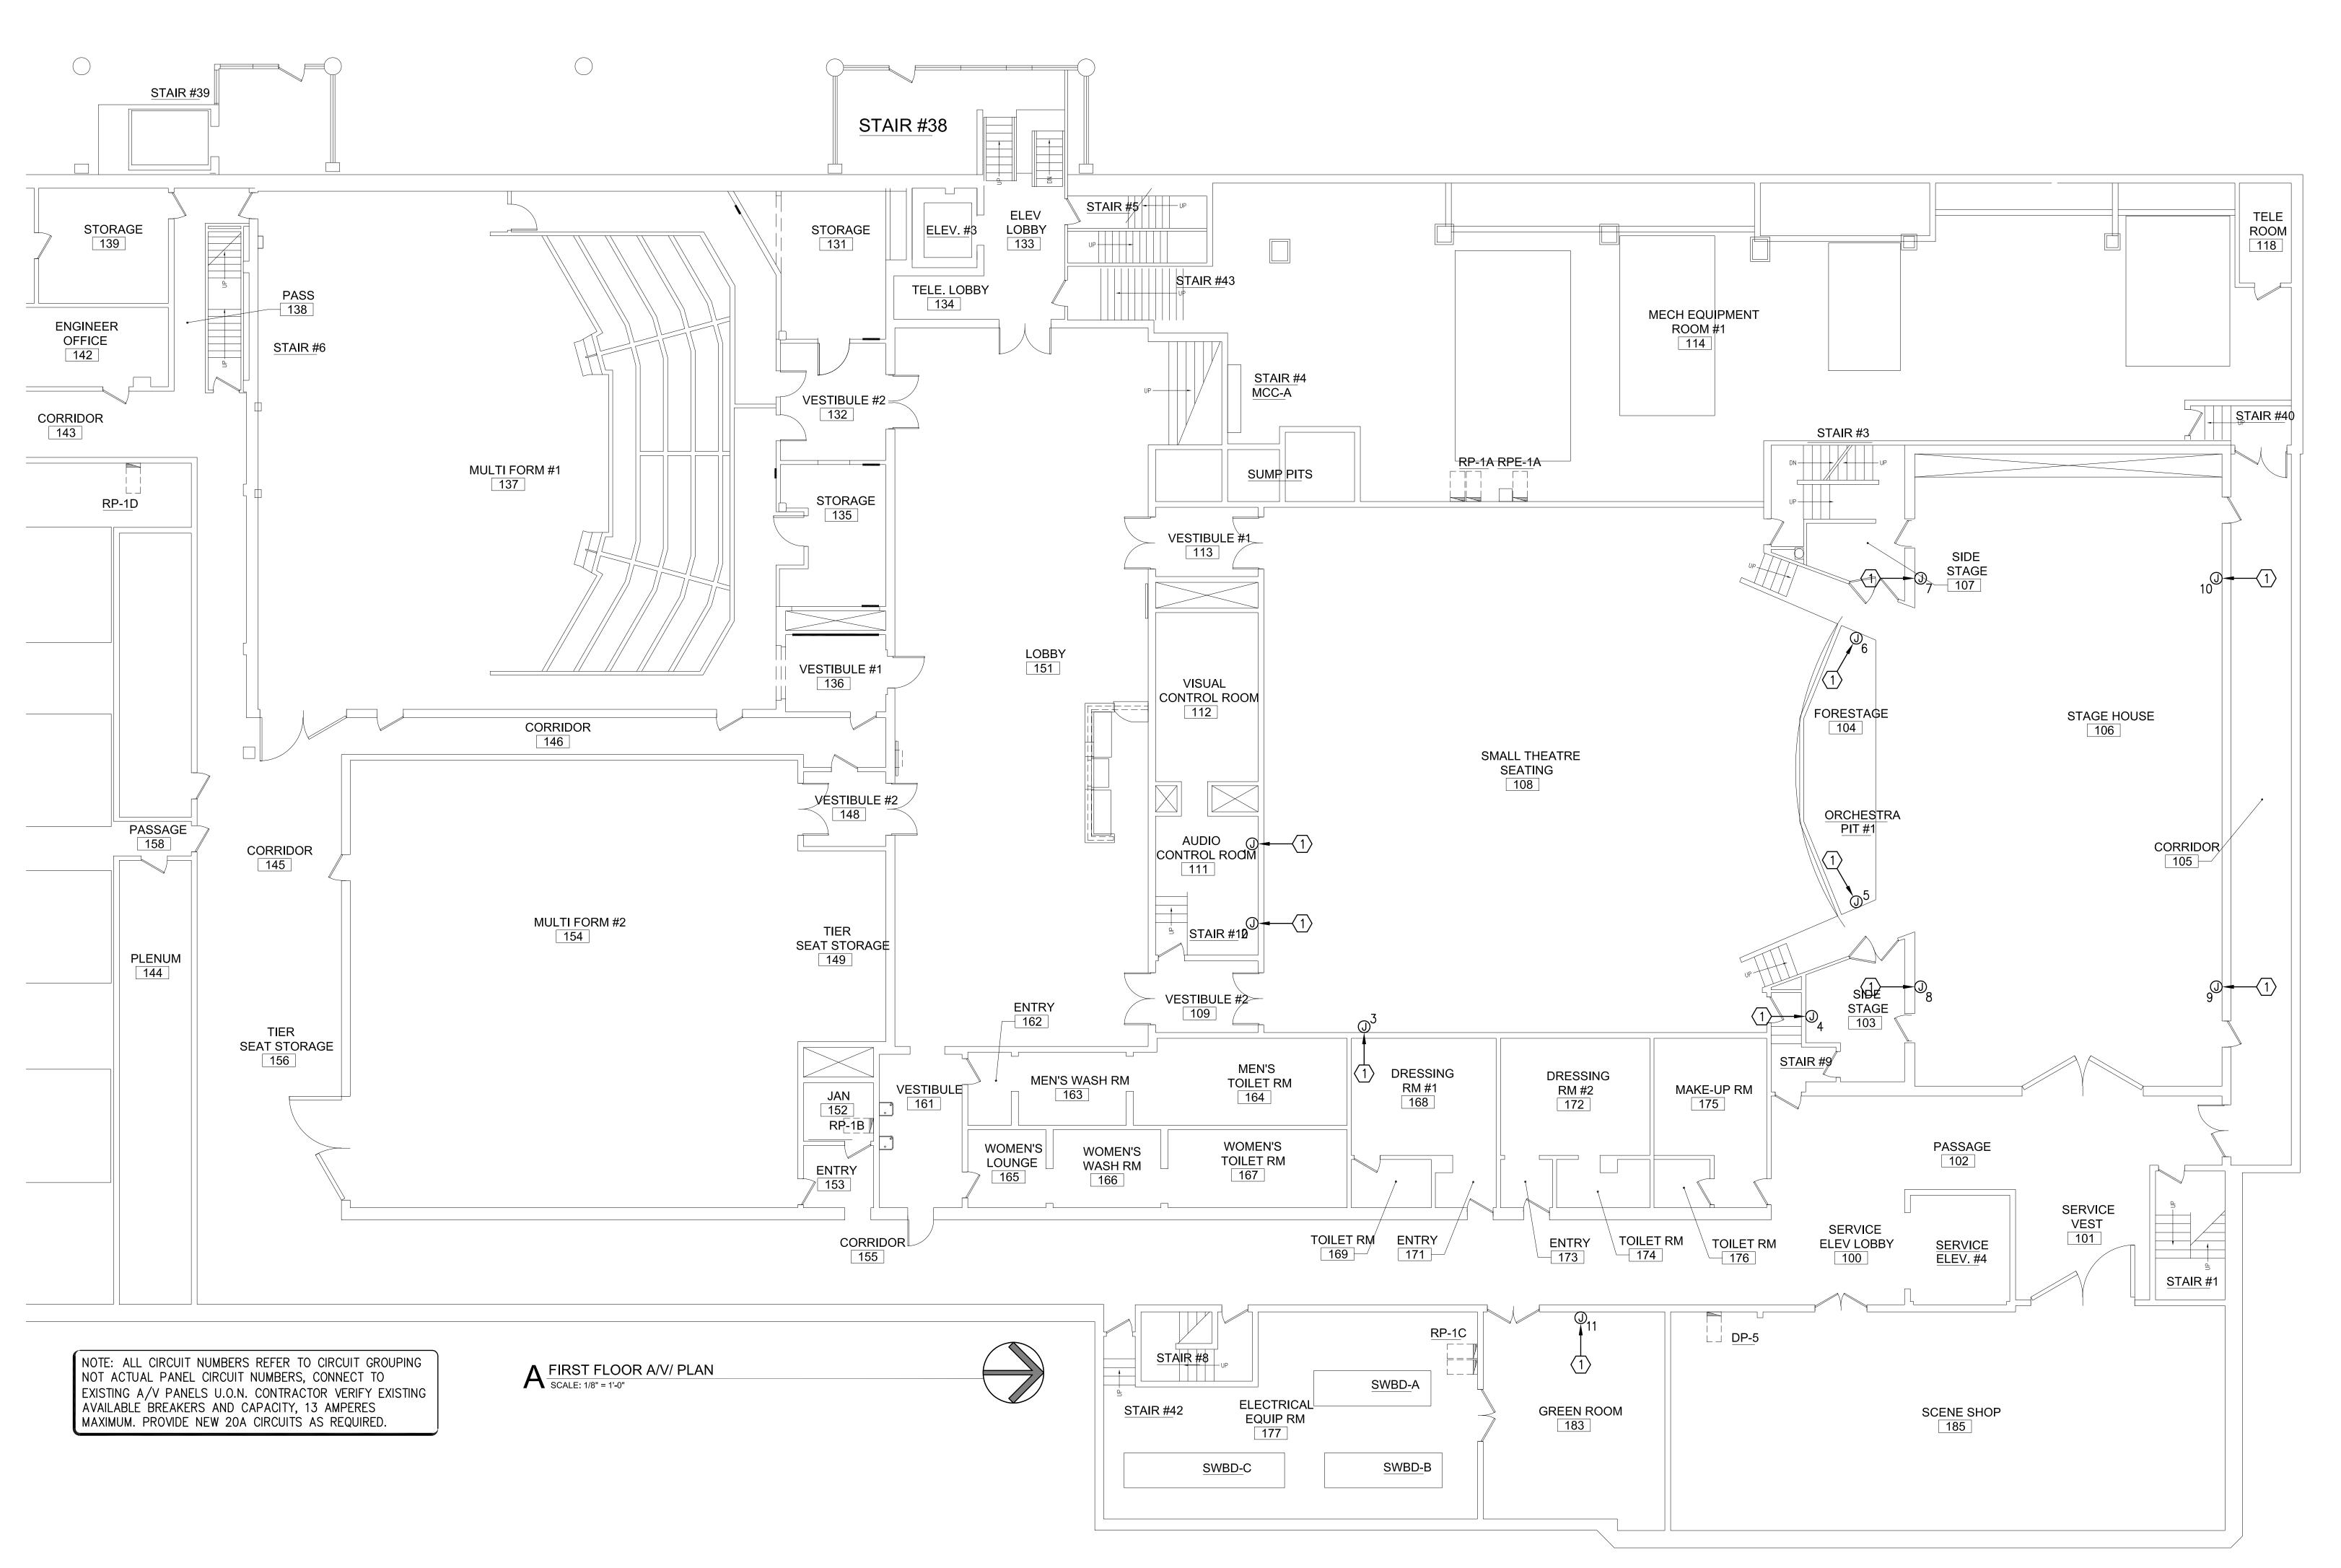



PYRIGHT BECK ASSOCIATES ARCHITECTS, PLLC; DBA BECK DESIGN 12.19.2023 SUITE 710 TULSA, OK 74119 T: 918.583.5300

OKLAHOMA CITY 131 DEAN A MCGEE AVE SUITE 135 OKLAHOMA CITY, OK 73102 T: 405.232.7007

PROJECT: PROJECT # SP 23-2 TULSA PERFORMING **ARTS CENTER -**PACKAGE No. 2 MECH., AV AND **THEATRICAL** LIGHTING **UPGRADES**

PROJECT NUMBER: 202331.00


CONSULTANT:

PHILLIPS+GOMEZ
MEP CONSULTING ENGINEERS
15 W 6th Street, Suite 2510
Tulsa, Oklahoma 74119
Telephone: 918-584-0102
Fax: 918-582-2819 Phillips + Gomez

REVISIONS:

Oklahoma Certificate of Authority (Engineers) - #CA1395

SEAL:

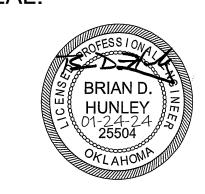


ISSUE DATE: 01.24.2024

SHEET NUMBER:

E101 FIRST FLOOR A/V

PLAN

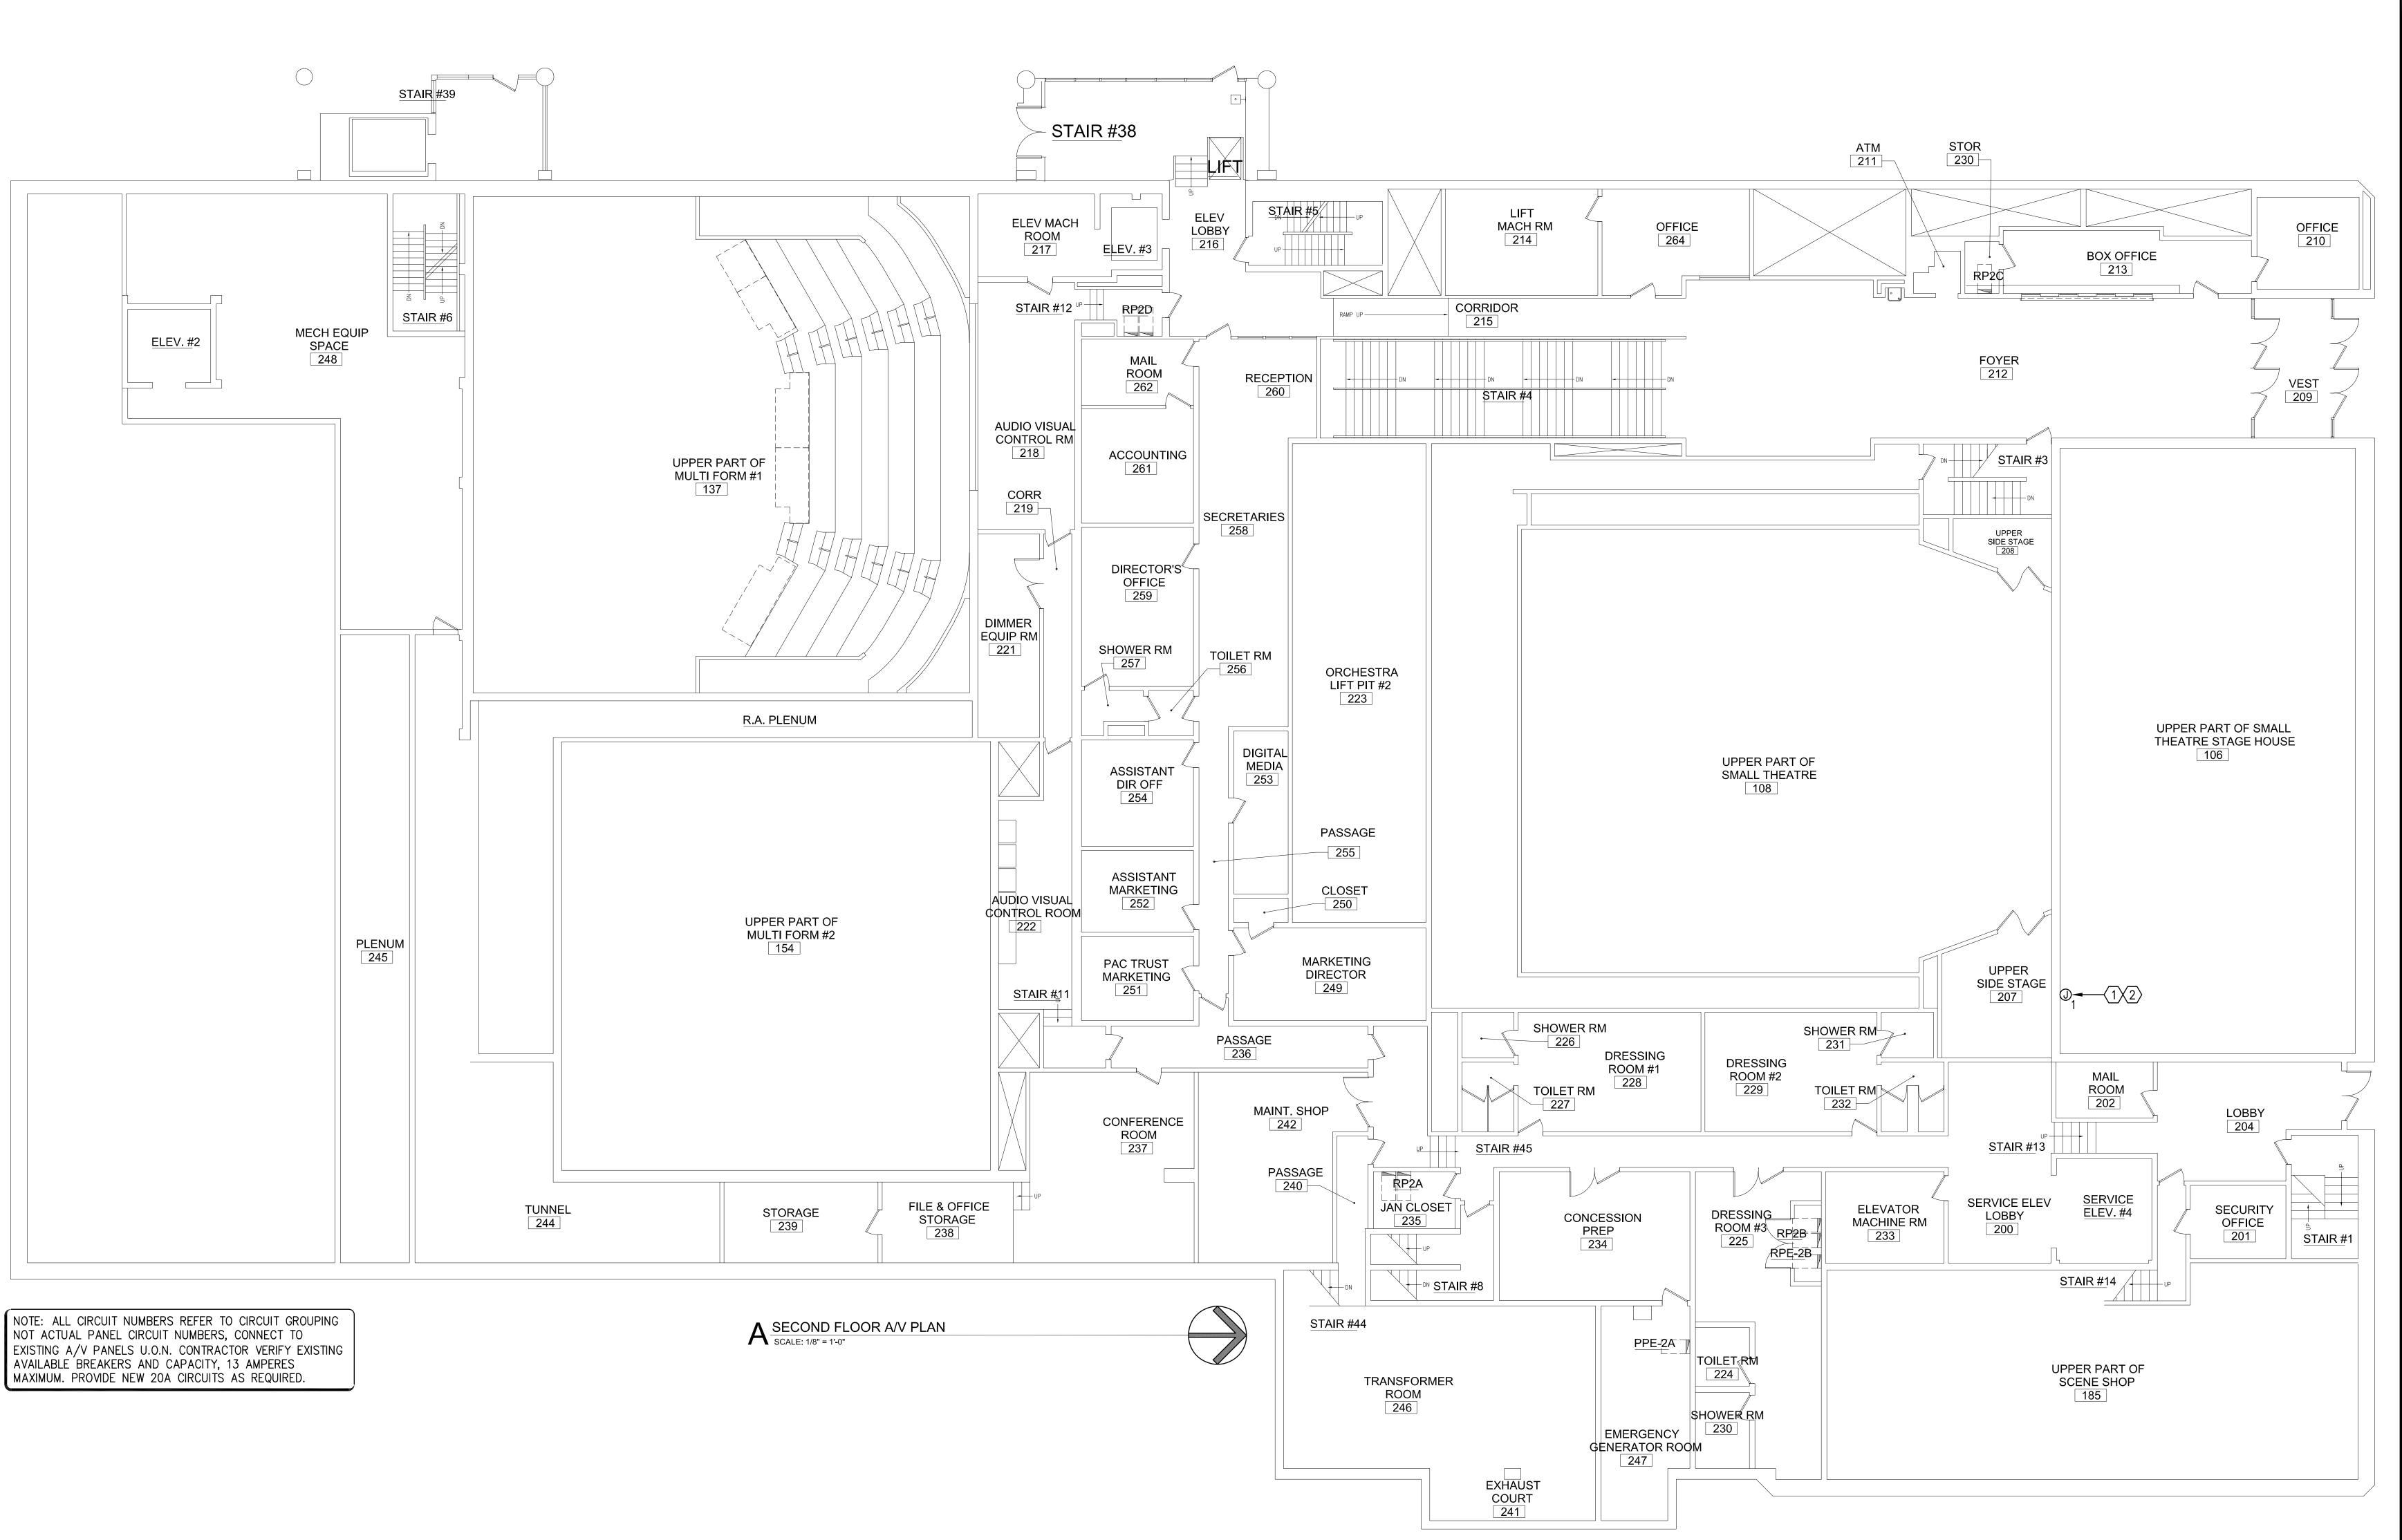



PYRIGHT BECK ASSOCIATES ARCHITECTS, PLLC, DBA BECK DESIGN 12.19.2023 TULSA 110 WEST SEVENTH SUITE 710 TULSA, OK 74119 T: 918.583.5300 F: 918.585.1967

OKLAHOMA CITY
131 DEAN A McGEE AVE
SUITE 135
OKLAHOMA CITY, OK 73102
T: 405.232.7007

PROJECT: PROJECT # **SP 23-2** TULSA PERFORMING **ARTS CENTER -**PACKAGE No. 2 MECH., AV AND THEATRICAL LIGHTING **UPGRADES**

PROJECT NUMBER: 202331.00

CONSULTANT:

PHILLIPS+GOMEZ
MEP CONSULTING ENGINEERS
15 W 6th Street, Suite 2510
Tulsa, Oklahoma 74119
Telephone: 918-584-0102
Fax: 918-582-2819

Phillips + Gomez Oklahoma Certificate of Authority (Engineers) - #CA1395

REVISIONS: No Description

SEAL:



ISSUE DATE: 01.24.2024


SHEET NUMBER:

E102


SECOND FLOOR A/V PLAN

ELECTRICAL NUMBERED NOTES

- PROVIDE JUNCTION BOX FOR ELECTRICAL SERVICE TO NEW AV DEVICE. CIRCUIT AS INDICATED. COORDINATE EXACT LOCATION AND ELECTRICAL REQUIREMENTS WITH AV DRAWINGS.
- 2. PROVIDE ONE(1)-50A, 1-POLE CIRCUIT BREAKER INTO EXISTING PANEL RP-ISAMP TO FEED TO AMPLIFIER. BRANCH CIRCUIT SHALL BE 2#8, 1#10GND,
- 3. REPLACE EXISTING FIXTURE WITH NEW PORTFOLIO LD6C-10-90-4K-D010-M-LI. RE-USE EXISTING CIRCUITING. PROVIDE WITH 1000 LUMENS, 4000K COLOR TEMPERATURE AND 120V OPERATION.
- 4. PROVIDE SELF LUMINOUS TRITIUM EXIT SIGN. COORDINATE EXACT LOCATION AND MOUNTING HEIGHT WITH ARCHITECT.
- PROVIDE COMBINATION SMOKE/HEAT DETECTOR. CONNECT TO EXISTING FIRE ALARM SYSTEM.

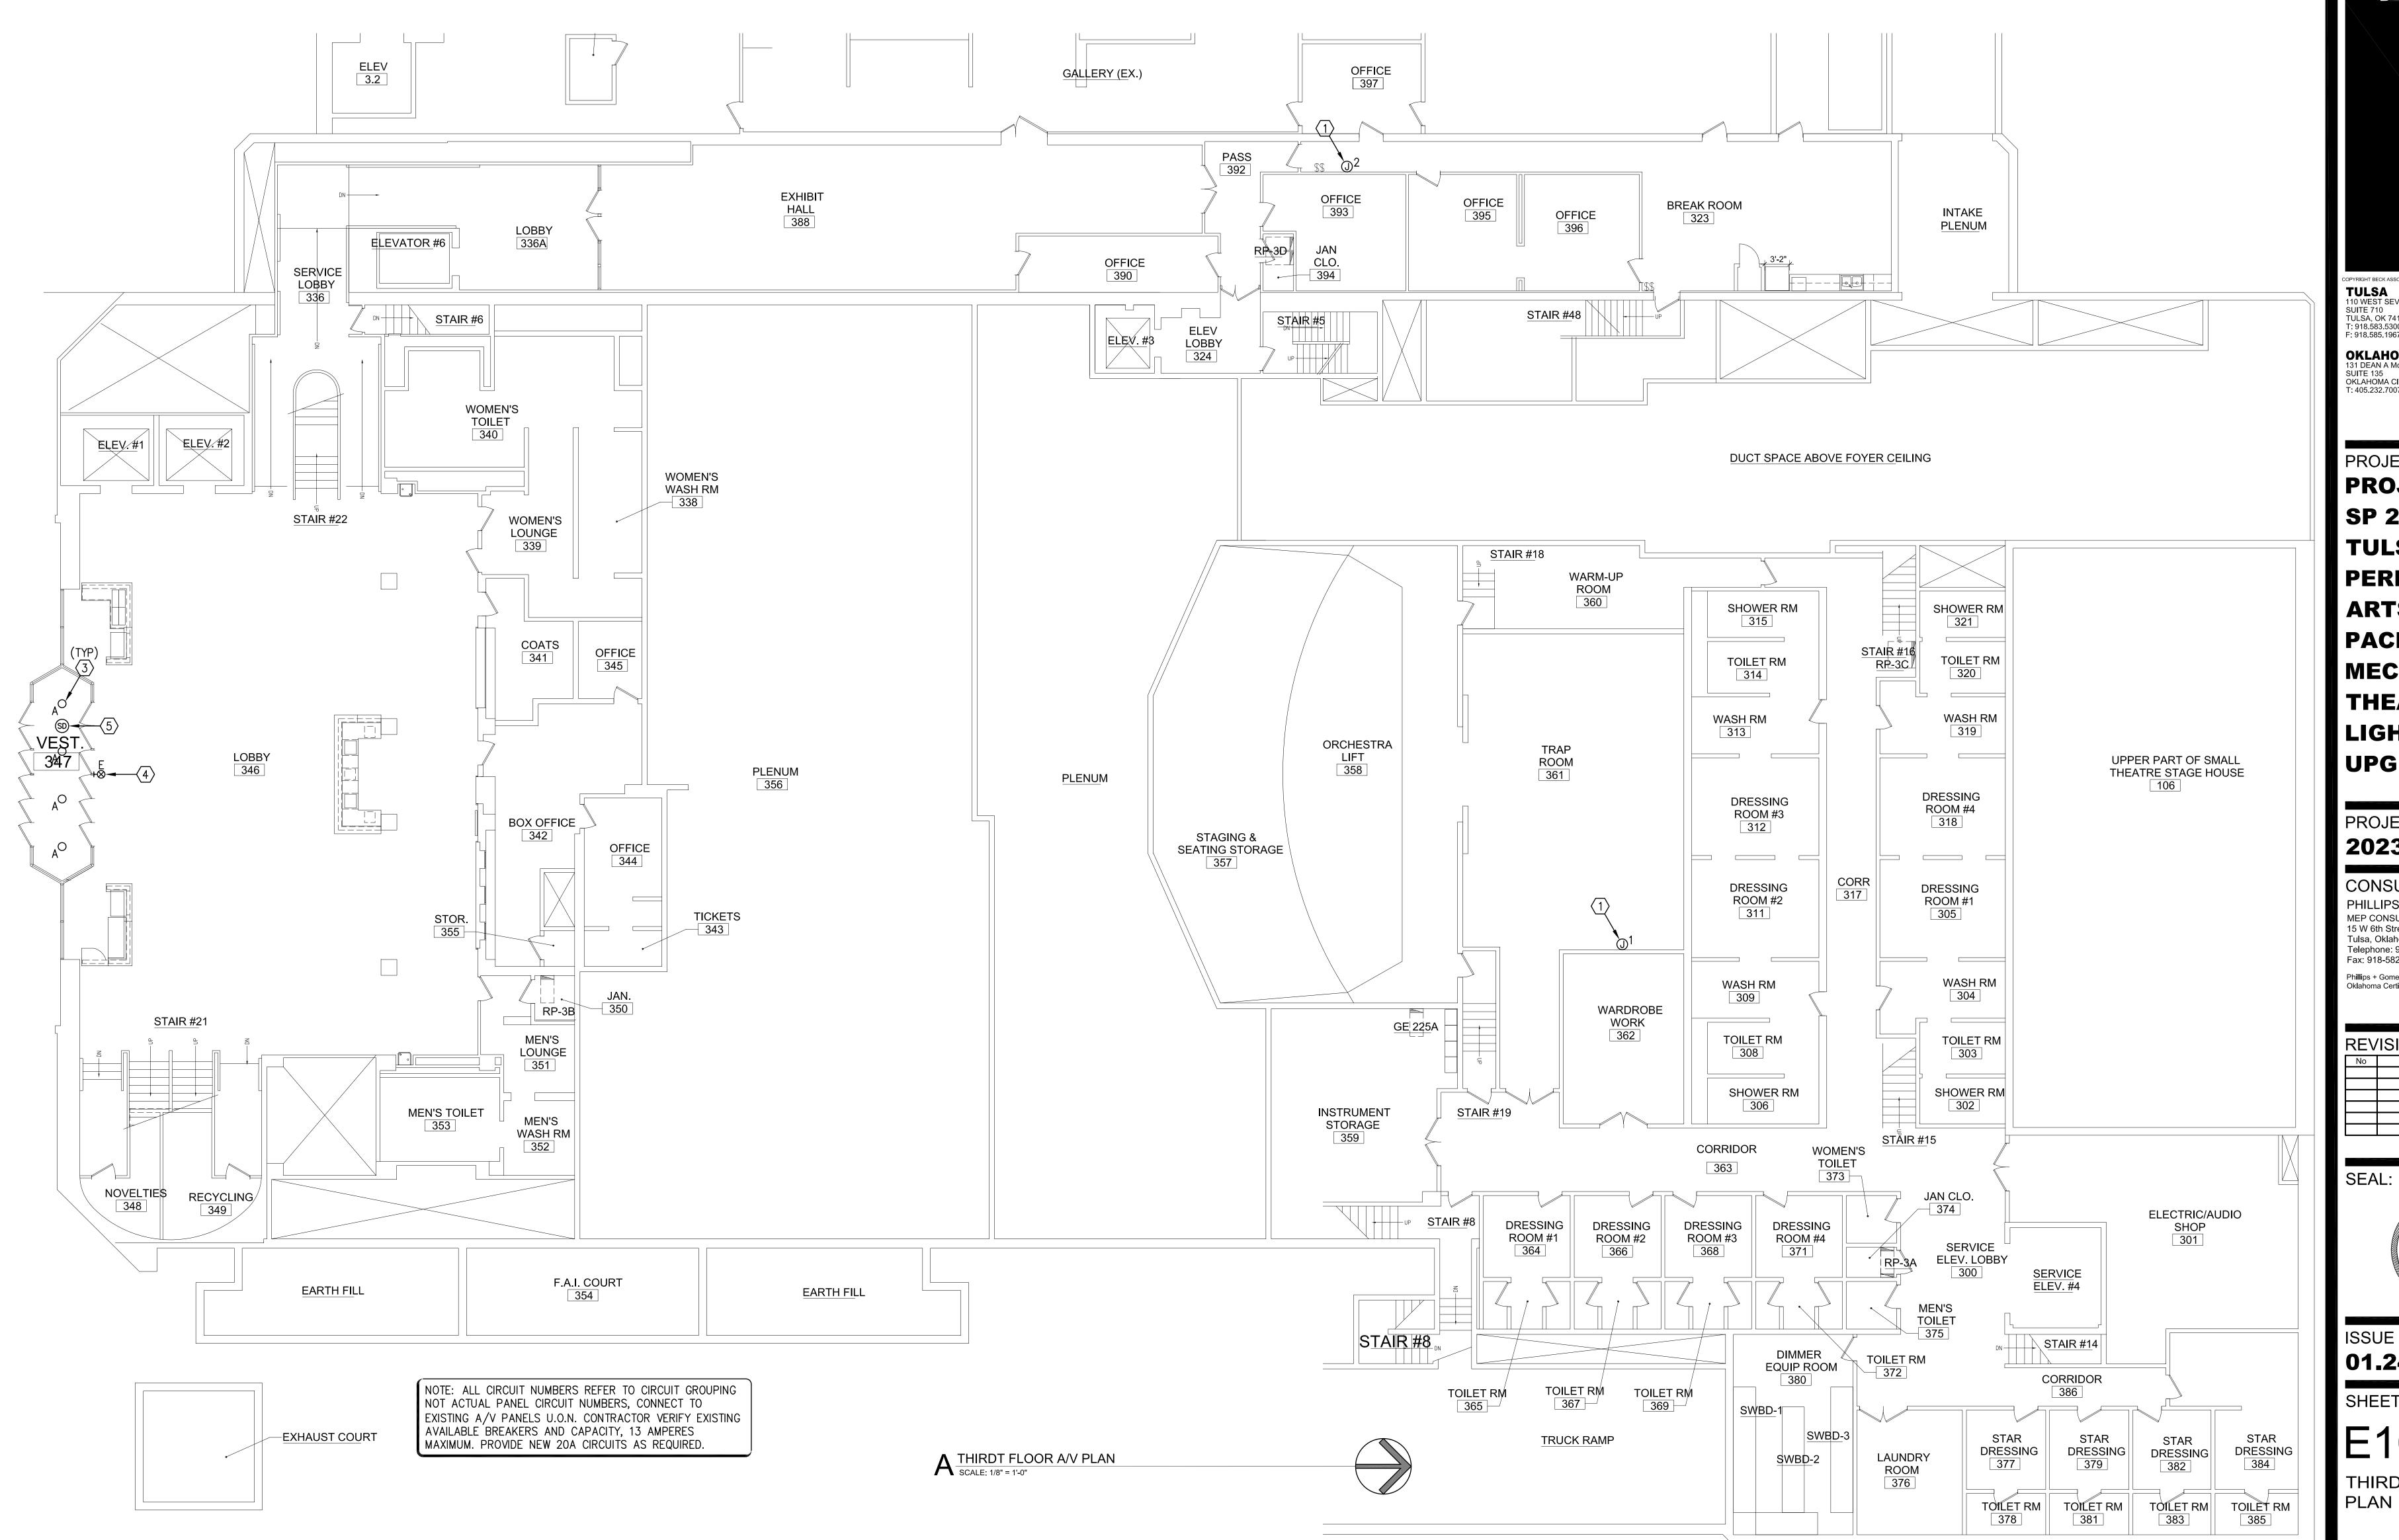

SECOND FLOOR A/V PLAN

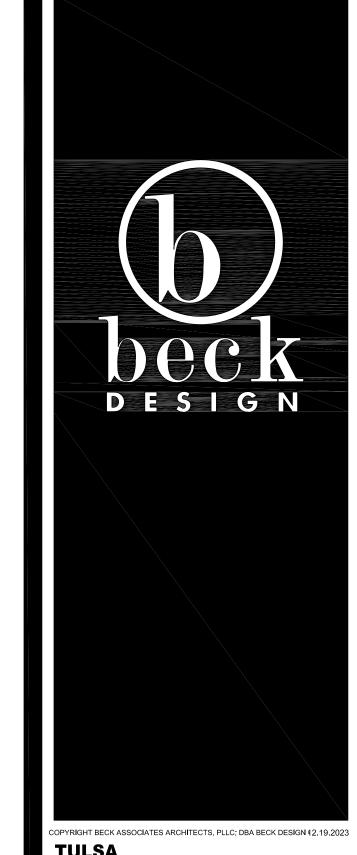

TULSA

TULSA, OK 74119 Г: 918.583.5300 F: 918.585.1967

OKLAHOMA CITY

SUITE 135 OKLAHOMA CITY, OK 73102

PROJECT: PROJECT # SP 23-2 **TULSA** PERFORMING **ARTS CENTER -**PACKAGE No. 2 MECH., AV AND THEATRICAL **LIGHTING UPGRADES**

PROJECT NUMBER: 202331.00

CONSULTANT:

PHILLIPS+GOMEZ MEP CONSULTING ENGINEERS 15 W 6th Street, Suite 2510 Tulsa, Oklahoma 74119 Telephone: 918-584-0102 Fax: 918-582-2819

Phillips + Gomez Oklahoma Certificate of Authority (Engineers) - #CA1395

REVISIONS: No Description Date				1
No Description Date	REV	ISIONS:		
	No	Description	Date	
	·			


SEAL:



ISSUE DATE: 01.24.2024

SHEET NUMBER:

THIRD FLOOR A/V

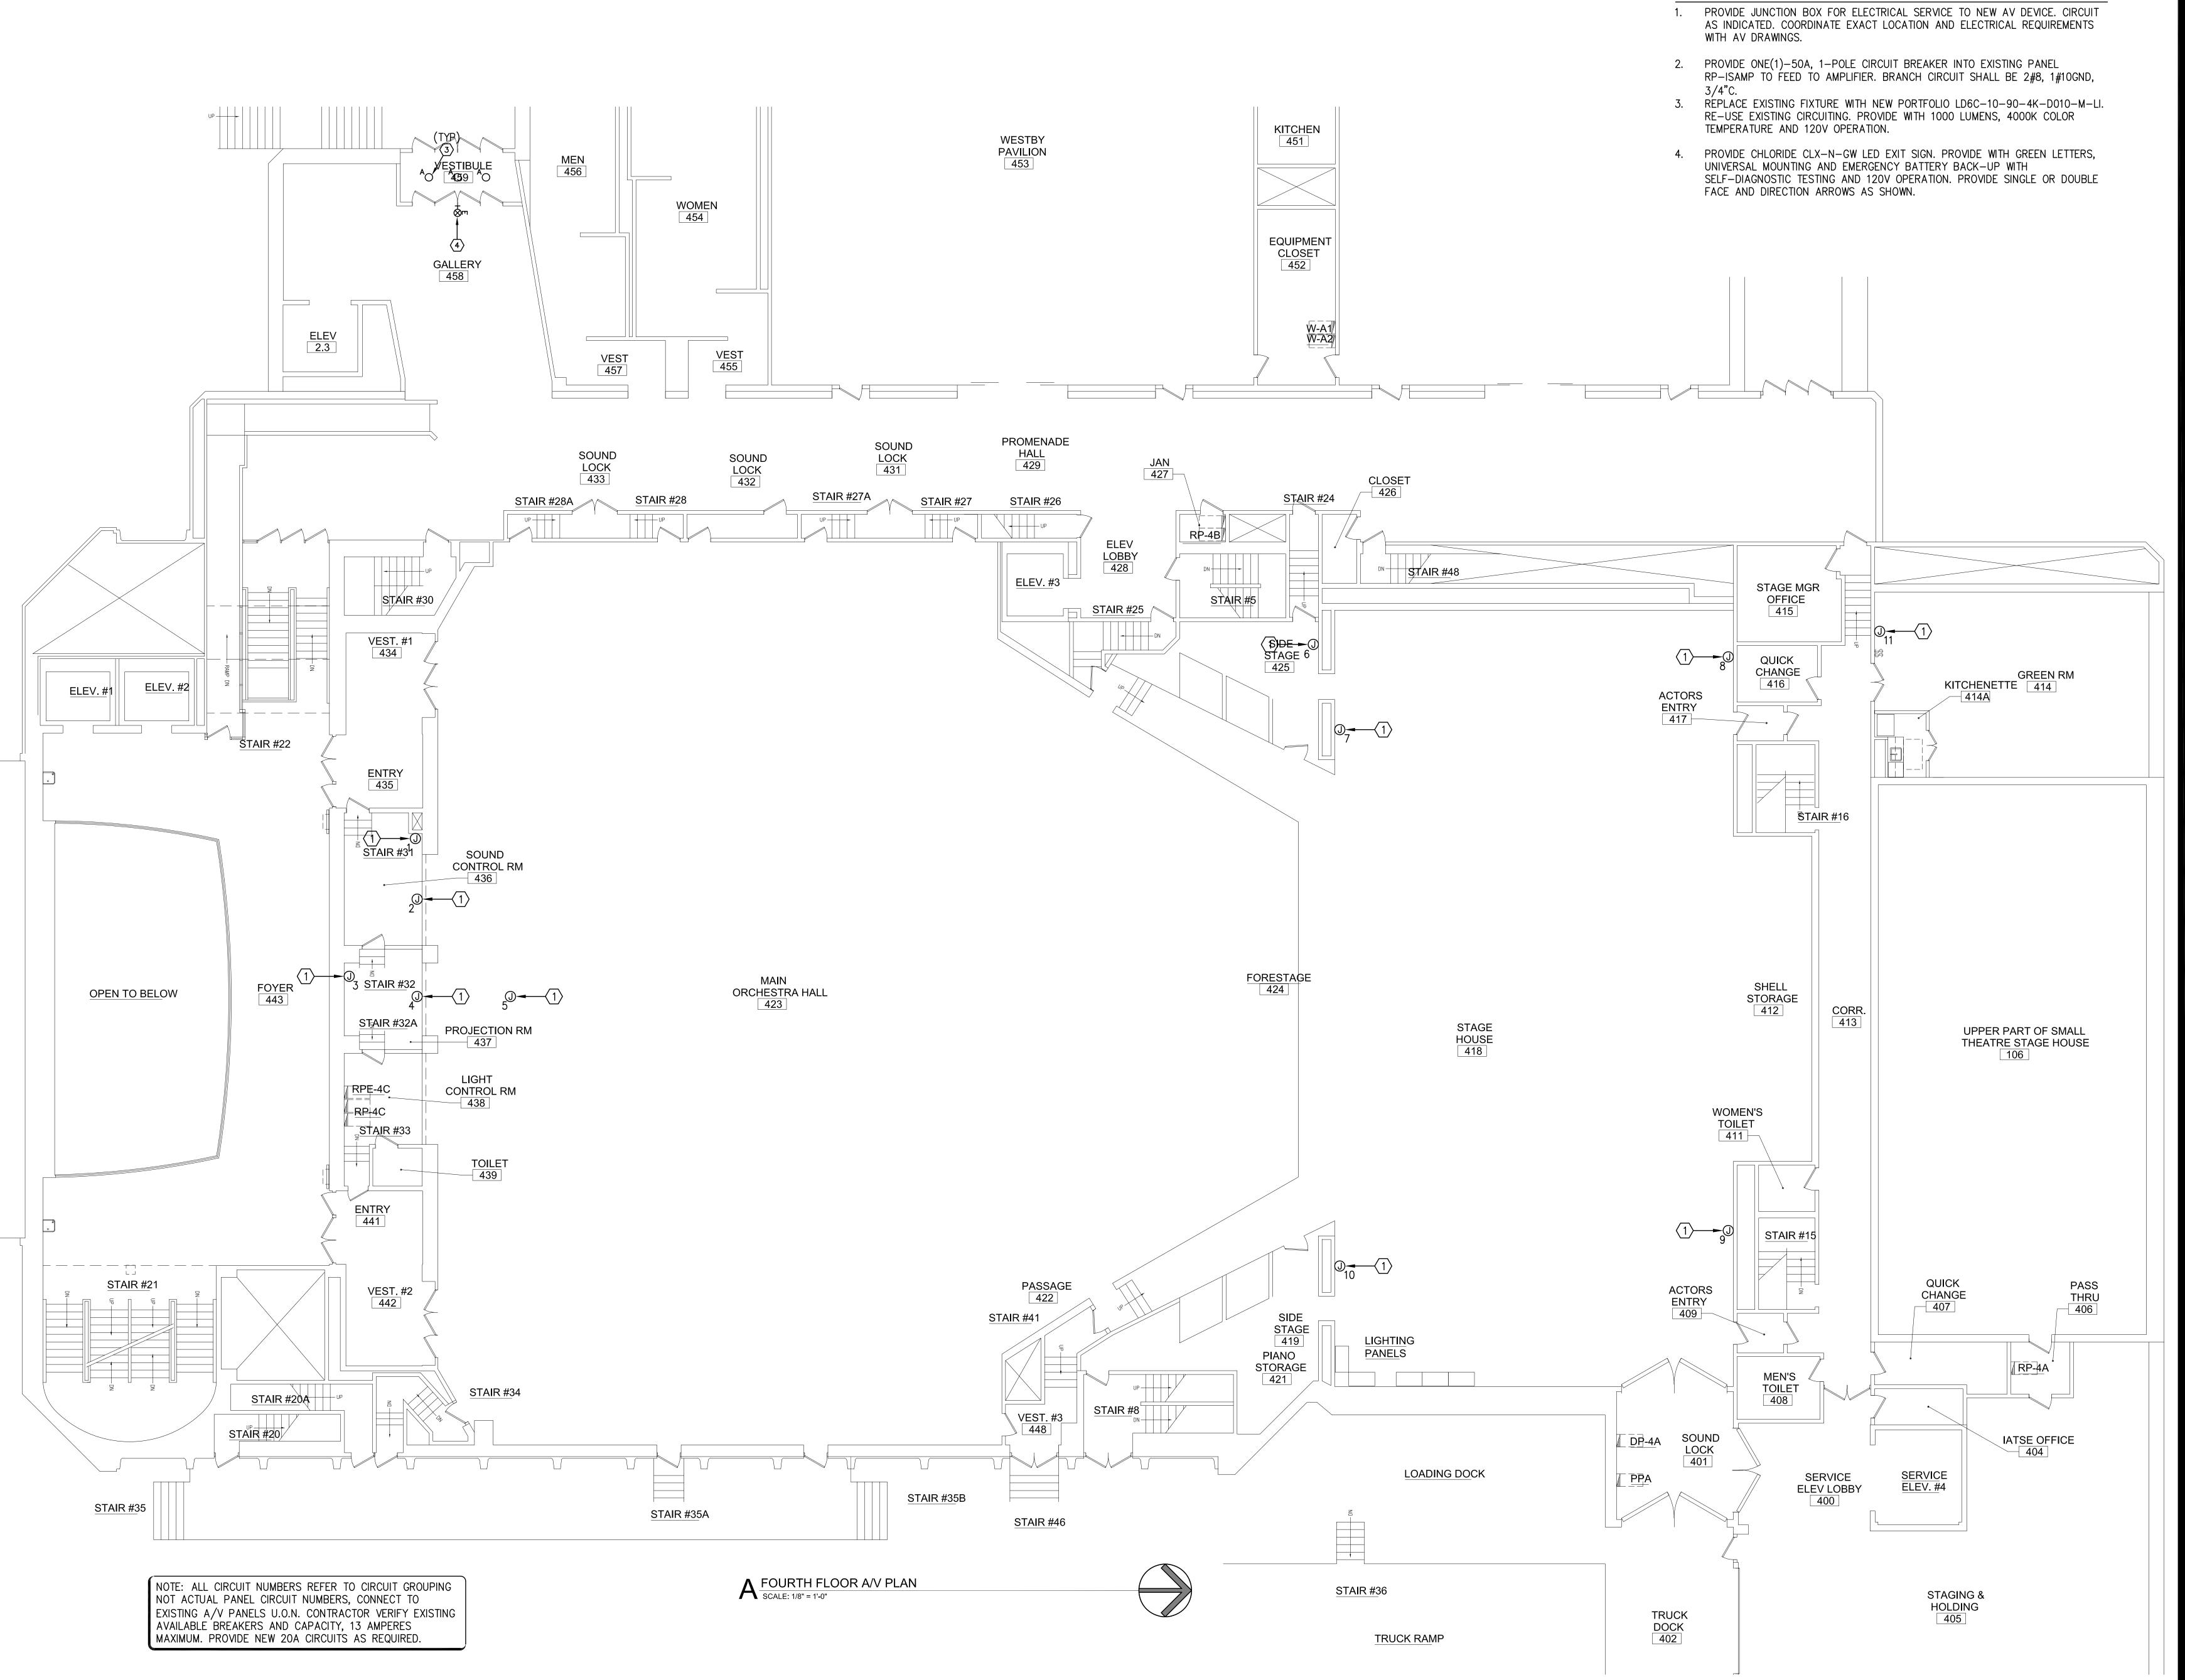



OPYRIGHT BECK ASSOCIATES ARCHITECTS, PLLC; DBA BECK DESIGN 12.19.2023 TULSA 110 WEST SEVENTH SUITE 710 TULSA, OK 74119

OKLAHOMA CITY

T: 918.583.5300 F: 918.585.1967

SUITE 135 OKLAHOMA CITY, OK 73102

PROJECT: PROJECT # **SP 23-2** TULSA **PERFORMING ARTS CENTER -**PACKAGE No. 2 MECH., AV AND **THEATRICAL** LIGHTING **UPGRADES**

PROJECT NUMBER: 202331.00

CONSULTANT:

PHILLIPS+GOMEZ
MEP CONSULTING ENGINEERS
15 W 6th Street, Suite 2510
Tulsa, Oklahoma 74119
Telephone: 918-584-0102
Fax: 918-582-2819

Phillips + Gomez Oklahoma Certificate of Authority (Engineers) - #CA1395

REVISIONS:					
No	Description	Date			

SEAL:




ISSUE DATE: 01.24.2024

SHEET NUMBER:


E104

FOURTH FLOOR A/V

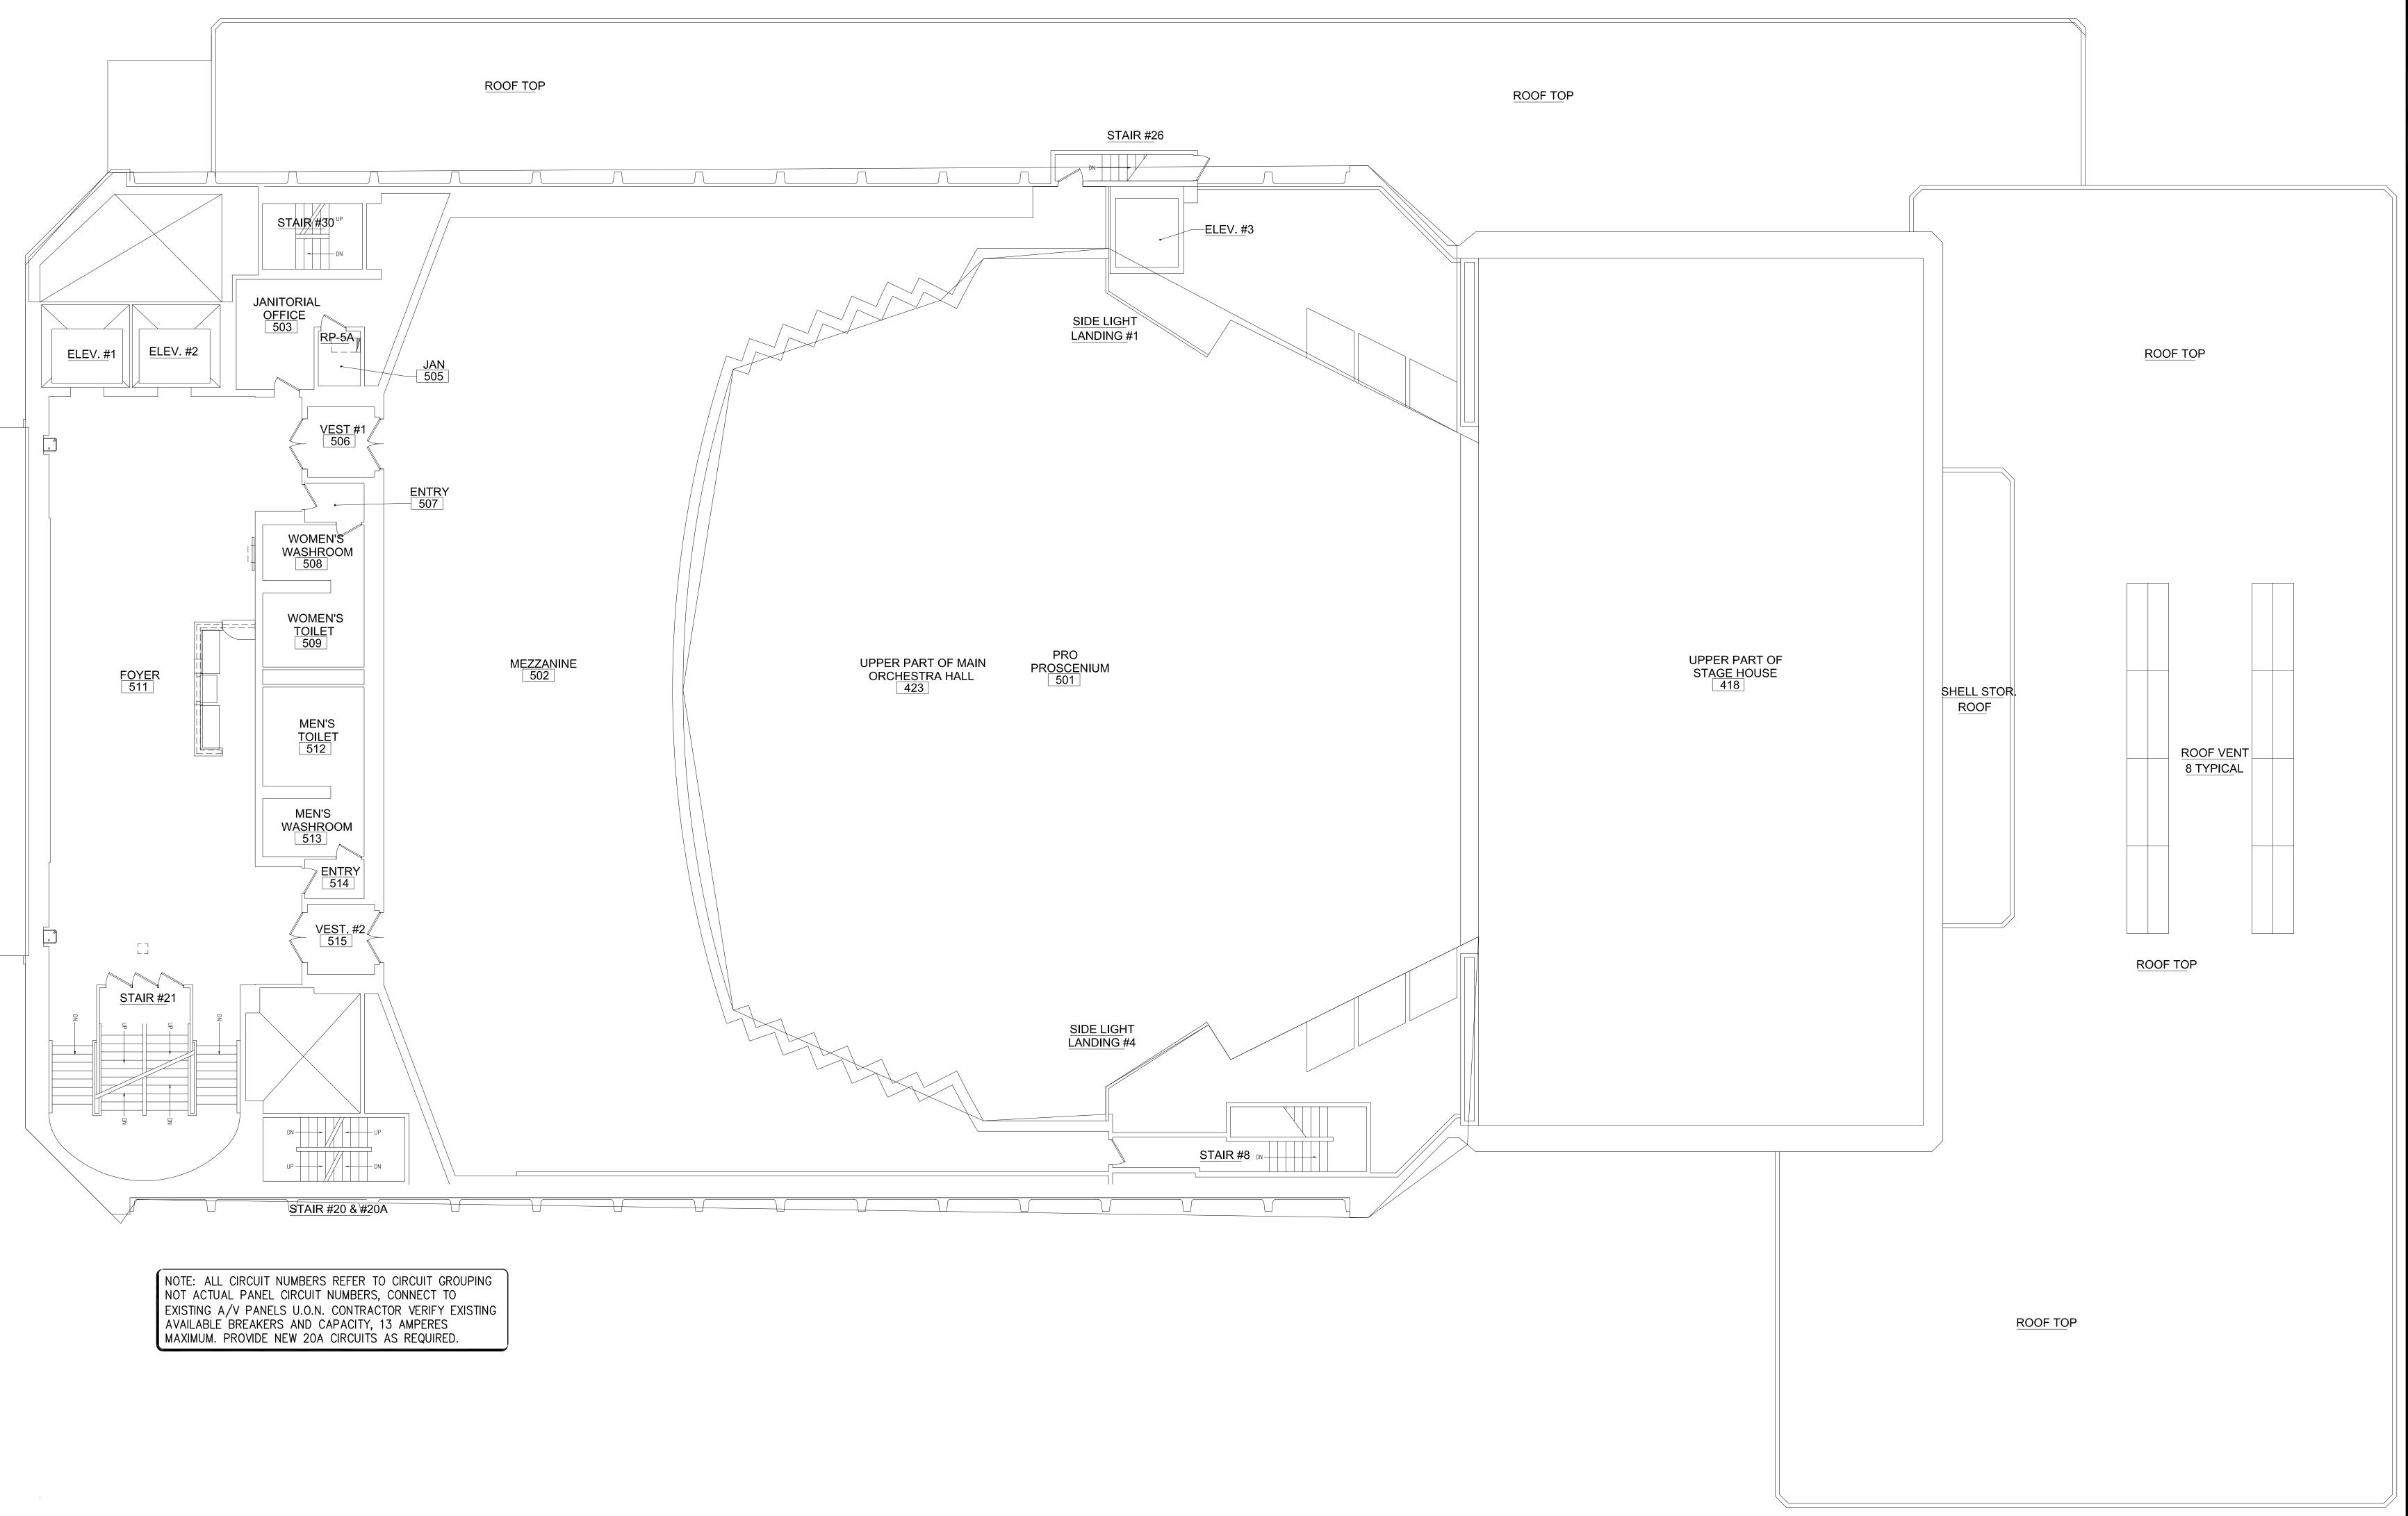

A FIFTH FLOOR A/V PLAN

SCALE: 1/8" = 1'-0"

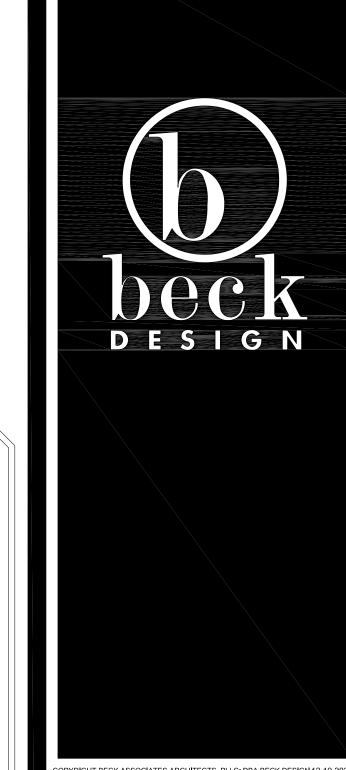

PYRIGHT BECK ASSOCIATES ARCHITECTS, PLLC, DBA BECK DESIGN 12.19.2023

SUITE 710 TULSA, OK 74119 T: 918.583.5300 F: 918.585.1967

OKLAHOMA CITY
131 DEAN A McGEE AVE
SUITE 135
OKLAHOMA CITY, OK 73102
T: 405.232.7007

PROJECT:
PROJECT # SP 23-2 TULSA PERFORMING **ARTS CENTER -**PACKAGE No. 2 MECH., AV AND THEATRICAL LIGHTING

PROJECT NUMBER: 202331.00

UPGRADES


CONSULTANT:

PHILLIPS+GOMEZ
MEP CONSULTING ENGINEERS
15 W 6th Street, Suite 2510
Tulsa, Oklahoma 74119
Telephone: 918-584-0102
Fax: 918-582-2819

Phillips + Gomez Oklahoma Certificate of Authority (Engineers) - #CA1395

REVISIONS:					
No	Description	Date			

SEAL:

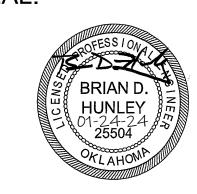


ISSUE DATE: 01.24.2024

SHEET NUMBER:


E105 FIFTH FLOOR A/V

PLAN

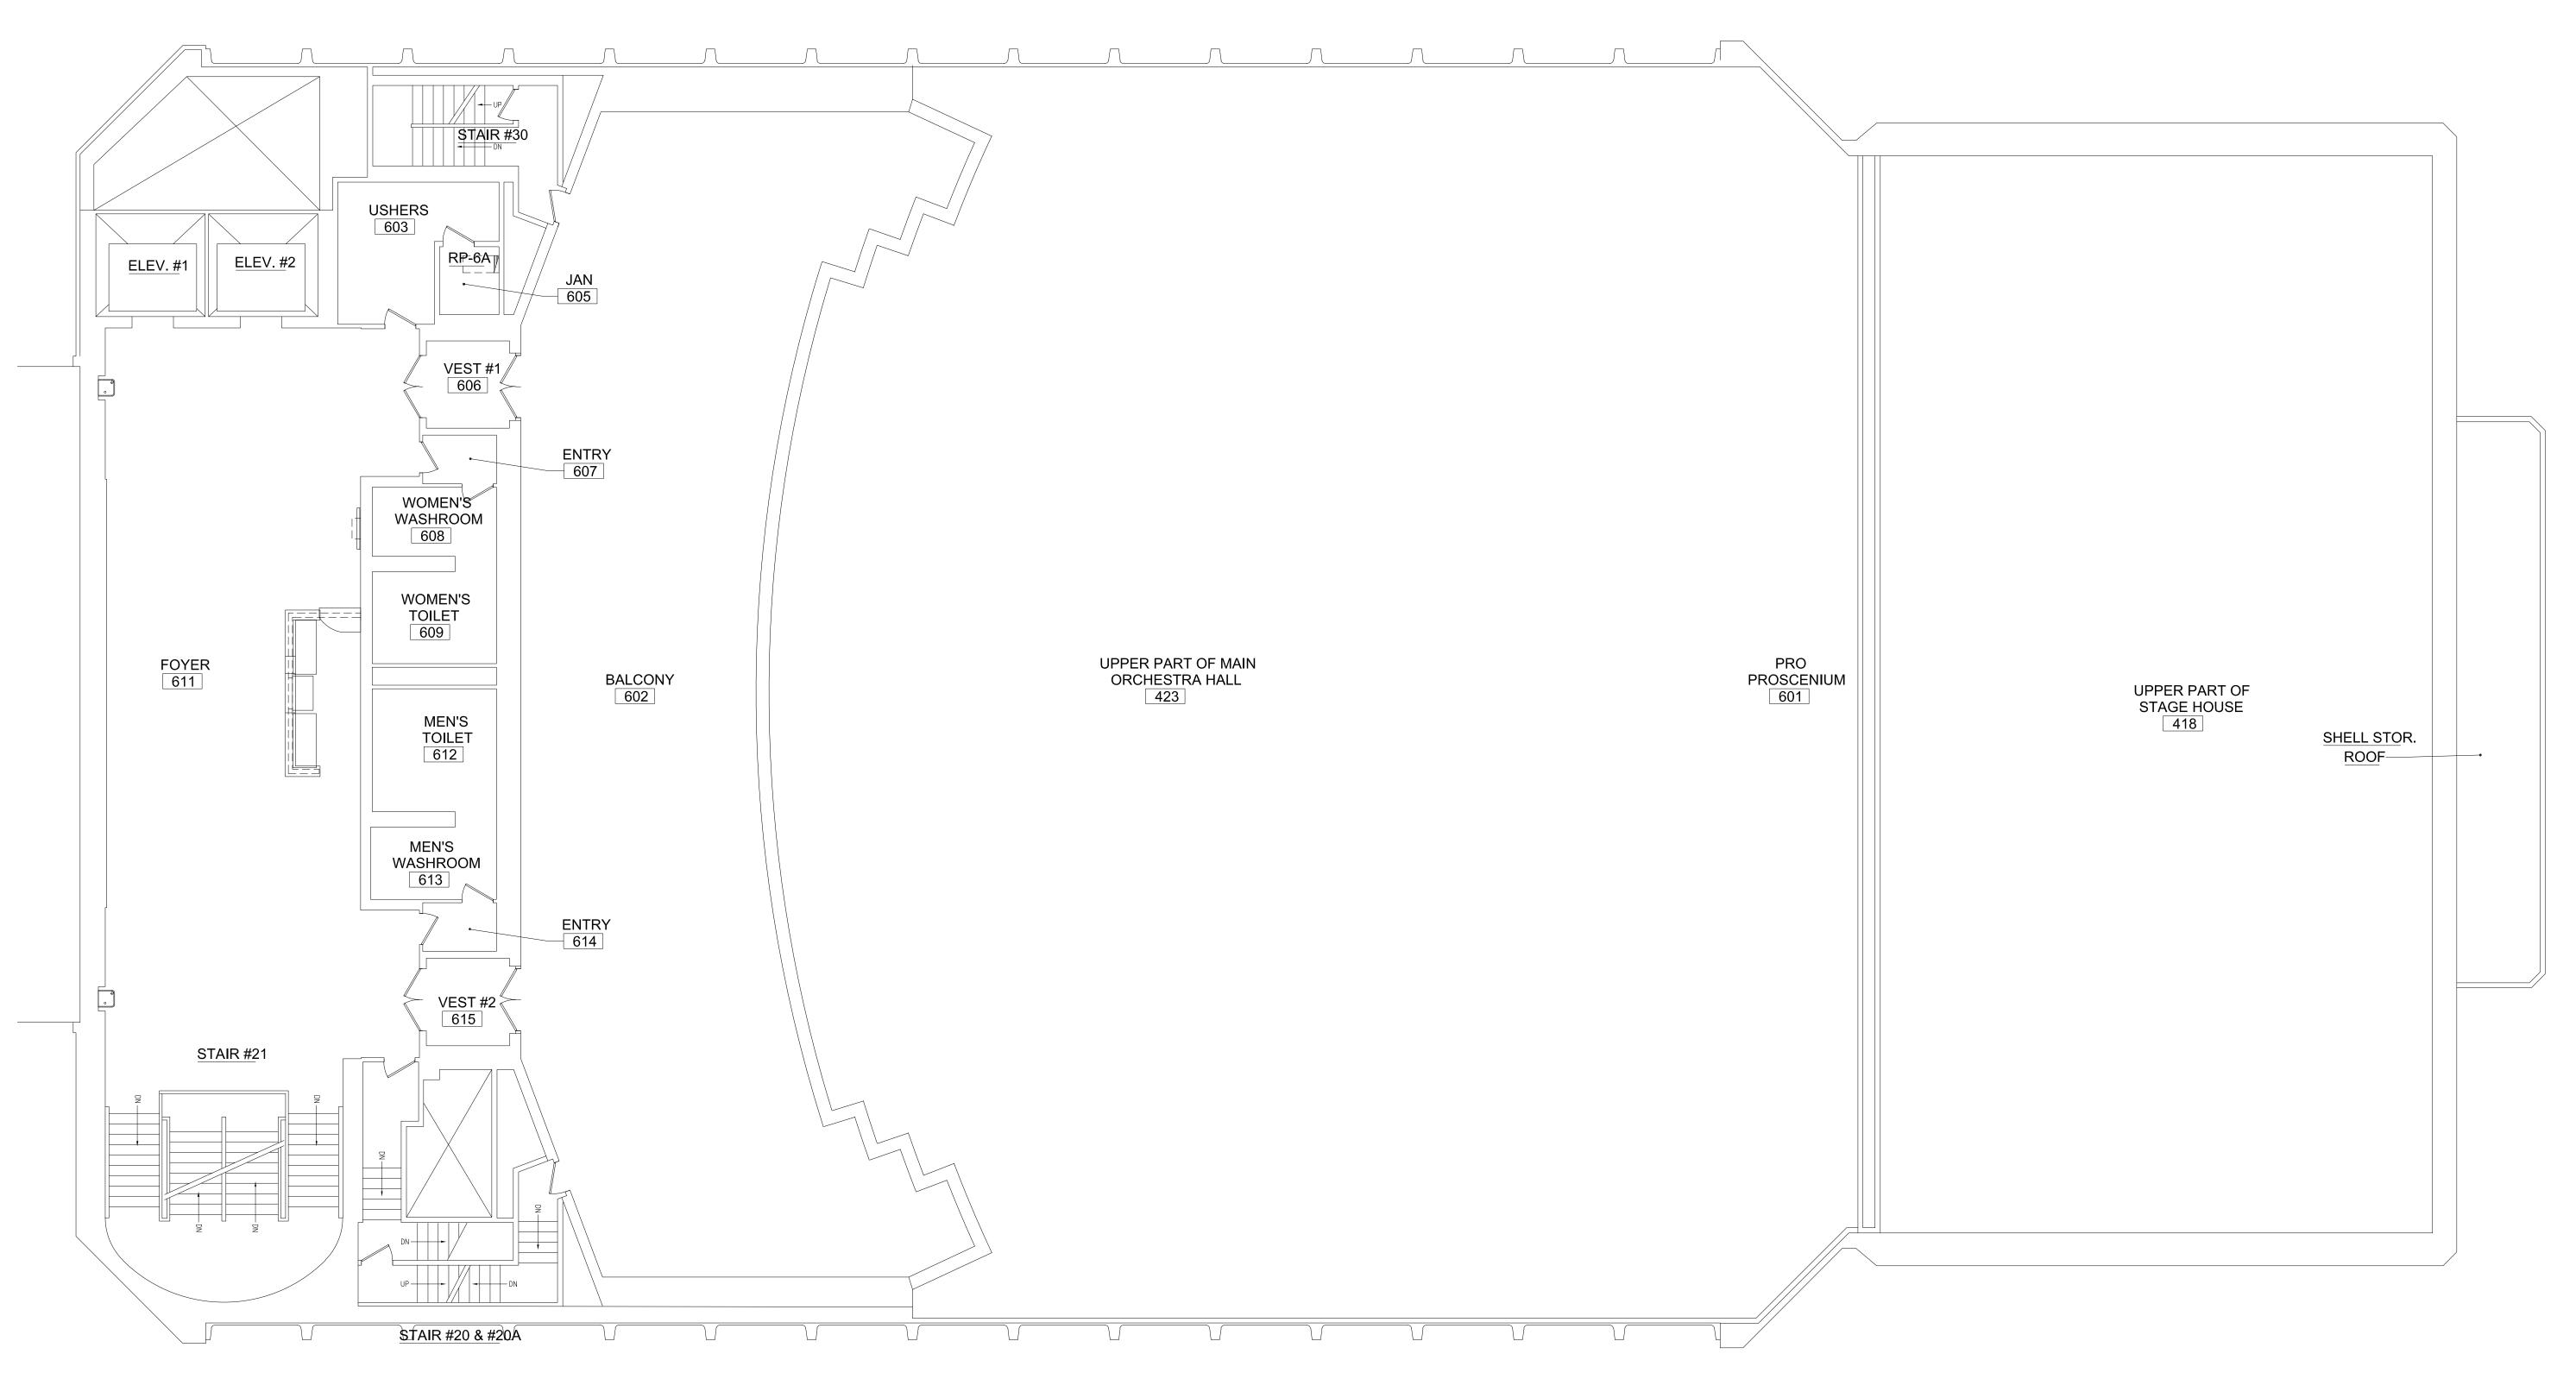

NOTE: ALL CIRCUIT NUMBERS REFER TO CIRCUIT GROUPING NOT ACTUAL PANEL CIRCUIT NUMBERS, CONNECT TO EXISTING A/V PANELS U.O.N. CONTRACTOR VERIFY EXISTING AVAILABLE BREAKERS AND CAPACITY, 13 AMPERES MAXIMUM. PROVIDE NEW 20A CIRCUITS AS REQUIRED.



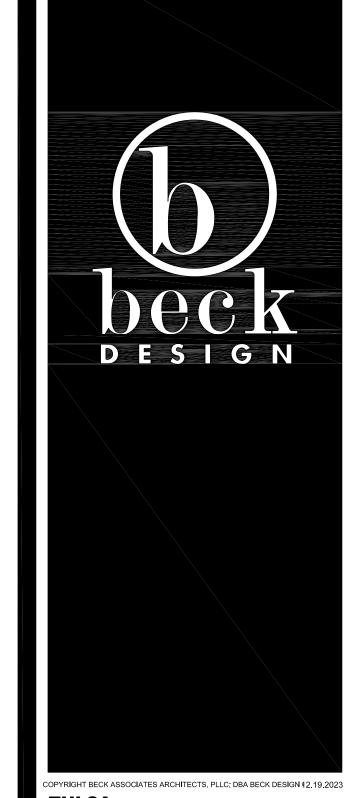

TULSA
110 WEST SEVENTH
SUITE 710
TULSA, OK 74119
T: 918.583.5300
F: 918.585.1967

OKLAHOMA CITY
131 DEAN A McGEE AVE
SUITE 135
OKLAHOMA CITY, OK 73102
T: 405.232.7007

PROJECT: PROJECT # SP 23-2 TULSA PERFORMING **ARTS CENTER -**PACKAGE No. 2 MECH., AV AND THEATRICAL LIGHTING **UPGRADES**

PROJECT NUMBER: 202331.00

CONSULTANT:

PHILLIPS+GOMEZ
MEP CONSULTING ENGINEERS
15 W 6th Street, Suite 2510
Tulsa, Oklahoma 74119
Telephone: 918-584-0102
Fax: 918-582-2819

Phillips + Gomez Oklahoma Certificate of Authority (Engineers) - #CA1395

	REV	'ISIONS:	
	No	Description	Date
Н			
ll			

SEAL:



ISSUE DATE: 01.24.2024

SHEET NUMBER:

E106

SIXTH FLOOR A/V PLAN