




1 DETAIL AT AV PANEL - TYPICAL SURFACE MOUNT
3" = 1'-0"

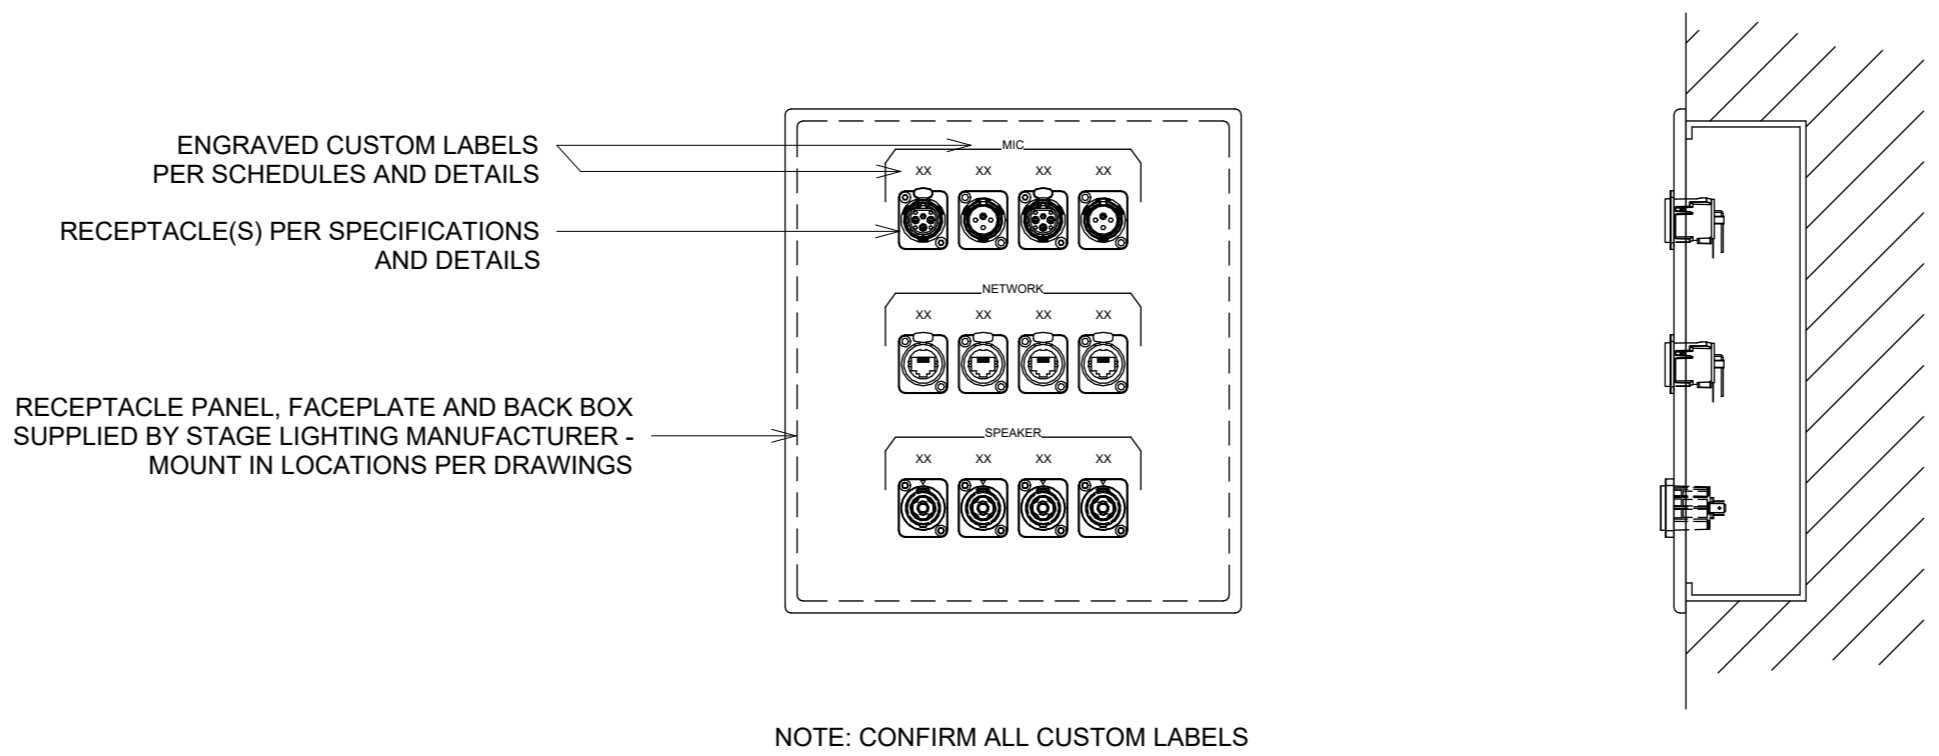


2 DETAIL AT AV PANEL - TYPICAL RECESSED
3" = 1'-0"

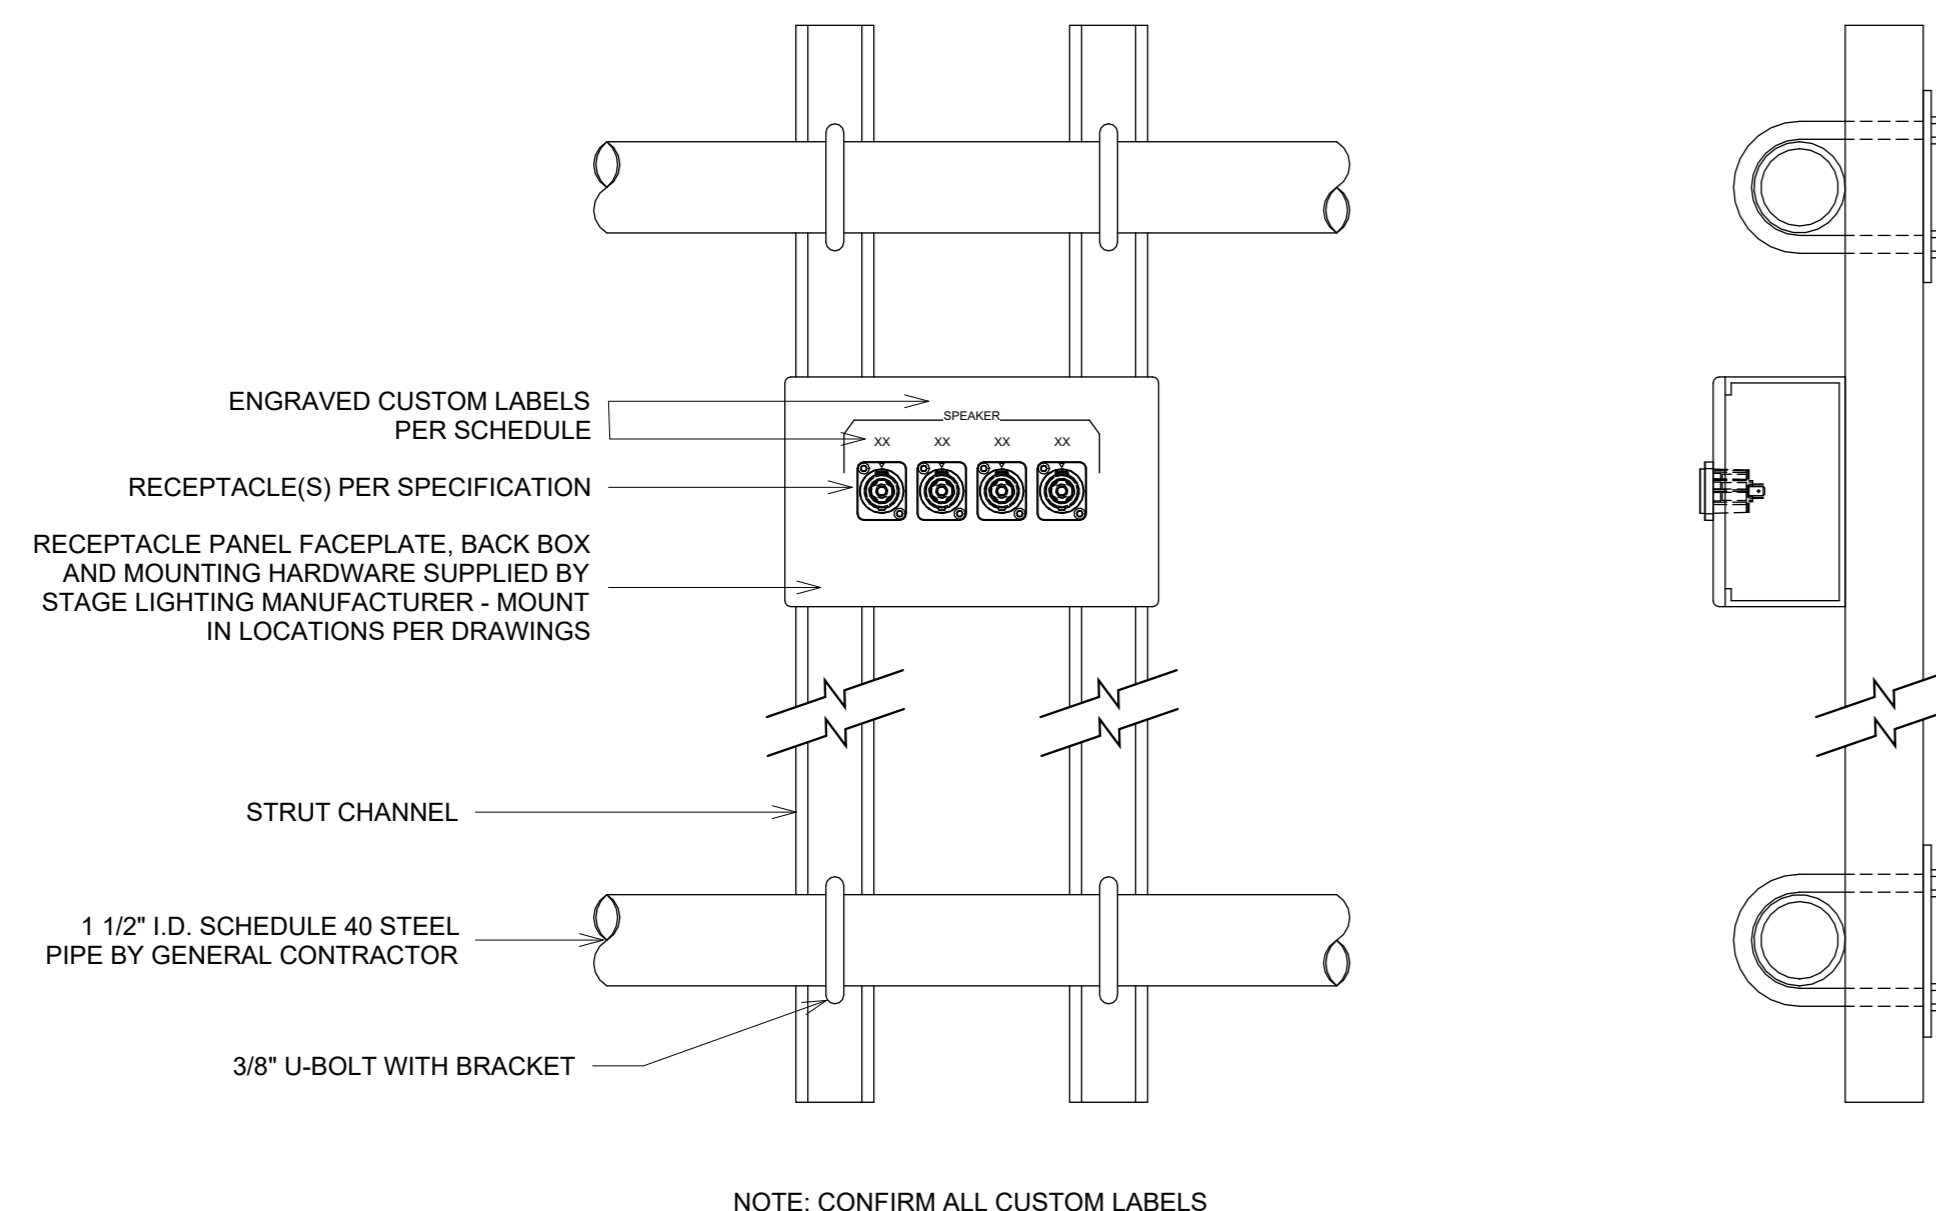


3 DETAIL AT AV PANEL - TYPICAL CATWALK RAIL MOUNT
3" = 1'-0"

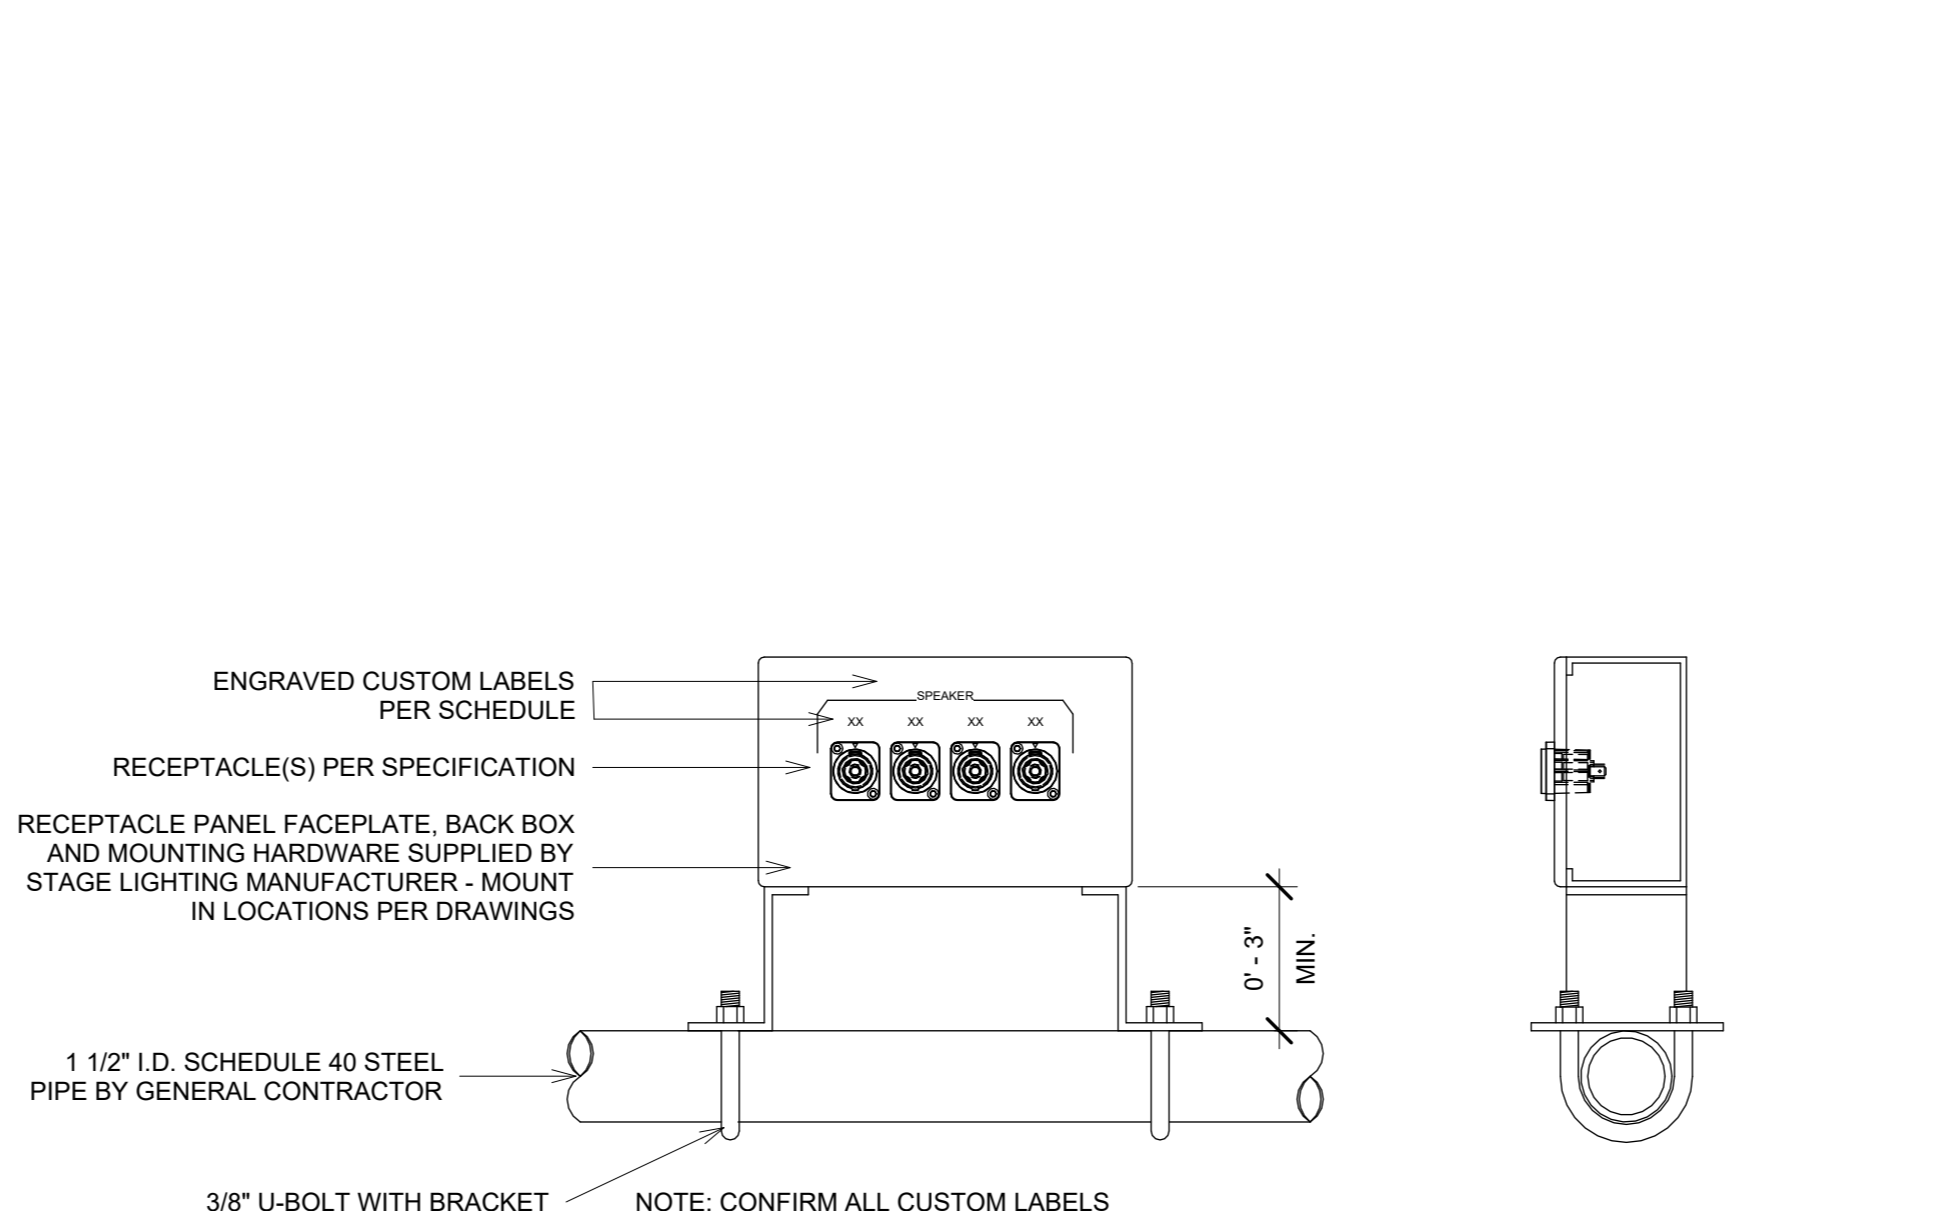


4 DETAIL AT AV PANEL - TYPICAL PIPE MOUNT
3" = 1'-0"

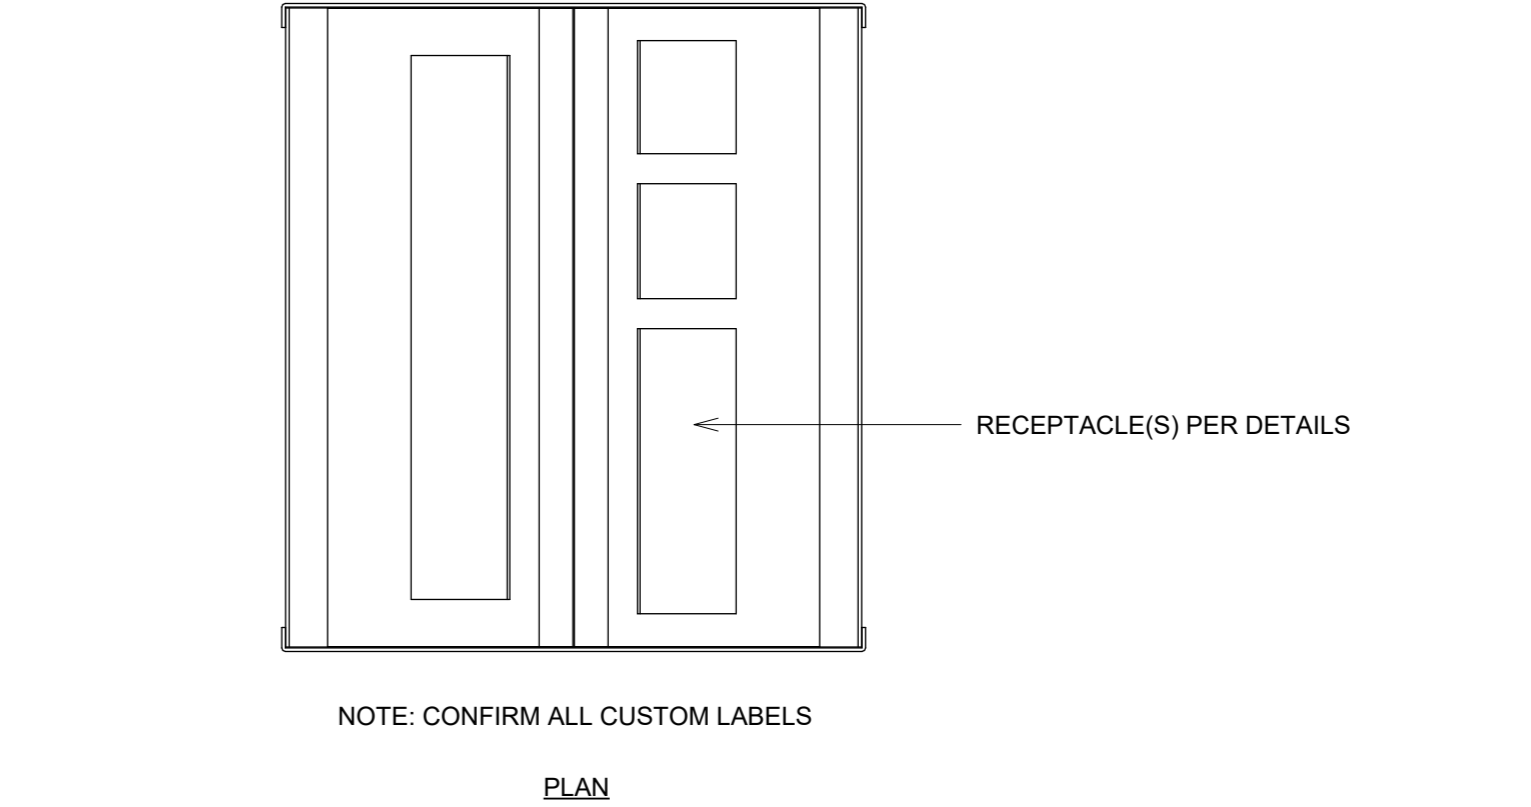

5 DETAIL AT AV PANEL - TYPICAL RECESSED FLOOR BOX
3" = 1'-0"

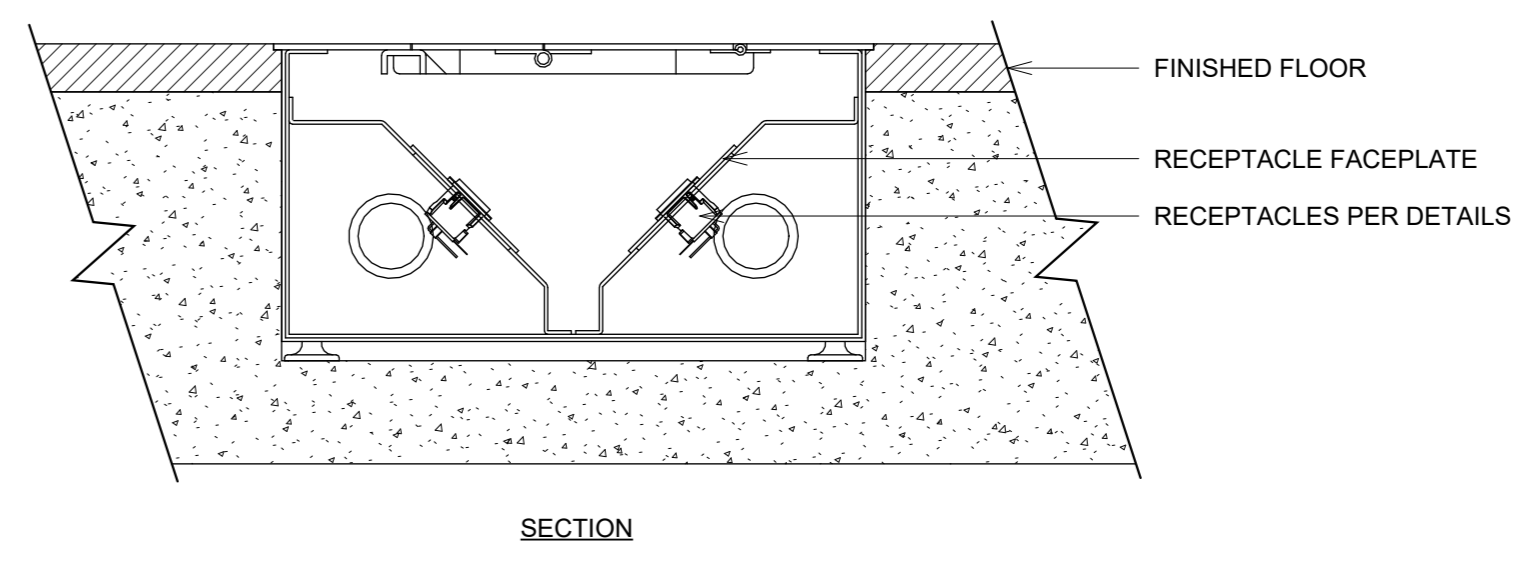

5 DETAIL AT AV PANEL - TYPICAL RECESSED FLOOR BOX
3" = 1'-0"

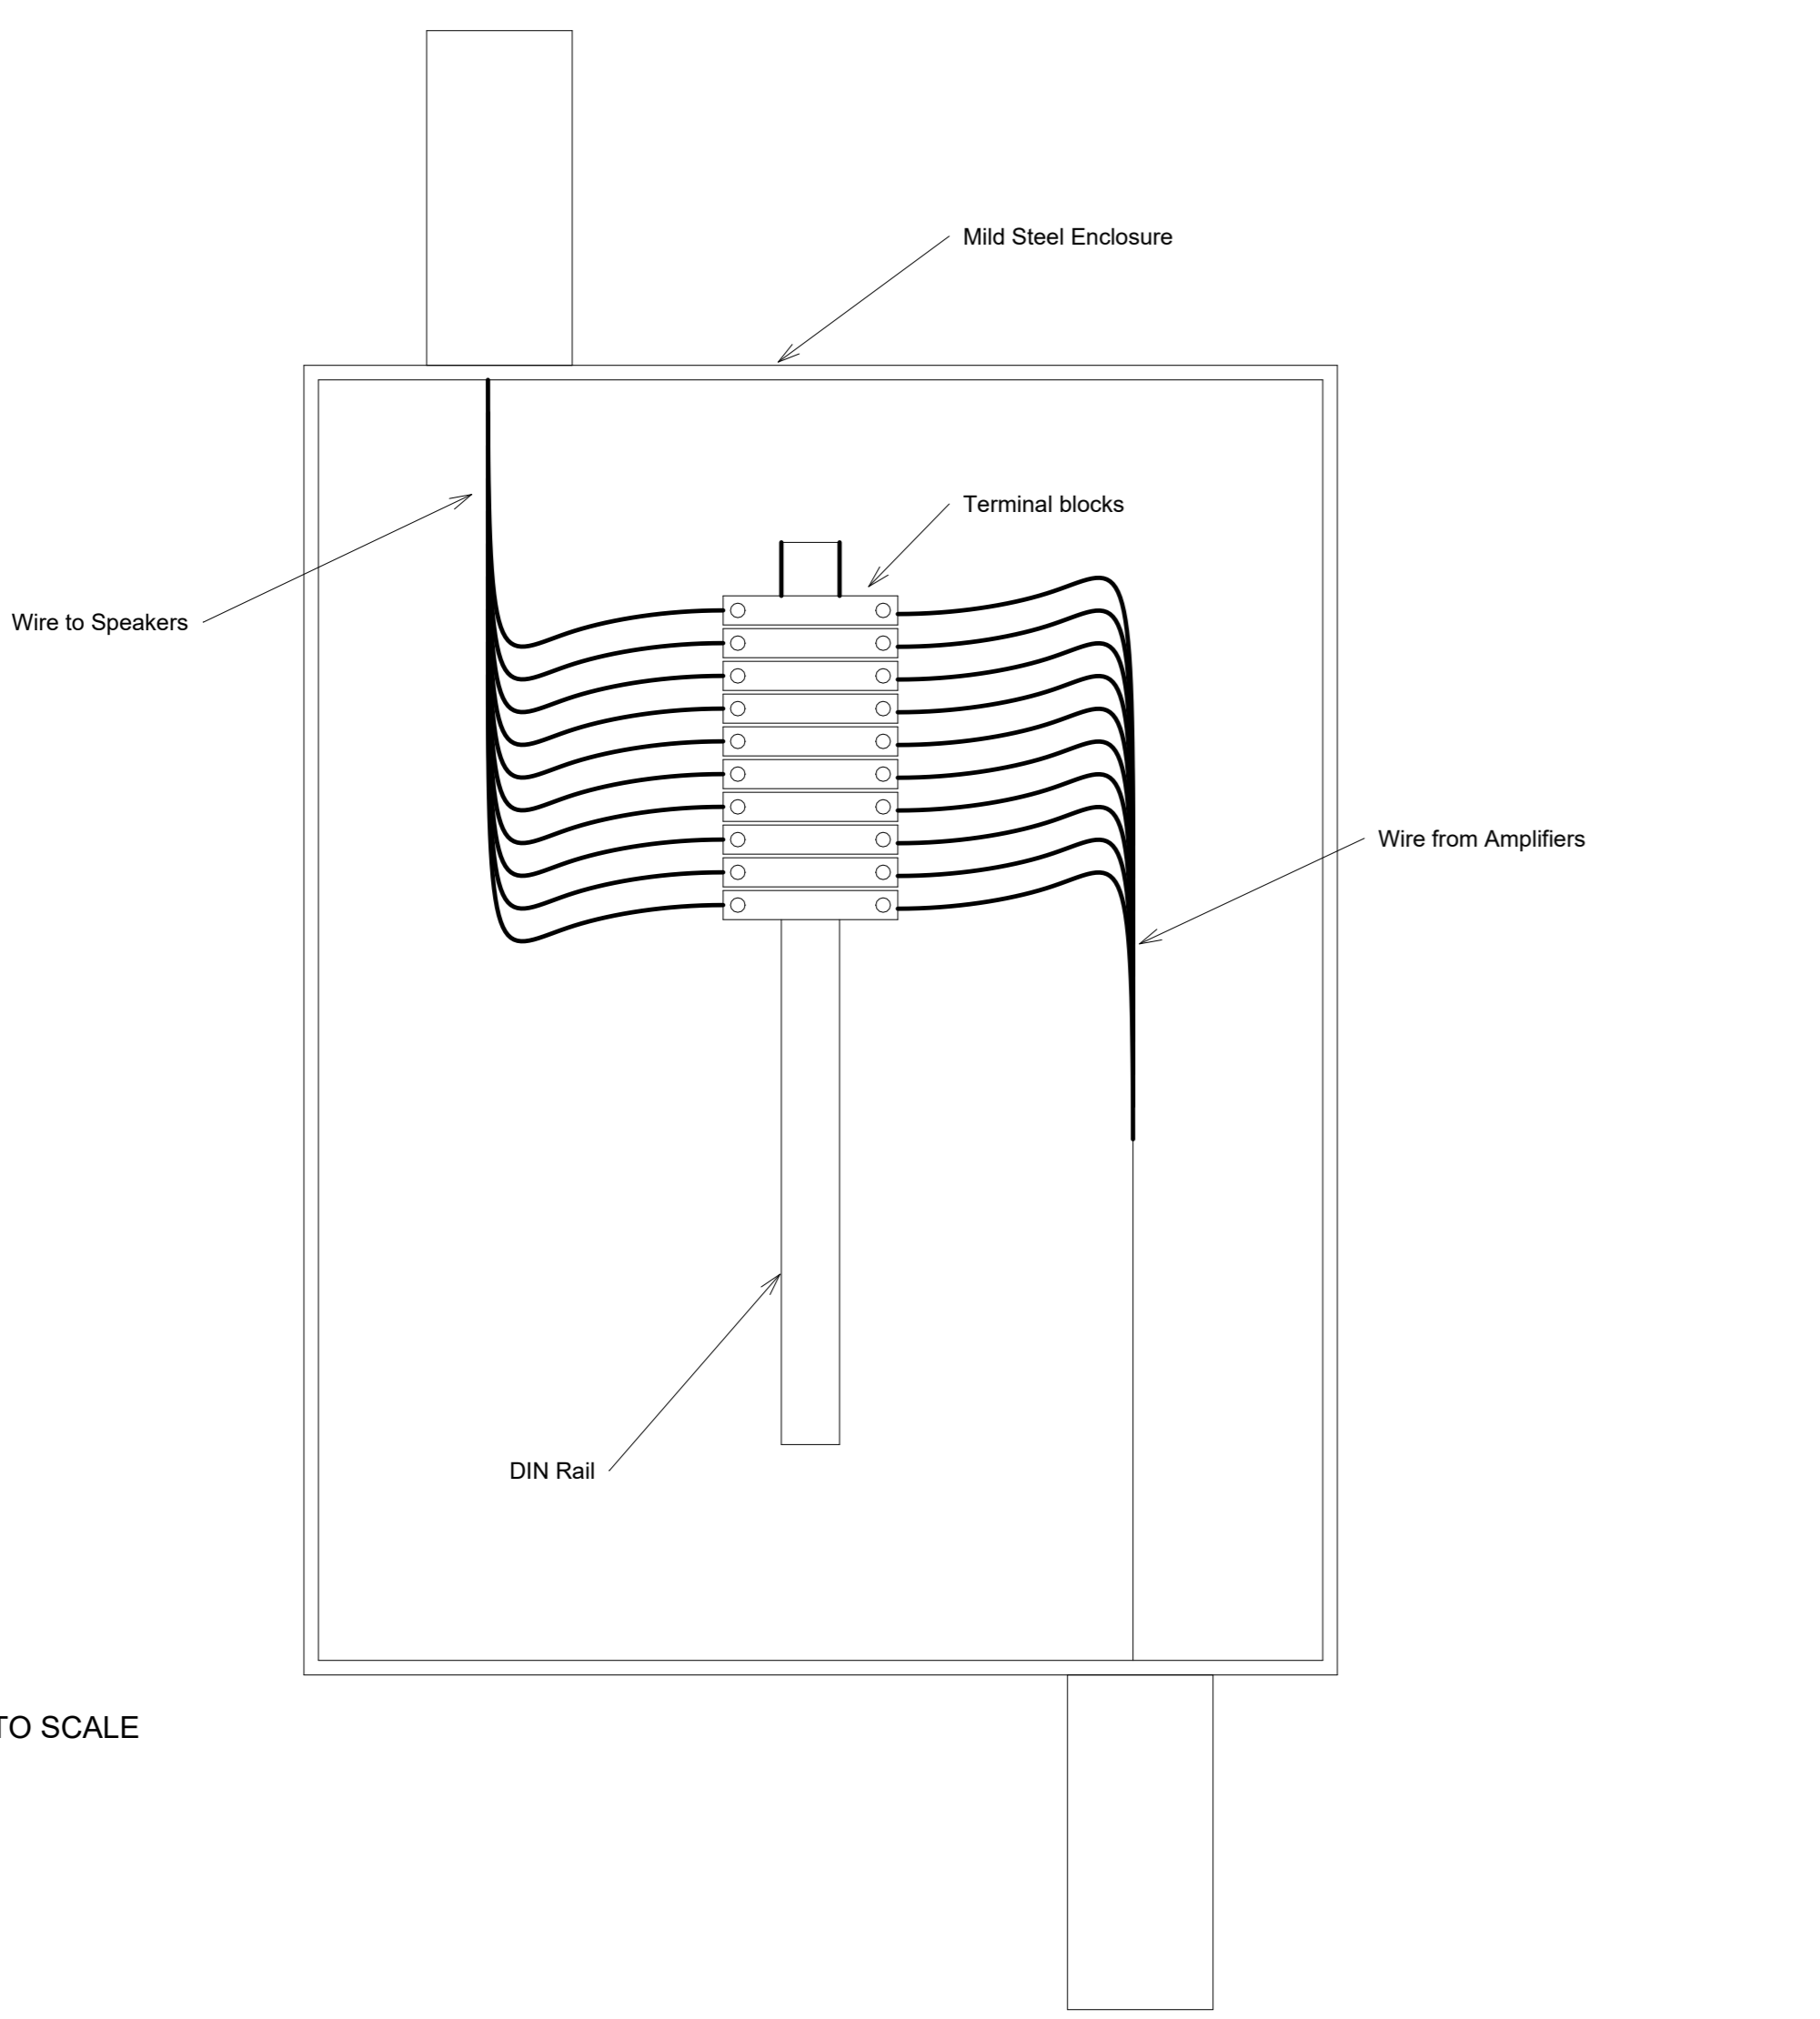

6 Loudspeaker Transfer Panel
1" = 1'-0"

KEY TO STANDARD CONNECTORS					
CONNECTOR	TYPE	FLOW	MANUFACTURER	MODEL	DESCRIPTION
	XLR	SEND	NEUTRIK	NC3MD-L-BAG-1	3 PIN XLR PANEL MOUNT BLACK 'MALE'
	XLR	RECEIVE	NEUTRIK	NC3FDM3-L-1-4	3 PIN XLR PANEL MOUNT BLACK 'FEMALE'
	CATEGORY	BI-DIRECTIONAL	NEUTRIK	NE8FDX-Y6	ETHERCON 8P8C SHIELDED CAT6A PANEL MOUNT BLACK MUST BE SUPPLIED WITH SPRING LOADED DUST CAPS
	FIBER	BI-DIRECTIONAL	NEUTRIK	NO2-4FDW-1-A	2 CORE OPTICALCON FIBER PANEL MOUNT BLACK MUST BE SUPPLIED WITH SPRING LOADED DUST CAPS
	BNC	SEND OR RECEIVE	NEUTRIK	NB875DFIB-6	1 PIN COAXIAL PANEL MOUNT BLACK 'FEMALE'
	HDMI	SEND OR RECEIVE	NEUTRIK	NAHDMI-W-B	HDMI PANEL MOUNT BLACK 'FEMALE'
	SPEAKER	SEND OR RECEIVE	NEUTRIK	NLT4MPXX	8 POSITION PANEL MOUNT BLACK 'MALE' METAL CHASSIS
	LINK	SEND OR RECEIVE DEPENDING ON CONFIGURATION	LINK	SIZE AND PIN CONFIGURATION AS NOTED	MULTIPIN LOCKING CONNECTOR AS CONFIGURED

CHECK ALL NOTES FOR ADDITIONAL INFORMATION ABOUT SPECIFIC CONNECTORS

7 Connectors
6" = 1'-0"



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AV011
AV STANDARD DETAILS

Audio Visual Conduit Schedule		
SIGNAL GROUP	DESTINATION	Min. Conduit Size
AMRK		
V	CRRK	1 1/4"
VI	CRRK	2"
BSGR		
V	AMRK	1 1/4"
V	CRRK	1 1/4"
BSNC		
V	AMRK	1 1/4"
V	CRRK	1 1/4"
BSTD		
V	AMRK	1 1/4"
V	CRRK	1 1/4"
CARK		
V	CRRK	1 1/4"
CLTP		
III	CARK	3"
CRCB		
V	CRRK	1 1/4"
CRMX		
V	CRRK	1 1/4"
HSBR		
V	CRRK	1 1/4"
HSMX		
V	CRRK	1 1/4"
LSCC		
III	LSTP	1 1/4"
LSCL		
III	LSTP	1 1/4"
LSDF		
III	CLTP	3/4"
LSDL		
III	LSTP	3/4"
LSML		
III	LSTP	2"
LSMN		
III	LSTP	2 1/2"
LSPR		
III	LSTP	1 1/4"
LSSB		
III	LSTP	1 1/4"
LSSF		
III	LSTP	1"
LSSL		
III	LSTP	1 1/4"
LSSR		
III	CLTP	3/4"
LSTP		
III	AMRK	4"
LSUB		
III	CLTP	3/4"
PITA		
V	AMRK	1 1/4"
V	CRRK	1 1/4"
STA2		
V	AMRK	1 1/4"
V	CRRK	1 1/4"
STAN		
V	AMRK	3/4"
STGA		
V	AMRK	1 1/4"
V	CRRK	1 1/4"
STGB		
V	AMRK	1 1/4"
V	CRRK	1 1/4"
STTR		
V	AMRK	1 1/4"
V	CRRK	1 1/4"
WBGR		
V	WCRK	1 1/4"
WCMX		
V	WCRK	1 1/4"
WCRK		
V	AMRK	1 1/4"
WHAN		
V	WCRK	3/4"
WHMX		
V	WCRK	1 1/4"
WPTA		
V	WCRK	1 1/4"
WSA2		
V	WCRK	1 1/4"
WSGA		
V	WCRK	1 1/4"
WSGB		
V	WCRK	1 1/4"

REFER TO AUDIO VIDEO BACK BOX SCHEDULE FOR QUANTITIES OF EACH TERMINATION ID

NOTES:

- AV CABLING CONDUIT HAS STRICT REQUIREMENTS REGARDING SIGNAL TYPES ALLOWED TO SHARE CONDUITS, SEPARATION OF CONDUITS FROM OTHER TYPES, AND OTHER SOURCES OF POTENTIAL INTERFERENCE, SUCH AS POWER CONDUITS, AND CONDUIT SIZING. THE CONDUIT SIZE SCHEDULE SHOWS THE QUANTITY, TYPES, AND SIZE OF CONDUIT NEEDED TO BRING CABLING TO EACH PARTICULAR TERMINATION BACK BOX AND PANEL. THE TERMINATION AND CONDUIT SIZE SCHEDULES ALSO INDICATE THE INTENDED DESTINATION OF EACH TYPE OF CABLING (CONDUIT) LISTED.
- ALL OF THIS INFORMATION IS PROVIDED SO THAT A PROPER CONDUIT SYSTEM DESIGN TO SUPPORT THE AV SYSTEMS CABLING CAN BE DESIGNED AND COORDINATED. IT IS IMPORTANT TO NOTE THAT IT IS NOT THE INTENTION THAT EACH CONDUIT SHOULD HOME RUN TO ITS DESTINATION. THIS IS OFTEN IMPOSSIBLE TO DO IN THE SPACE ALLOWED AND IS A VERY EXPENSIVE WAY TO PROVIDE CONDUIT FOR THE AV SYSTEMS. CONDUITS OF LIKE SIGNAL GROUPS (INDICATED AS GROUPS 1 THROUGH 6 IN THE SCHEDULES) MAY BE BROUGHT TOGETHER AT A JUNCTION BOX AND THEN A SINGLE LARGER CONDUIT CAN RUN FROM THERE TO THE DESTINATION(S). THIS IS A MORE EFFICIENT AND COST-EFFECTIVE WAY TO DESIGN A CONDUIT SYSTEM FOR THE AV CABLING. ALSO IMPORTANT TO NOTE, THE JUNCTION BOXES MUST BE SEPARATED BY SIGNAL GROUP AS WELL SO THAT ONLY ONE SIGNAL GROUP IS IN EACH JUNCTION BOX. DIVIDERS ARE NOT ALLOWED. CONDUIT SIZE ESTIMATION IS PROVIDED FOR BUDGETING ONLY. CONTRACTOR IS RESPONSIBLE FOR CALCULATING ALL FACTORS RELATING TO CONDUIT FILL, BEND RADIUS, AND ANY OTHER PARAMETERS.

Audio Visual Power Schedule					
Power ID	Volts	Amps	Phase	Receptacle Type	Receptacle QTY
AMRK					
AVIG	120V	30A	1PH	TAILS	7
CARK					
AVIG	120V	30A	1PH	TAILS	3



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AV031
AV SCHEDULES 1

Audio Visual Termination Schedule				
SIGNAL GROUP	CODE	WIRE QTY	DESTINATION	SPARES
AMRK				
V	60M4	2	CRRK	0
V	STP	4	CRRK	1
VI	COND2	0	CRRK	0
BSGR				
V	60M4	2	CRRK	0
V	STP	4	AMRK	1
BSNC				
V	60M4	2	CRRK	0
V	STP	4	AMRK	1
BSTD				
V	60M4	2	CRRK	0
V	STP	4	AMRK	1
CARK				
V	60M4	2	CRRK	0
V	STP	4	CRRK	1
CLTP				
III	SP12	46	CARK	5
CRCB				
V	60M4	2	CRRK	0
V	STP	4	CRRK	1
CRMX				
V	60M4	2	CRRK	0
V	STP	4	CRRK	1
HSBR				
V	60M4	2	CRRK	0
V	STP	4	CRRK	1
HSMX				
V	60M4	2	CRRK	0
V	STP	4	CRRK	1
LSCC				
III	SP10	6	LSTP	1
LSCL				
III	SP10	4	LSTP	1
LSDF				
III	SP10	1	CLTP	1
LSDL				
III	SP10	1	LSTP	1
LSML				
III	SP10	12	LSTP	2
LSMN				
III	SP10	16	LSTP	2
LSPR				
III	SP10	4	LSTP	1
LSSB				
III	SP10	4	LSTP	1
LSSF				
III	SP10	2	LSTP	1
LSSL				
III	SP10	4	LSTP	1
LSSR				
III	SP10	1	CLTP	1
LSTP				
III	SP12	112	AMRK	6
LSUB				
III	SP10	1	CLTP	1
PITA				
V	60M4	2	CRRK	0
V	STP	4	AMRK	1
STA2				
V	60M4	2	CRRK	0
V	STP	4	AMRK	1
STAN				
V	STP	1	AMRK	1
STGA				
V	60M4	2	CRRK	0
V	STP	4	AMRK	1
STGB				
V	60M4	2	CRRK	0
V	STP	4	AMRK	1
STTR				
V	60M4	2	CRRK	0
V	STP	4	AMRK	1
WBGR				
V	60M4	2	WCRK	0
V	STP	4	WCRK	1
WCMX				
V	60M4	2	WCRK	0
V	STP	4	WCRK	1
WCRK				
V	60M4	2	AMRK	0
V	STP	4	AMRK	1
WHAN				
V	STP	1	WCRK	1
WHMX				
V	60M4	2	WCRK	0
V	STP	4	WCRK	1
WPTA				
V	60M4	2	WCRK	0
V	STP	4	WCRK	1
WSA2				
V	60M4	2	WCRK	0
V	STP	4	WCRK	1
WSGA				
V	60M4	2	WCRK	0
V	STP	4	WCRK	1
WSGB				
V	60M4	2	WCRK	0
V	STP	4	WCRK	1

NOTE: REFER TO AUDIO VIDEO BACK BOX SCHEDULE FOR QUANTITIES OF EACH TERMINATION ID

Audio Video Back Box Schedule						
Termination ID	FUNCTION	QTY	Box Size	Elevation from Level	Key	Note
AMRK	AMP RACK	1	(none)	-19' - 6"	L	SEE RACK ELEVATION FOR DETAILS, LOCATED AT "THE ROCK"
BSGR	BACKSTAGE GREEN ROOM	1	6X8X6	2' - 0"	K	SITE VERIFY LOCATION
BSNC	BACKSTAGE NETWORK CLOSET	1	6X8X6	2' - 0"		
BSTD	BACKSTAGE TECHNICAL OFFICE	1	8X8X6	2' - 0"	K	SITE VERIFY LOCATION
CARK	CONTROL ROOM AMP RACK	1	(none)	0' - 0"	A	SEE RACK ELEVATION FOR DETAILS
CLTP	CONTROL ROOM LOUDSPEAKER TRANSFER PANEL	1	(none)	0' - 0"	B	SEE STANDARD DETAIL
CRCB	CONTROL CENTER BOOTH	1	6X8X6	2' - 0"		
CRMX	CONTROL ROOM MIX	1	6X8X6	2' - 0"		
CRRK	CONTROL ROOM RACK	1	(none)	2' - 0"	A	SEE RACK ELEVATION FOR DETAILS
HSMX	HOUSE MIX	1	6X8X6	2' - 0"		
LSCC	CENTER CLUSTER LOUDSPEAKER	1	8X8X6	6' - 0"		
LSCL	CENTER DELAY LOUDSPEAKER	1	6X6X6	0' - 0"		
LSDF	DELAY FILL LOUDSPEAKER	2	1 GANG	<varies>	G	RCP UNAVAILABLE, SITE VERIFY CEILING CONDITION
LSDL	DELAY LOUDSPEAKER	2	1 GANG	15' - 0"		
LSML	MAIN DELAY LOUDSPEAKER	2	8X8X6	0' - 0"		
LSMN	MAIN LOUDSPEAKER	2	10X8X6	-16' - 6"	H	SEE TR DRAWINGS FOR WINCH REQUIRED, ARRAY MUST FIT THROUGH THE ACOUSTIC PANEL
LSPR	PIT RAIL LOUDSPEAKER	2	1 GANG	2' - 0"	C	CUSTOM CABLE LOOM TO PIT RAIL SPEAKERS REQUIRED, PIT RAIL SPEAKER TO BE BUILT INTO FUTURE REBUILD OF PIT RAIL
LSSB	SUBWOOFER LOUDSPEAKER	1	6X6X6	6' - 0"		
LSSF	SIDE FILL LOUDSPEAKER	2	1 GANG	<varies>		
LSSL	STAGE LIP LOUDSPEAKER	2	1 GANG	2' - 0"	D	CUSTOM CABLE LOOM TO STAGE LIP SPEAKERS REQUIRED
LSSR	SURROUND LOUDSPEAKER	36	1 GANG	<varies>		
LSSR	SURROUND LOUDSPEAKER	2	1 GANG	8' - 0"	F	COORDINATE POSITIONS WITH ARCHITECT TO MINIMIZE AESTHETIC IMPACT
LSSR	SURROUND LOUDSPEAKER	4	1 GANG	-13' - 4"	J	POSITIONS TO BE AT THE FRONT OF THE PLATFORM, PLATFORM MUST BE CLEAR
LSTP	LOUDSPEAKER TRANSFER PANEL	1	12X8X4	5' - 0"	M	SEE STANDARD DETAIL, LOCATED AT "THE ROCK"
LSUB	UNDERBALCONY LOUDSPEAKER	7	1 GANG	8' - 0"		
PITA	PIT TYPE A	2	6X8X6	2' - 0"	E	SITE VERIFY POSITION FOR PIT PANELS, POSSIBLY MATCH CURRENT ANALOG CONNECTION LOCATIONS
STA2	STAGE A2	1	6X8X6	2' - 0"		
STAN	STAGE ANTENNA	1	(none)	10' - 0"		
STGA	STAGE A DS	2	6X8X6	2' - 0"		
STGB	STAGE B US	2	6X8X6	2' - 0"		
STTR	STAGE TRAP ROOM	1	6X8X6	2' - 0"		
WBGR	WILLIAMS GREEN ROOM	1	6X8X6	2' - 0"	K	SITE VERIFY LOCATION
WCMX	WILLIAMS CONTROL RM MIX	1	6X8X6	2' - 0"		
WCRK	WILLIAMS CONTROL RM RACK	1	(none)	7' - 0"	A	SEE RACK ELEVATION FOR DETAILS
WHAN	WILLIAMS STAGE ANTENNA	1	2 GANG	10' - 0"		
WHMX	WILLIAMS HOUSE MIX	1	6X8X6	2' - 0"		
WPTA	WILLIAMS PIT TYPE A	2	6X8X6	2' - 0"	E	SITE VERIFY POSITION FOR PIT PANELS, POSSIBLY MATCH CURRENT ANALOG CONNECTION LOCATIONS
WSA2	WILLIAMS STAGE A2	1	6X8X6	2' - 0"		
WSGA	WILLIAMS STAGE A	2	6X8X6	2' - 0"		
WSGB	WILLIAMS STAGE B	2	6X8X6	2' - 0"		

NOTE:

- CONFIRM MOUNTING AND COLORS OF ALL PANELS WITHIN AUDIENCE OR CAMERA VIEW WITH ARCHITECT
- ELEVATION FROM LEVEL IS DEFINED AS HEIGHT ABOVE FINISHED FLOOR TO CENTER OF THE BACK BOX



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SHEET NUMBER:
AV032
AV SCHEDULES 2

PROJECT:
TULSA
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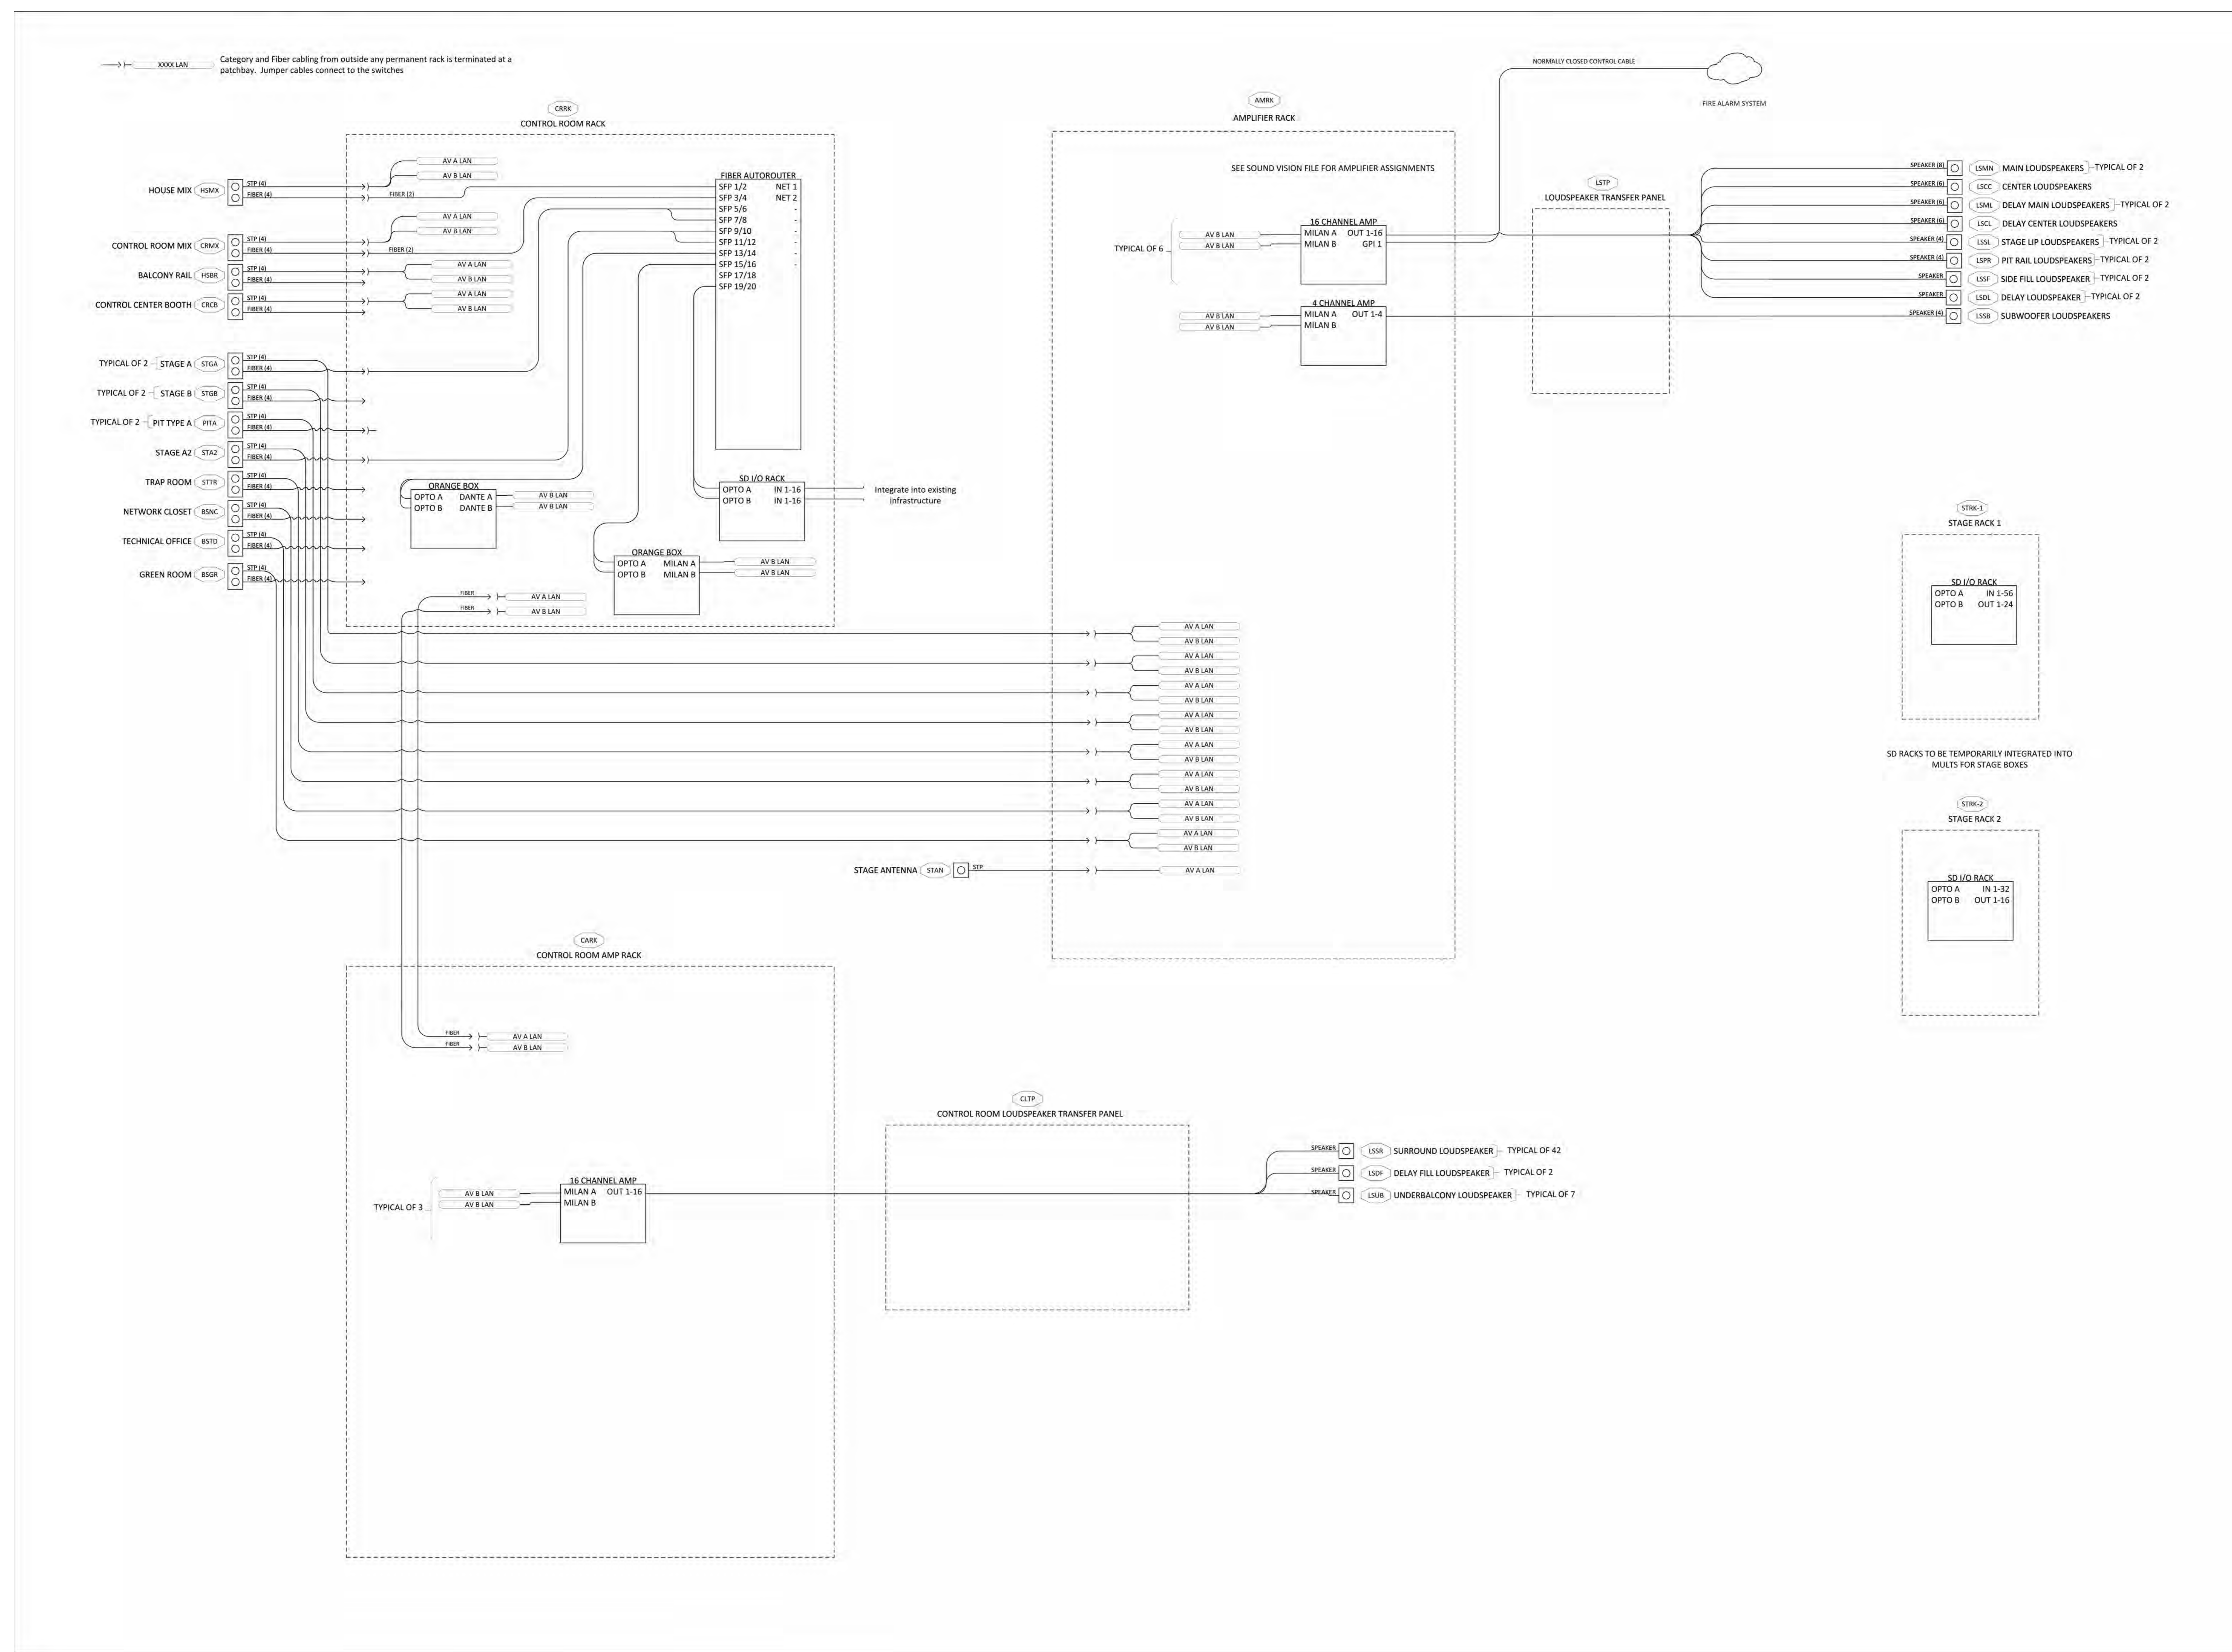
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SHEET NUMBER:
AV051
AV SINGLE LINE -
CHAPMAN



PROJECT:
TULSA
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202331.00

CONSULTANT:



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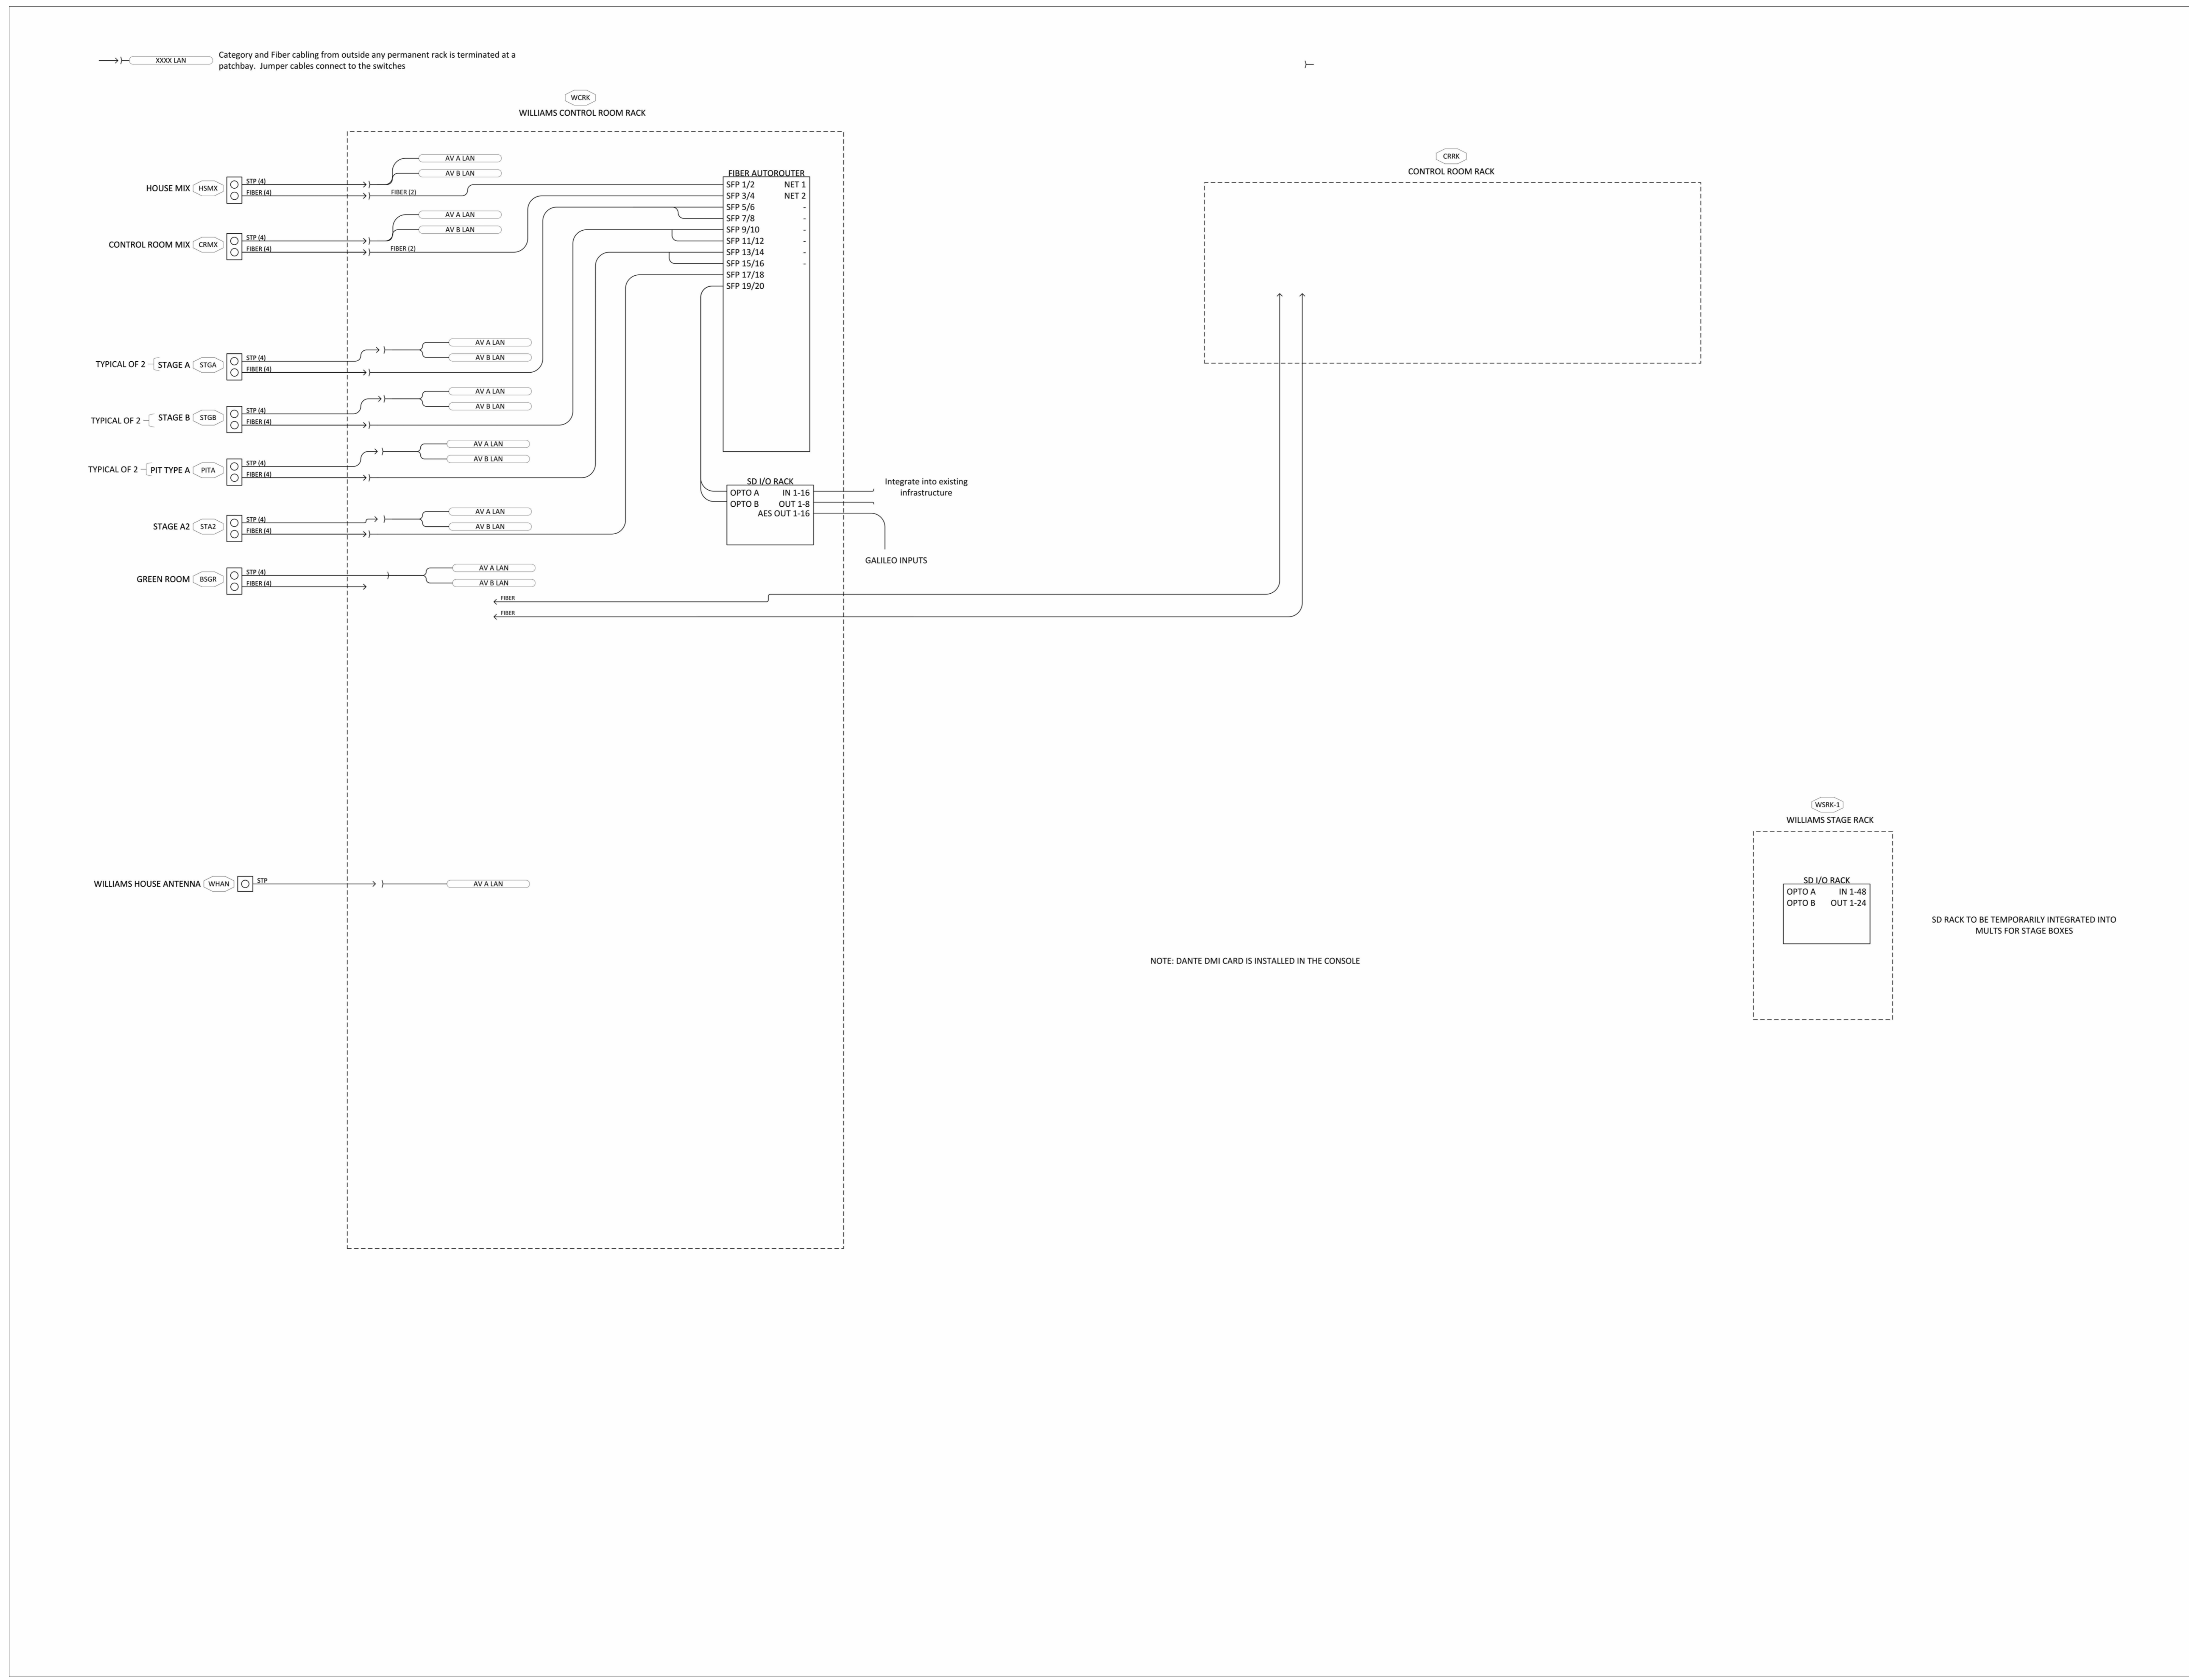
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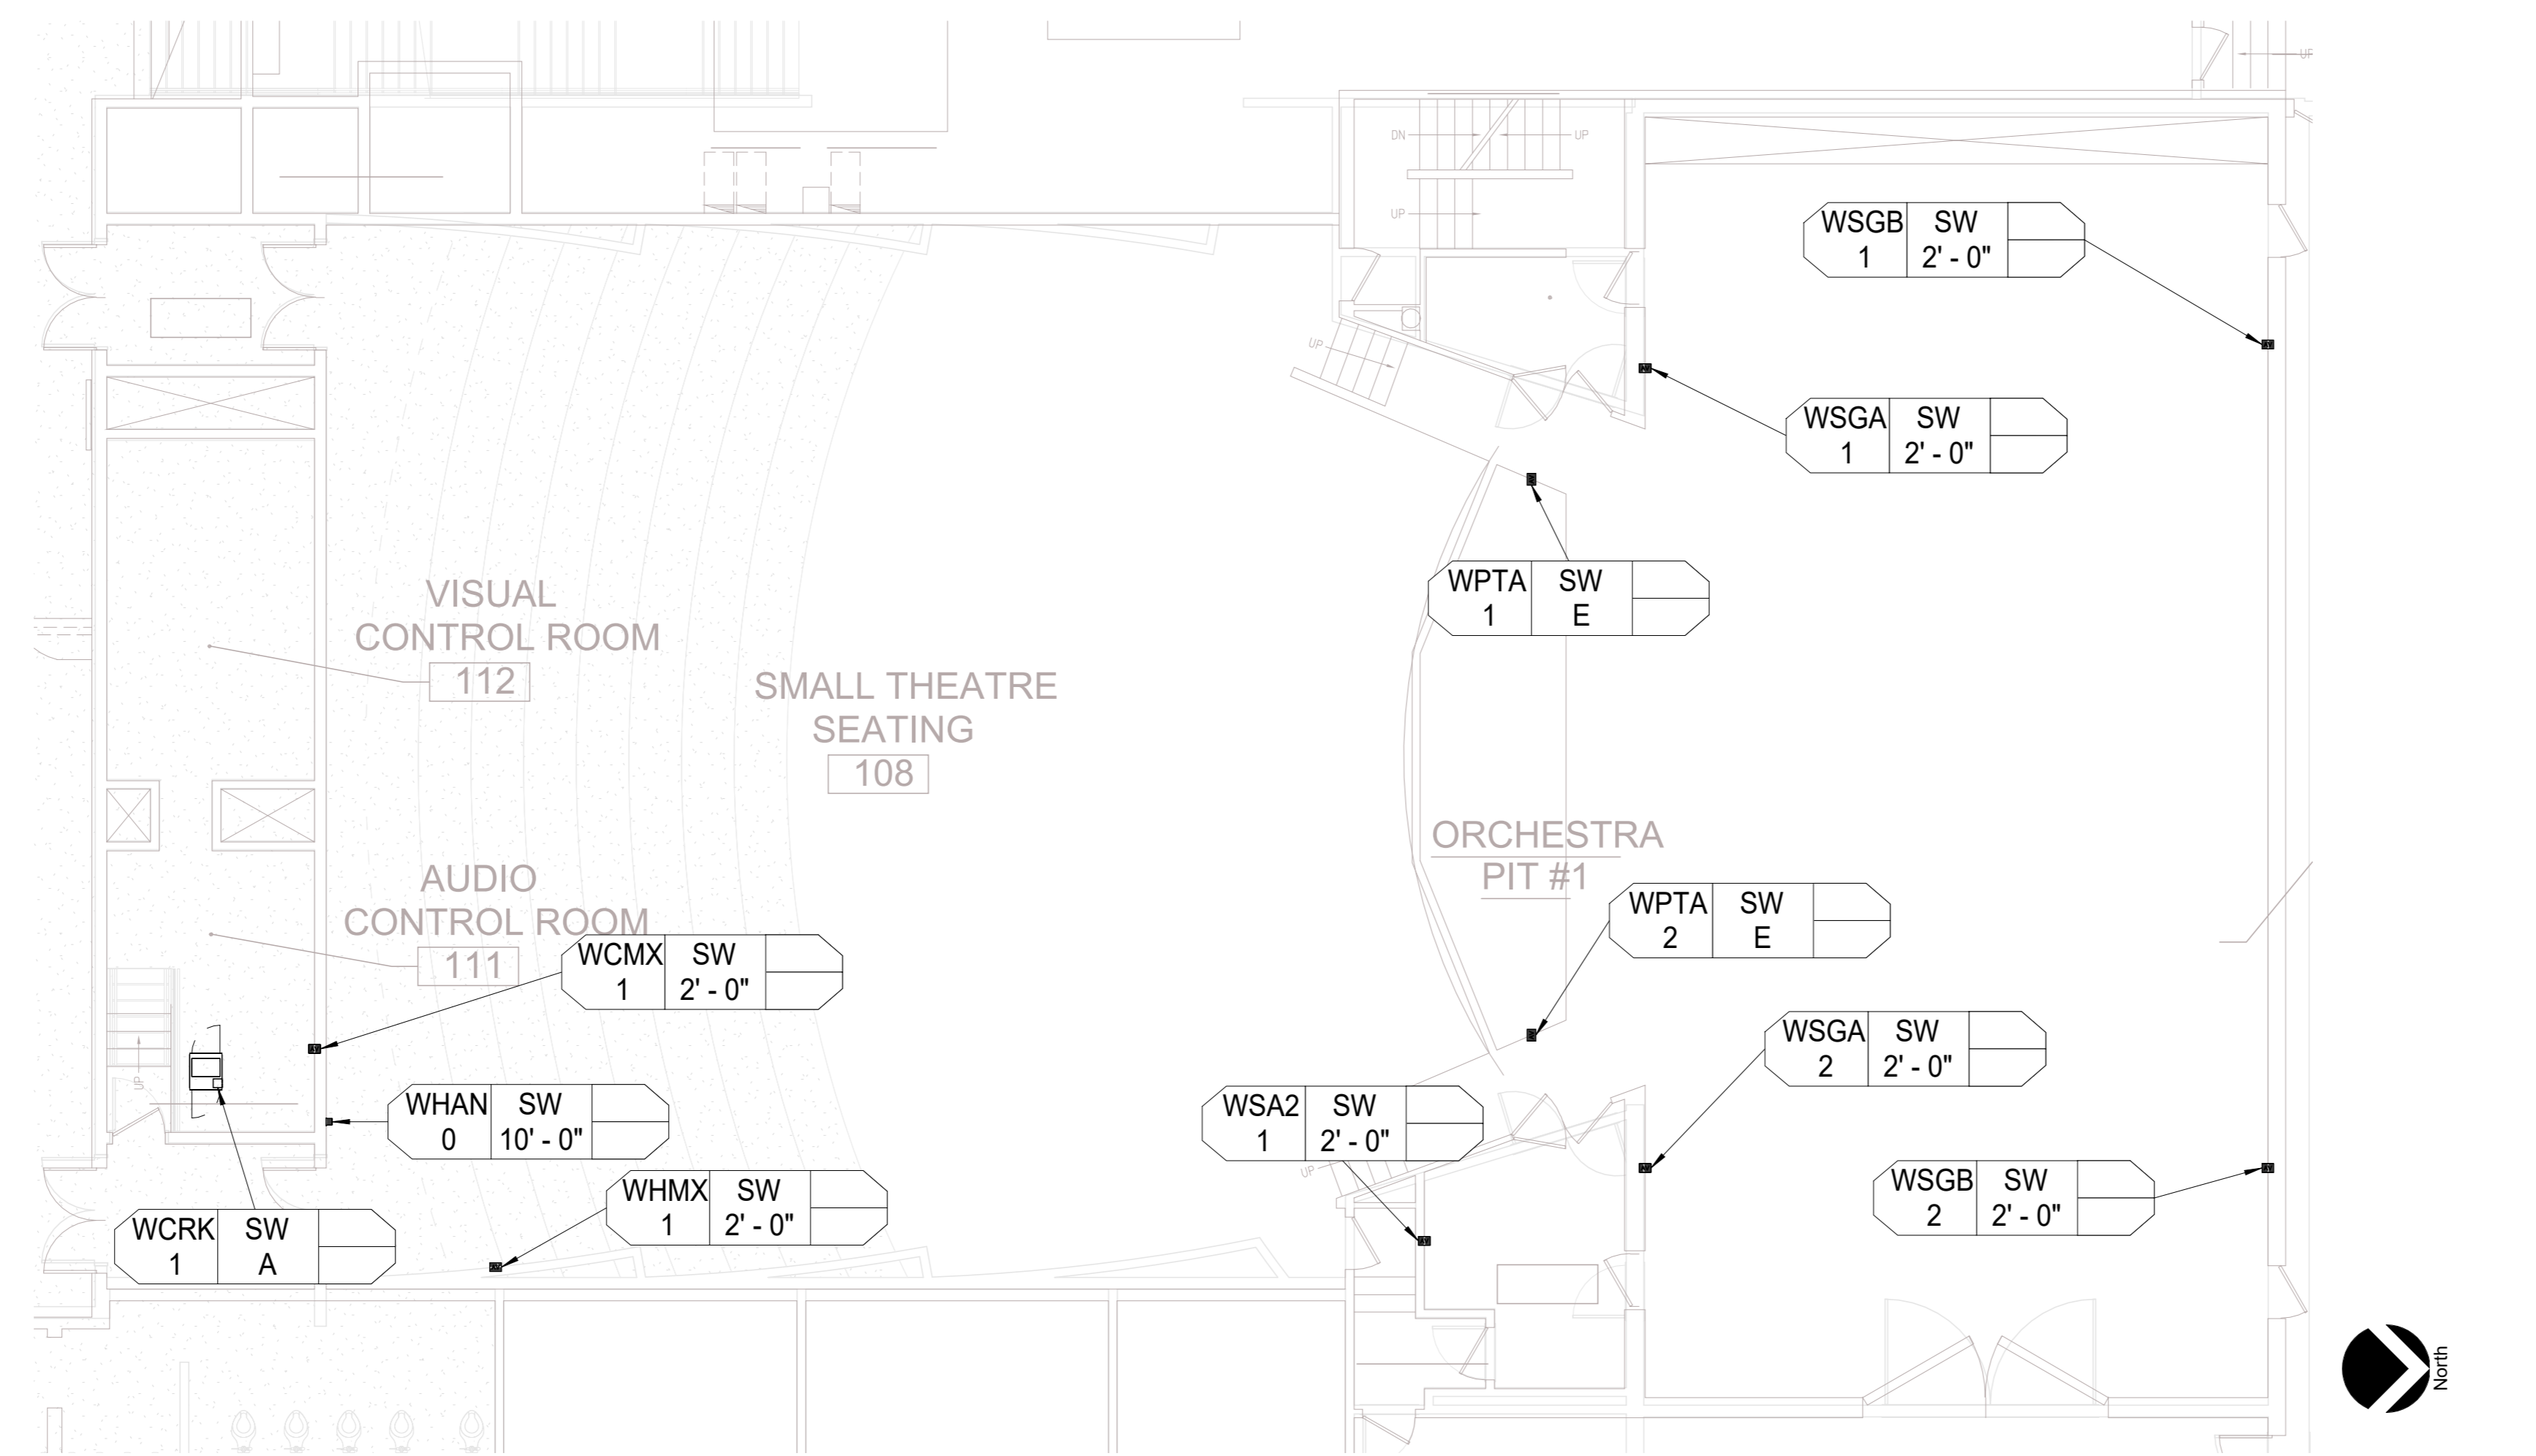
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SHEET NUMBER:
AV052

AV SINGLE LINE -
WILLIAMS



KEYED NOTES	
KEY	NOTE
A	SEE RACK ELEVATION FOR DETAILS
B	SEE STANDARD DETAIL
C	CUSTOM CABLE LOOM TO PIT RAIL SPEAKERS REQUIRED, PIT RAIL SPEAKER TO BE BUILT INTO FUTURE REBUILD OF PIT RAIL
D	CUSTOM CABLE LOOM TO STAGE LIP SPEAKERS REQUIRED
E	SITE VERIFY POSITION FOR PIT PANELS, POSSIBLY MATCH CURRENT ANALOG CONNECTION LOCATIONS
F	COORDINATE POSITIONS WITH ARCHITECT TO MINIMIZE AESTHETIC IMPACT
G	RCP UNAVAILABLE, SITE VERIFY CEILING CONDITION
H	SEE TR DRAWINGS FOR WINCH REQUIRED, ARRAY MUST FIT THROUGH THE ACOUSTIC PANEL
J	POSITIONS TO BE AT THE FRONT OF THE PLATFORM, PLATFORM MUST BE CLEAR
K	SITE VERIFY LOCATION
L	SEE RACK ELEVATION FOR DETAILS, LOCATED AT "THE ROCK"
M	SEE STANDARD DETAIL, LOCATED AT "THE ROCK"



① LEVEL 1 WILLIAMS
1/8" = 1'-0"



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REVISIONS:

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1.24.2024

SHEET NUMBER:
AV101
AV 1ST FLOOR PLAN -
WILLIAMS

KEYED NOTES	
KEY	NOTE
A	SEE RACK ELEVATION FOR DETAILS
B	SEE STANDARD DETAIL
C	CUSTOM CABLE LOOM TO PIT RAIL SPEAKERS REQUIRED, PIT RAIL SPEAKER TO BE BUILT INTO FUTURE REBUILD OF PIT RAIL
D	CUSTOM CABLE LOOM TO STAGE LIP SPEAKERS REQUIRED
E	SITE VERIFY POSITION FOR PIT PANELS, POSSIBLY MATCH CURRENT ANALOG CONNECTION LOCATIONS
F	COORDINATE POSITIONS WITH ARCHITECT TO MINIMIZE AESTHETIC IMPACT
G	RCP UNAVAILABLE, SITE VERIFY CEILING CONDITION
H	SEE TR DRAWINGS FOR WINCH REQUIRED, ARRAY MUST FIT THROUGH THE ACOUSTIC PANEL
J	POSITIONS TO BE AT THE FRONT OF THE PLATFORM, PLATFORM MUST BE CLEAR
K	SITE VERIFY LOCATION
L	SEE RACK ELEVATION FOR DETAILS, LOCATED AT "THE ROCK"
M	SEE STANDARD DETAIL, LOCATED AT "THE ROCK"



① LEVEL 3 CHAPMAN
1/8" = 1'-0"

- NOTES:
- ALL SPEAKER LOCATIONS MUST BE FIELD VERIFIED TO CONFIRM LOCAL CONDITIONS.
 - SPEAKER HEIGHT ABOVE FINISHED FLOOR ARE GUIDELINES FOR CREATING SMOOTH COVERAGE ACROSS THE SEATING AREA, LOCAL CONDITIONS MAY REQUIRE VARIANCES.
 - IT IS THE INTENT OF THIS DESIGN TO REUSE AS MUCH EXISTING SPEAKER WIRING AS POSSIBLE. A FULL EVALUATION OF THE CURRENT TYPE, SIZE, ROUTING, AND AGE OF THE INSTALLED WIRE MUST BE PERFORMED.



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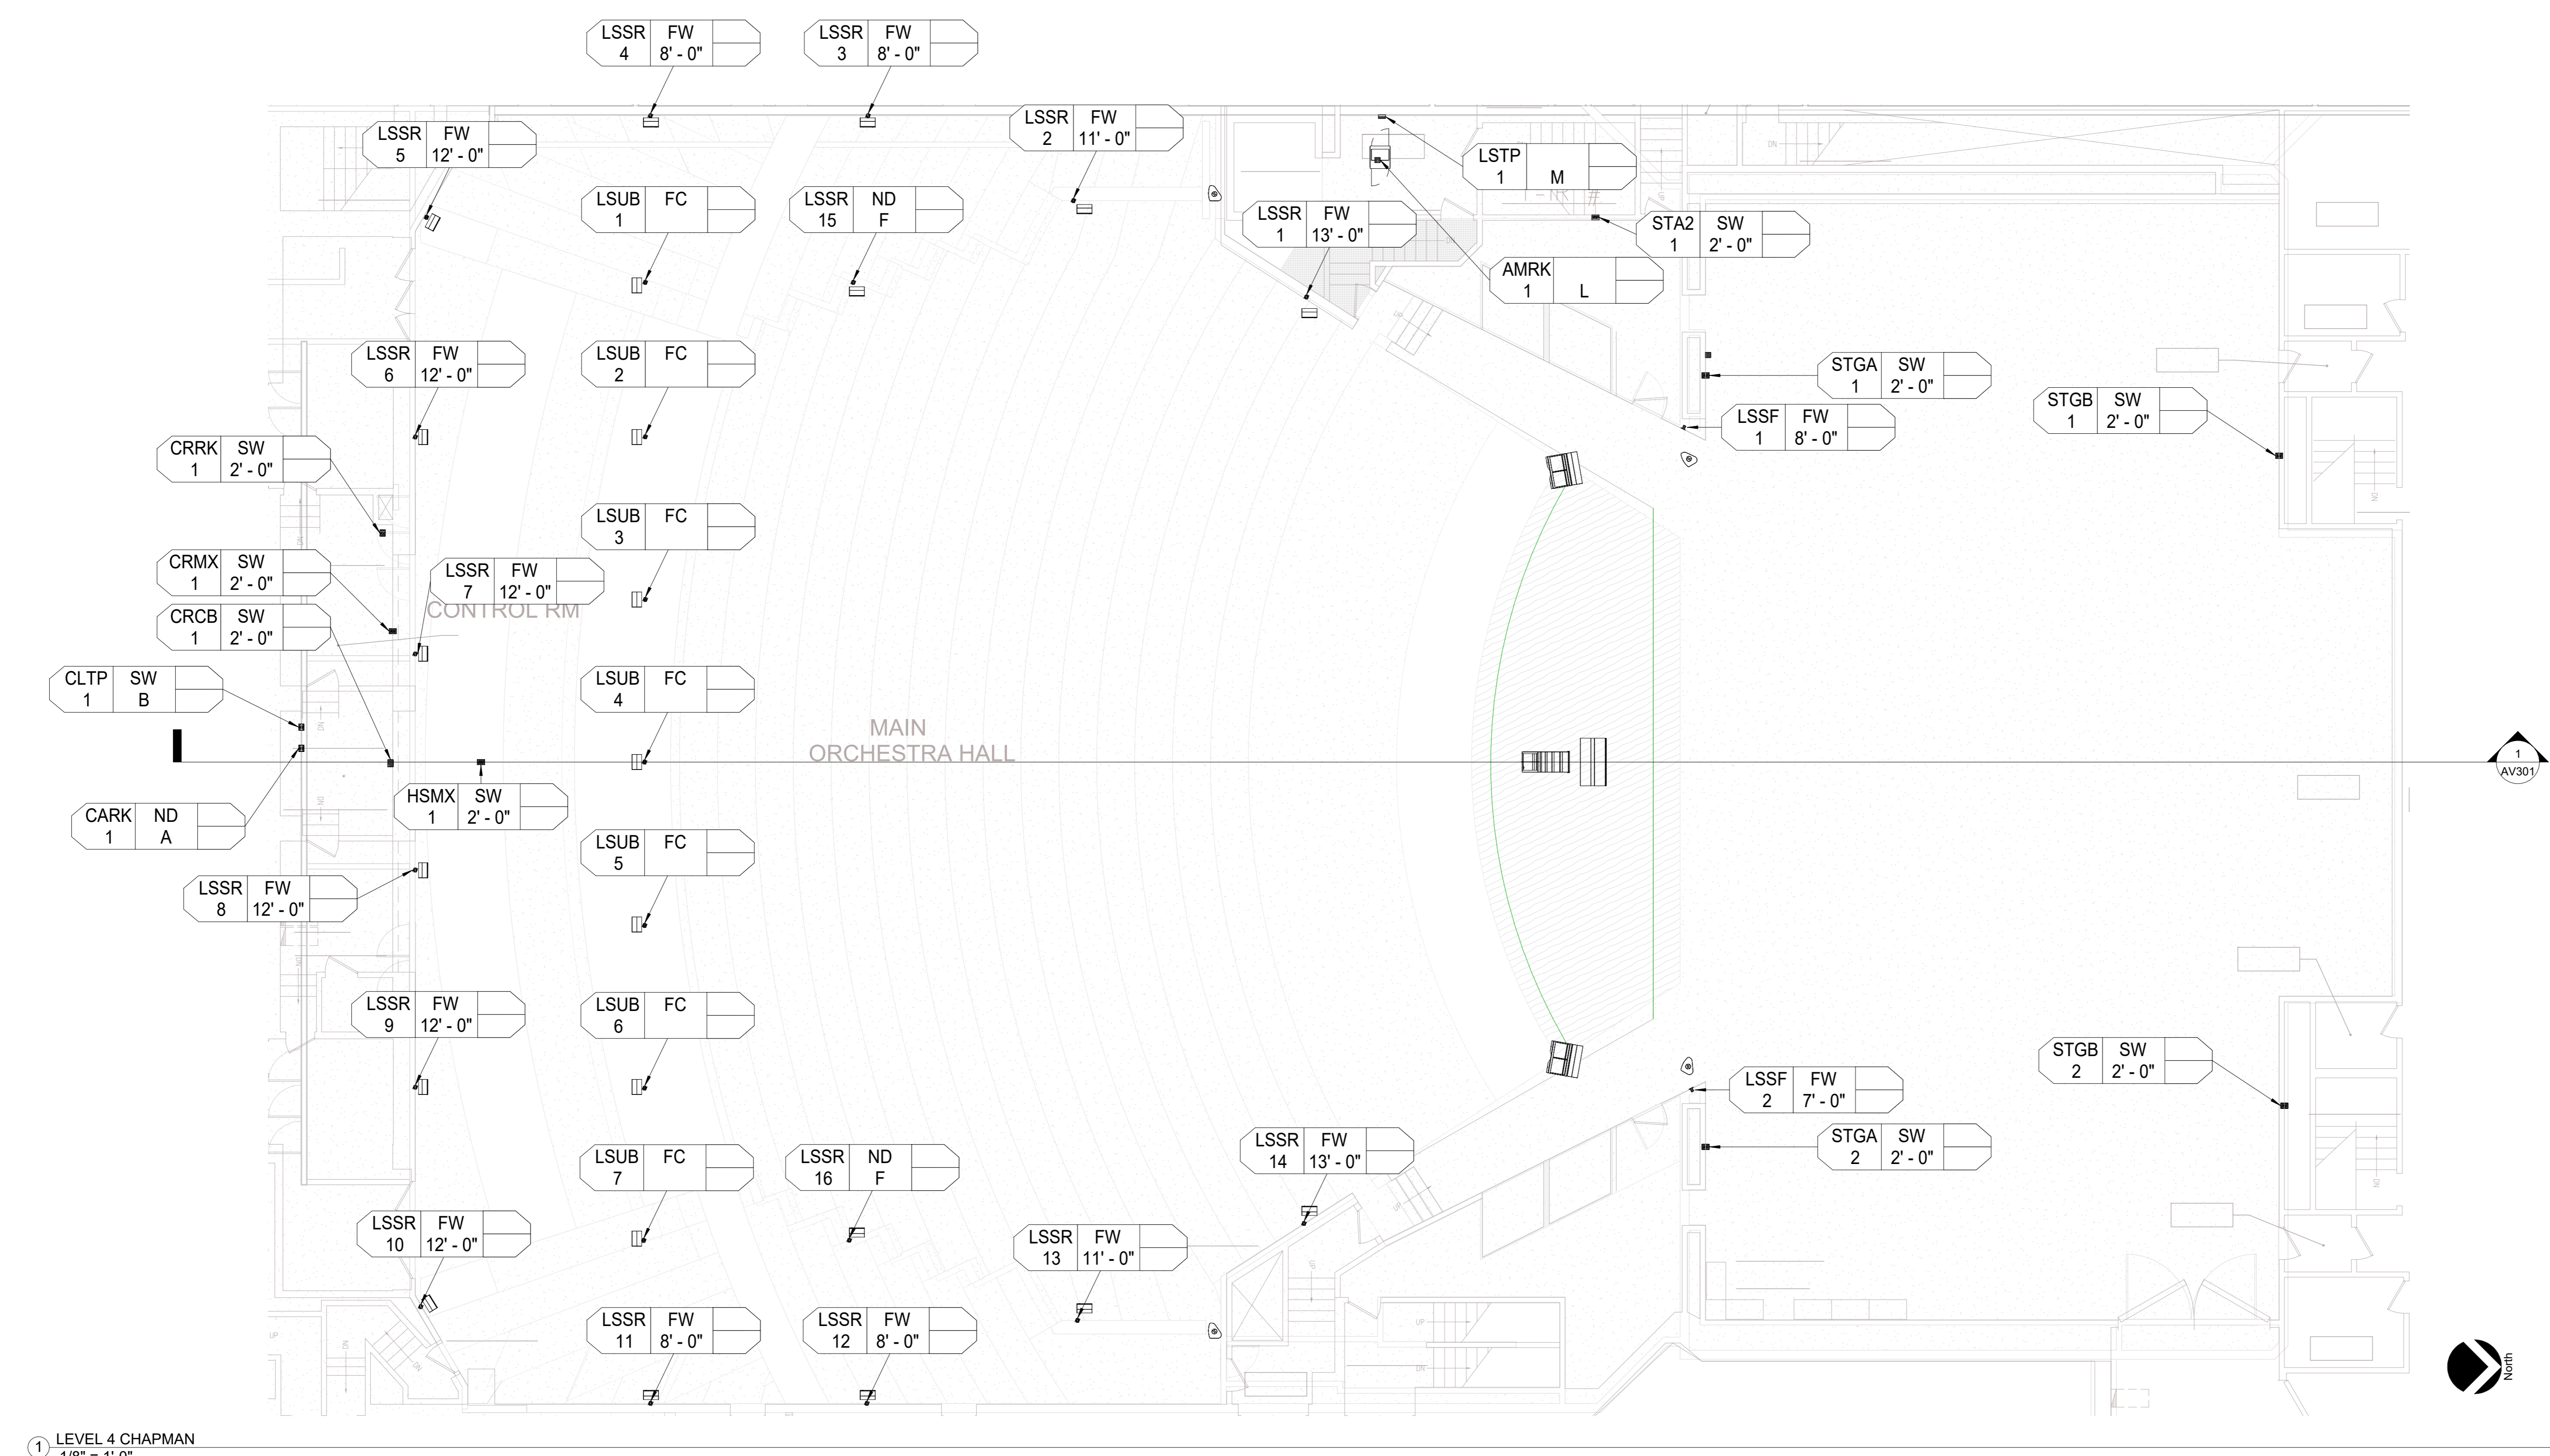
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AV103


AV 3rd FLOOR PLAN -
CHAPMAN

KEYED NOTES	
KEY	NOTE
A	SEE RACK ELEVATION FOR DETAILS
B	SEE STANDARD DETAIL
C	CUSTOM CABLE LOOM TO PIT RAIL SPEAKERS REQUIRED, PIT RAIL SPEAKER TO BE BUILT INTO FUTURE REBUILD OF PIT RAIL
D	CUSTOM CABLE LOOM TO STAGE LIP SPEAKERS REQUIRED
E	SITE VERIFY POSITION FOR PIT PANELS, POSSIBLY MATCH CURRENT ANALOG CONNECTION LOCATIONS
F	COORDINATE POSITIONS WITH ARCHITECT TO MINIMIZE AESTHETIC IMPACT
G	RCP UNAVAILABLE, SITE VERIFY CEILING CONDITION
H	SEE TR DRAWINGS FOR WINCH REQUIRED, ARRAY MUST FIT THROUGH THE ACOUSTIC PANEL
J	POSITIONS TO BE AT THE FRONT OF THE PLATFORM, PLATFORM MUST BE CLEAR
K	SITE VERIFY LOCATION
L	SEE RACK ELEVATION FOR DETAILS, LOCATED AT "THE ROCK"
M	SEE STANDARD DETAIL, LOCATED AT "THE ROCK"



1 LEVEL 4 CHAPMAN
1/8" = 1'-0"

- NOTES:
- ALL SPEAKER LOCATIONS MUST BE FIELD VERIFIED TO CONFIRM LOCAL CONDITIONS.
 - SPEAKER HEIGHT ABOVE FINISHED FLOOR ARE GUIDELINES FOR CREATING SMOOTH COVERAGE ACROSS THE SEATING AREA, LOCAL CONDITIONS MAY REQUIRE VARIANCES.
 - IT IS THE INTENT OF THIS DESIGN TO REUSE AS MUCH EXISTING SPEAKER WIRING AS POSSIBLE. A FULL EVALUATION OF THE CURRENT TYPE, SIZE, ROUTING, AND AGE OF THE INSTALLED WIRE MUST BE PERFORMED.

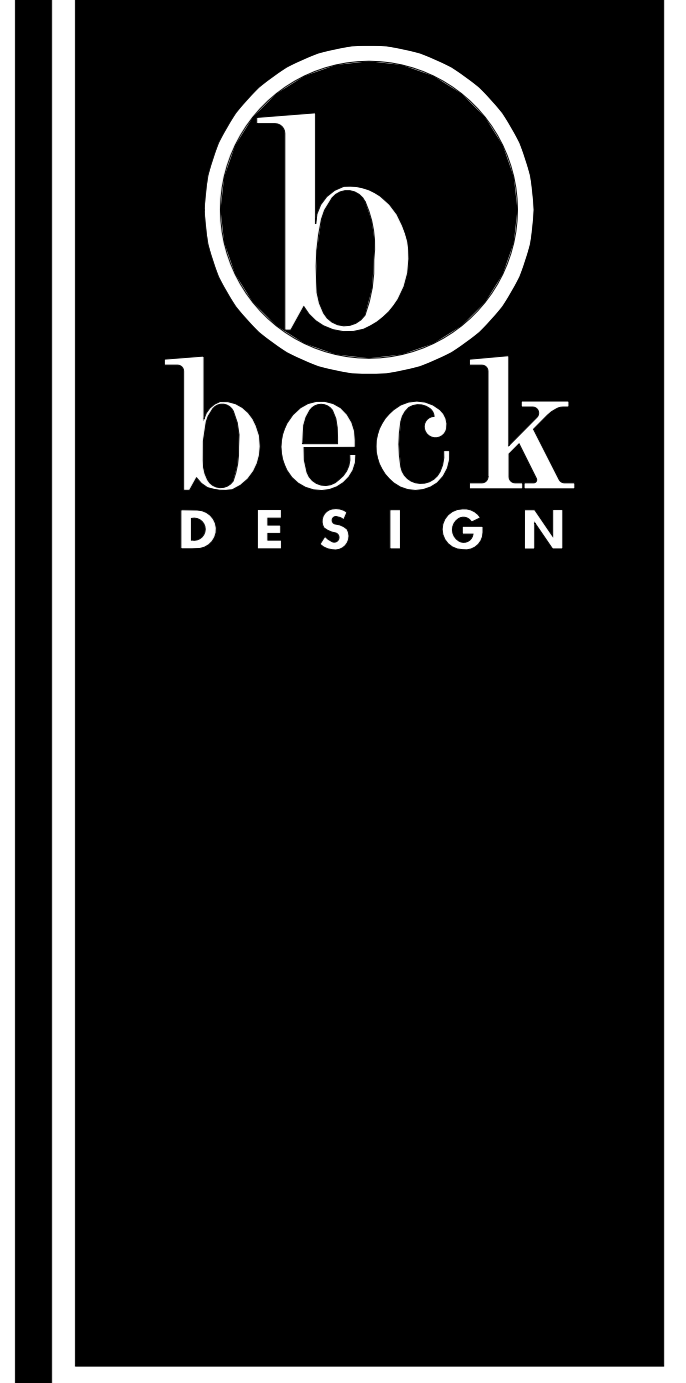

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PROJECT:
TULSA
PERFORMING
ARTS CENTER

PROJECT NUMBER:
202331.00

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AV104
AV 4th FLOOR PLAN -
CHAPMAN



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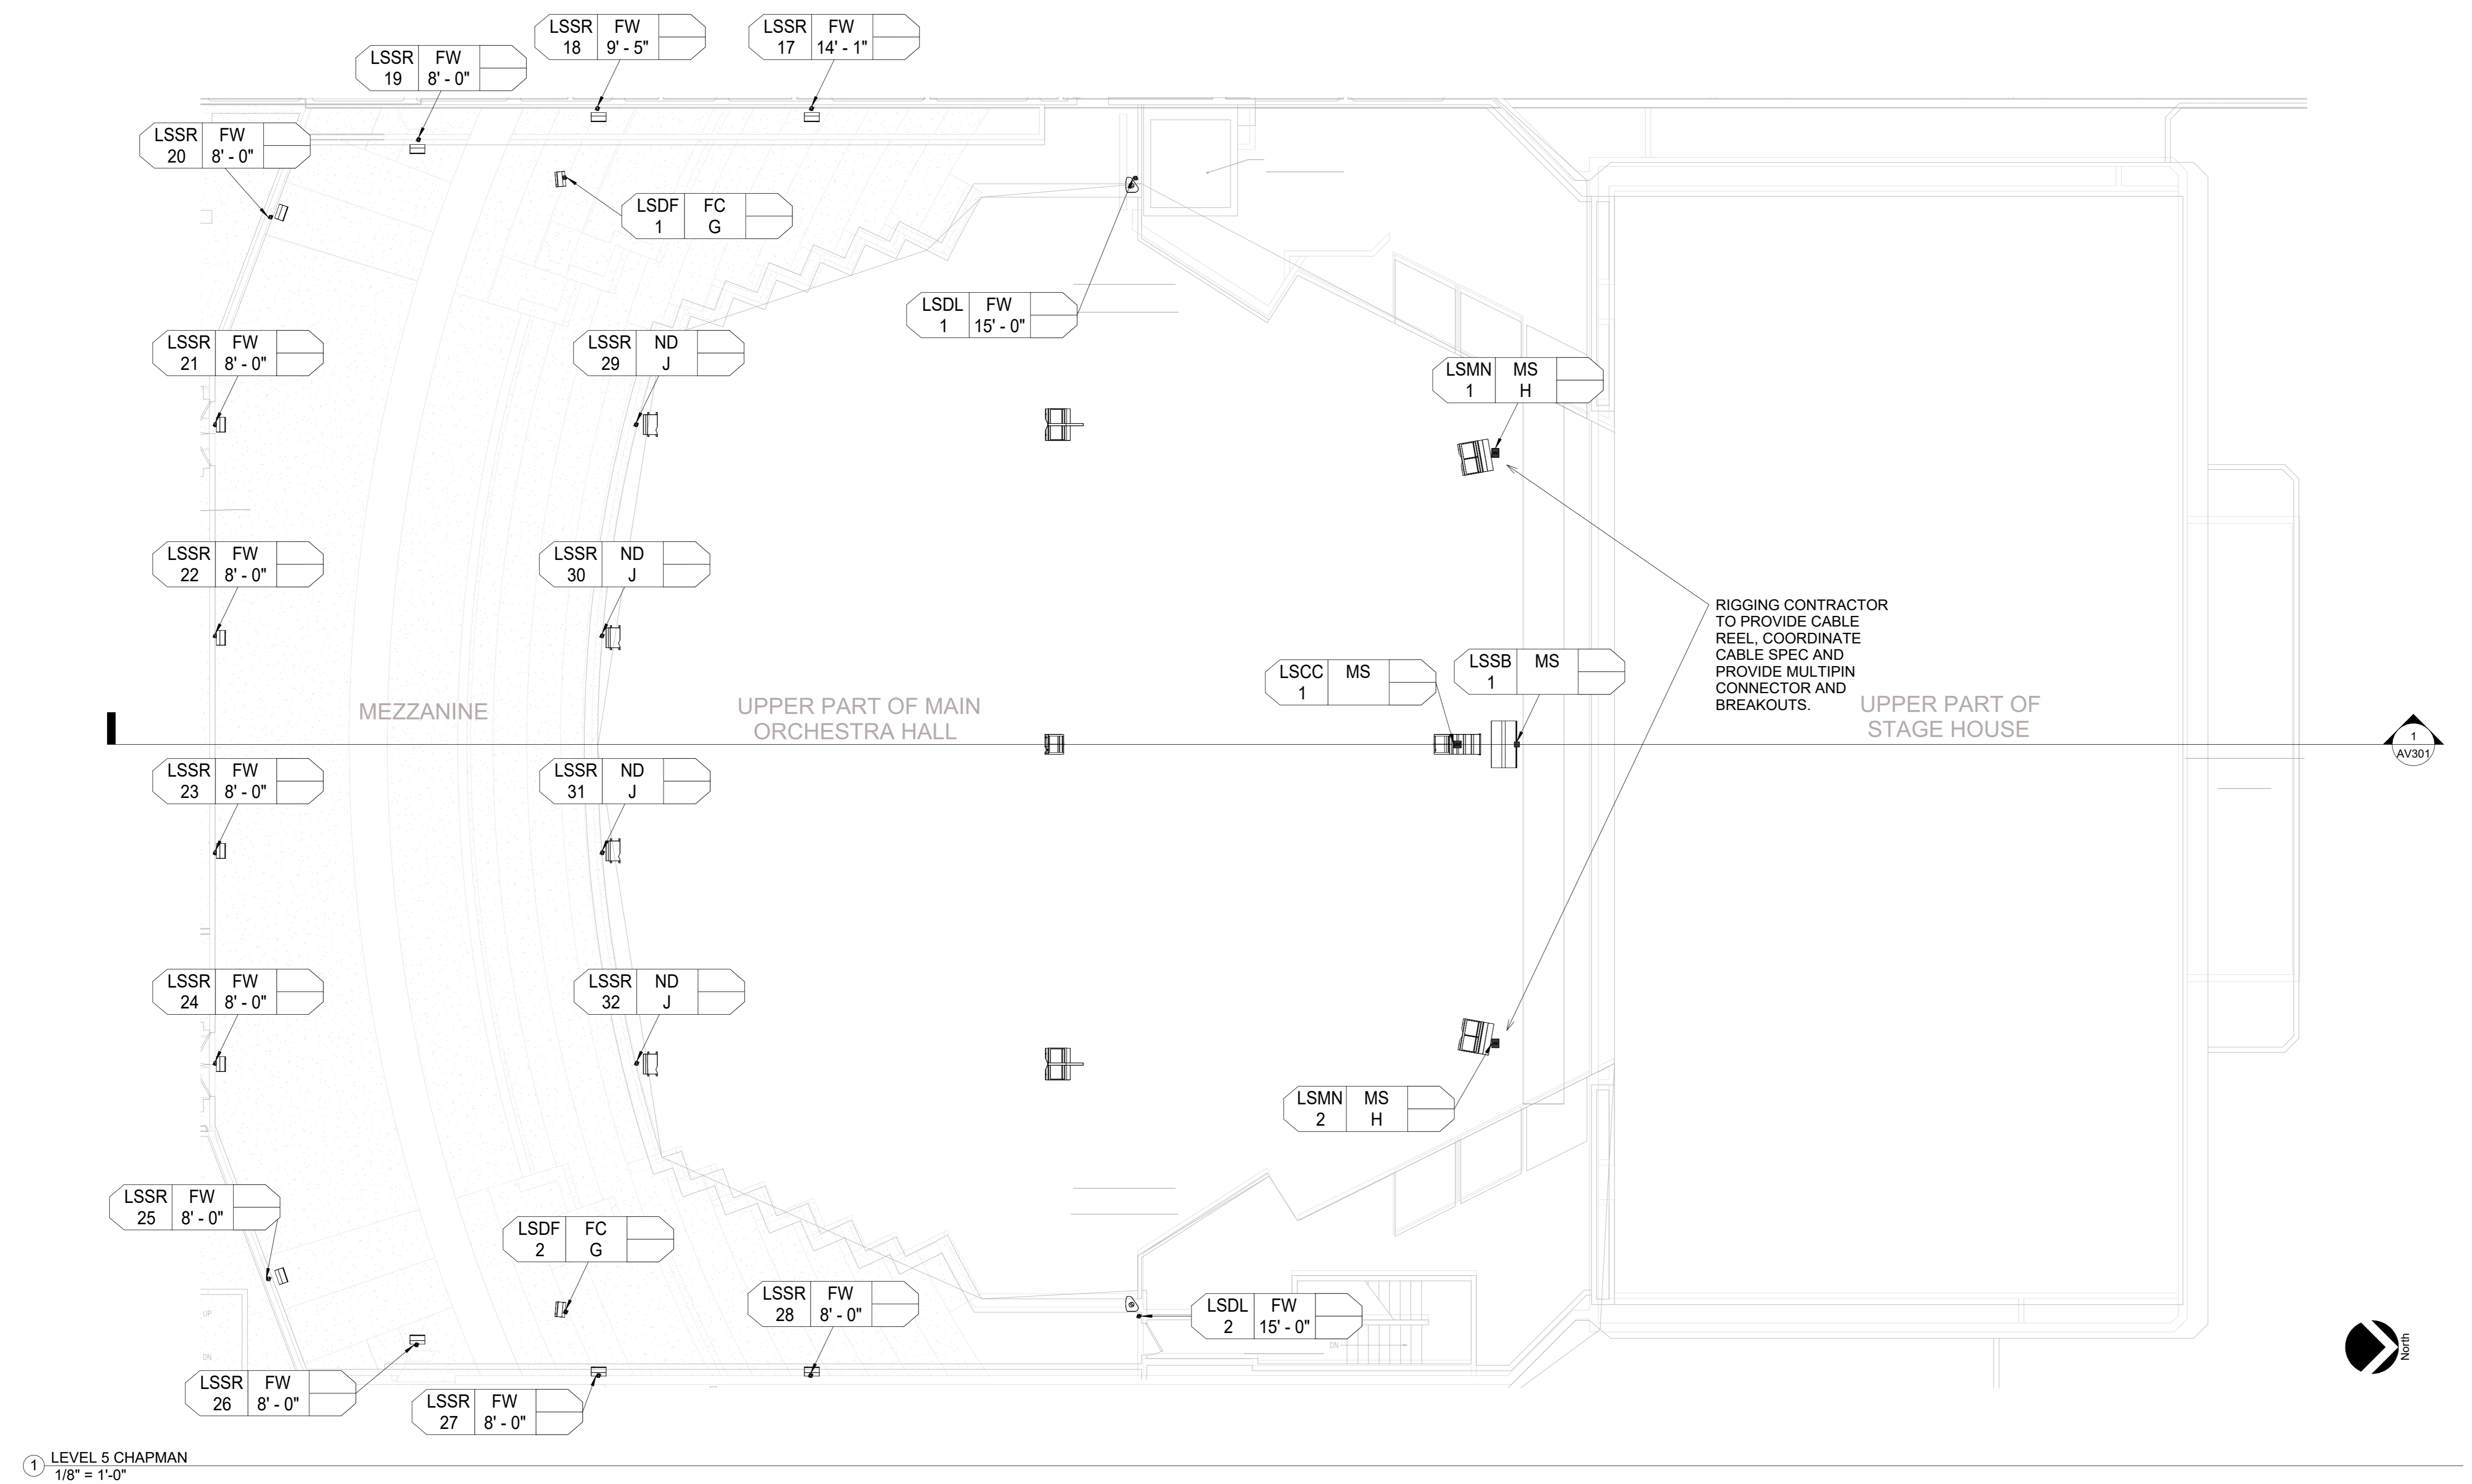
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AV105
AV 5th FLOOR PLAN -
CHAPMAN

KEYED NOTES	
KEY	NOTE
A	SEE RACK ELEVATION FOR DETAILS
B	SEE STANDARD DETAIL
C	CUSTOM CABLE LOOM TO PIT RAIL SPEAKERS REQUIRED, PIT RAIL SPEAKER TO BE BUILT INTO FUTURE REBUILD OF PIT RAIL
D	CUSTOM CABLE LOOM TO STAGE LIP SPEAKERS REQUIRED
E	SITE VERIFY POSITION FOR PIT PANELS, POSSIBLY MATCH CURRENT ANALOG CONNECTION LOCATIONS
F	COORDINATE POSITIONS WITH ARCHITECT TO MINIMIZE AESTHETIC IMPACT
G	RCP UNAVAILABLE, SITE VERIFY CEILING CONDITION
H	SEE TR DRAWINGS FOR WINCH REQUIRED, ARRAY MUST FIT THROUGH THE ACOUSTIC PANEL
J	POSITIONS TO BE AT THE FRONT OF THE PLATFORM, PLATFORM MUST BE CLEAR
K	SITE VERIFY LOCATION
L	SEE RACK ELEVATION FOR DETAILS, LOCATED AT "THE ROCK"
M	SEE STANDARD DETAIL, LOCATED AT "THE ROCK"



- NOTES:
- ALL SPEAKER LOCATIONS MUST BE FIELD VERIFIED TO CONFIRM LOCAL CONDITIONS.
 - SPEAKER HEIGHT ABOVE FINISHED FLOOR ARE GUIDELINES FOR CREATING SMOOTH COVERAGE ACROSS THE SEATING AREA, LOCAL CONDITIONS MAY REQUIRE VARIANCES.
 - IT IS THE INTENT OF THIS DESIGN TO REUSE AS MUCH EXISTING SPEAKER WIRING AS POSSIBLE. A FULL EVALUATION OF THE CURRENT TYPE, SIZE, ROUTING, AND AGE OF THE INSTALLED WIRE MUST BE PERFORMED.

KEYED NOTES	
KEY	NOTE
A	SEE RACK ELEVATION FOR DETAILS
B	SEE STANDARD DETAIL
C	CUSTOM CABLE LOOM TO PIT RAIL SPEAKERS REQUIRED, PIT RAIL SPEAKER TO BE BUILT INTO FUTURE REBUILD OF PIT RAIL
D	CUSTOM CABLE LOOM TO STAGE LIP SPEAKERS REQUIRED
E	SITE VERIFY POSITION FOR PIT PANELS, POSSIBLY MATCH CURRENT ANALOG CONNECTION LOCATIONS
F	COORDINATE POSITIONS WITH ARCHITECT TO MINIMIZE AESTHETIC IMPACT
G	RCP UNAVAILABLE, SITE VERIFY CEILING CONDITION
H	SEE TR DRAWINGS FOR WINCH REQUIRED, ARRAY MUST FIT THROUGH THE ACOUSTIC PANEL
J	POSITIONS TO BE AT THE FRONT OF THE PLATFORM, PLATFORM MUST BE CLEAR
K	SITE VERIFY LOCATION
L	SEE RACK ELEVATION FOR DETAILS, LOCATED AT "THE ROCK"
M	SEE STANDARD DETAIL, LOCATED AT "THE ROCK"



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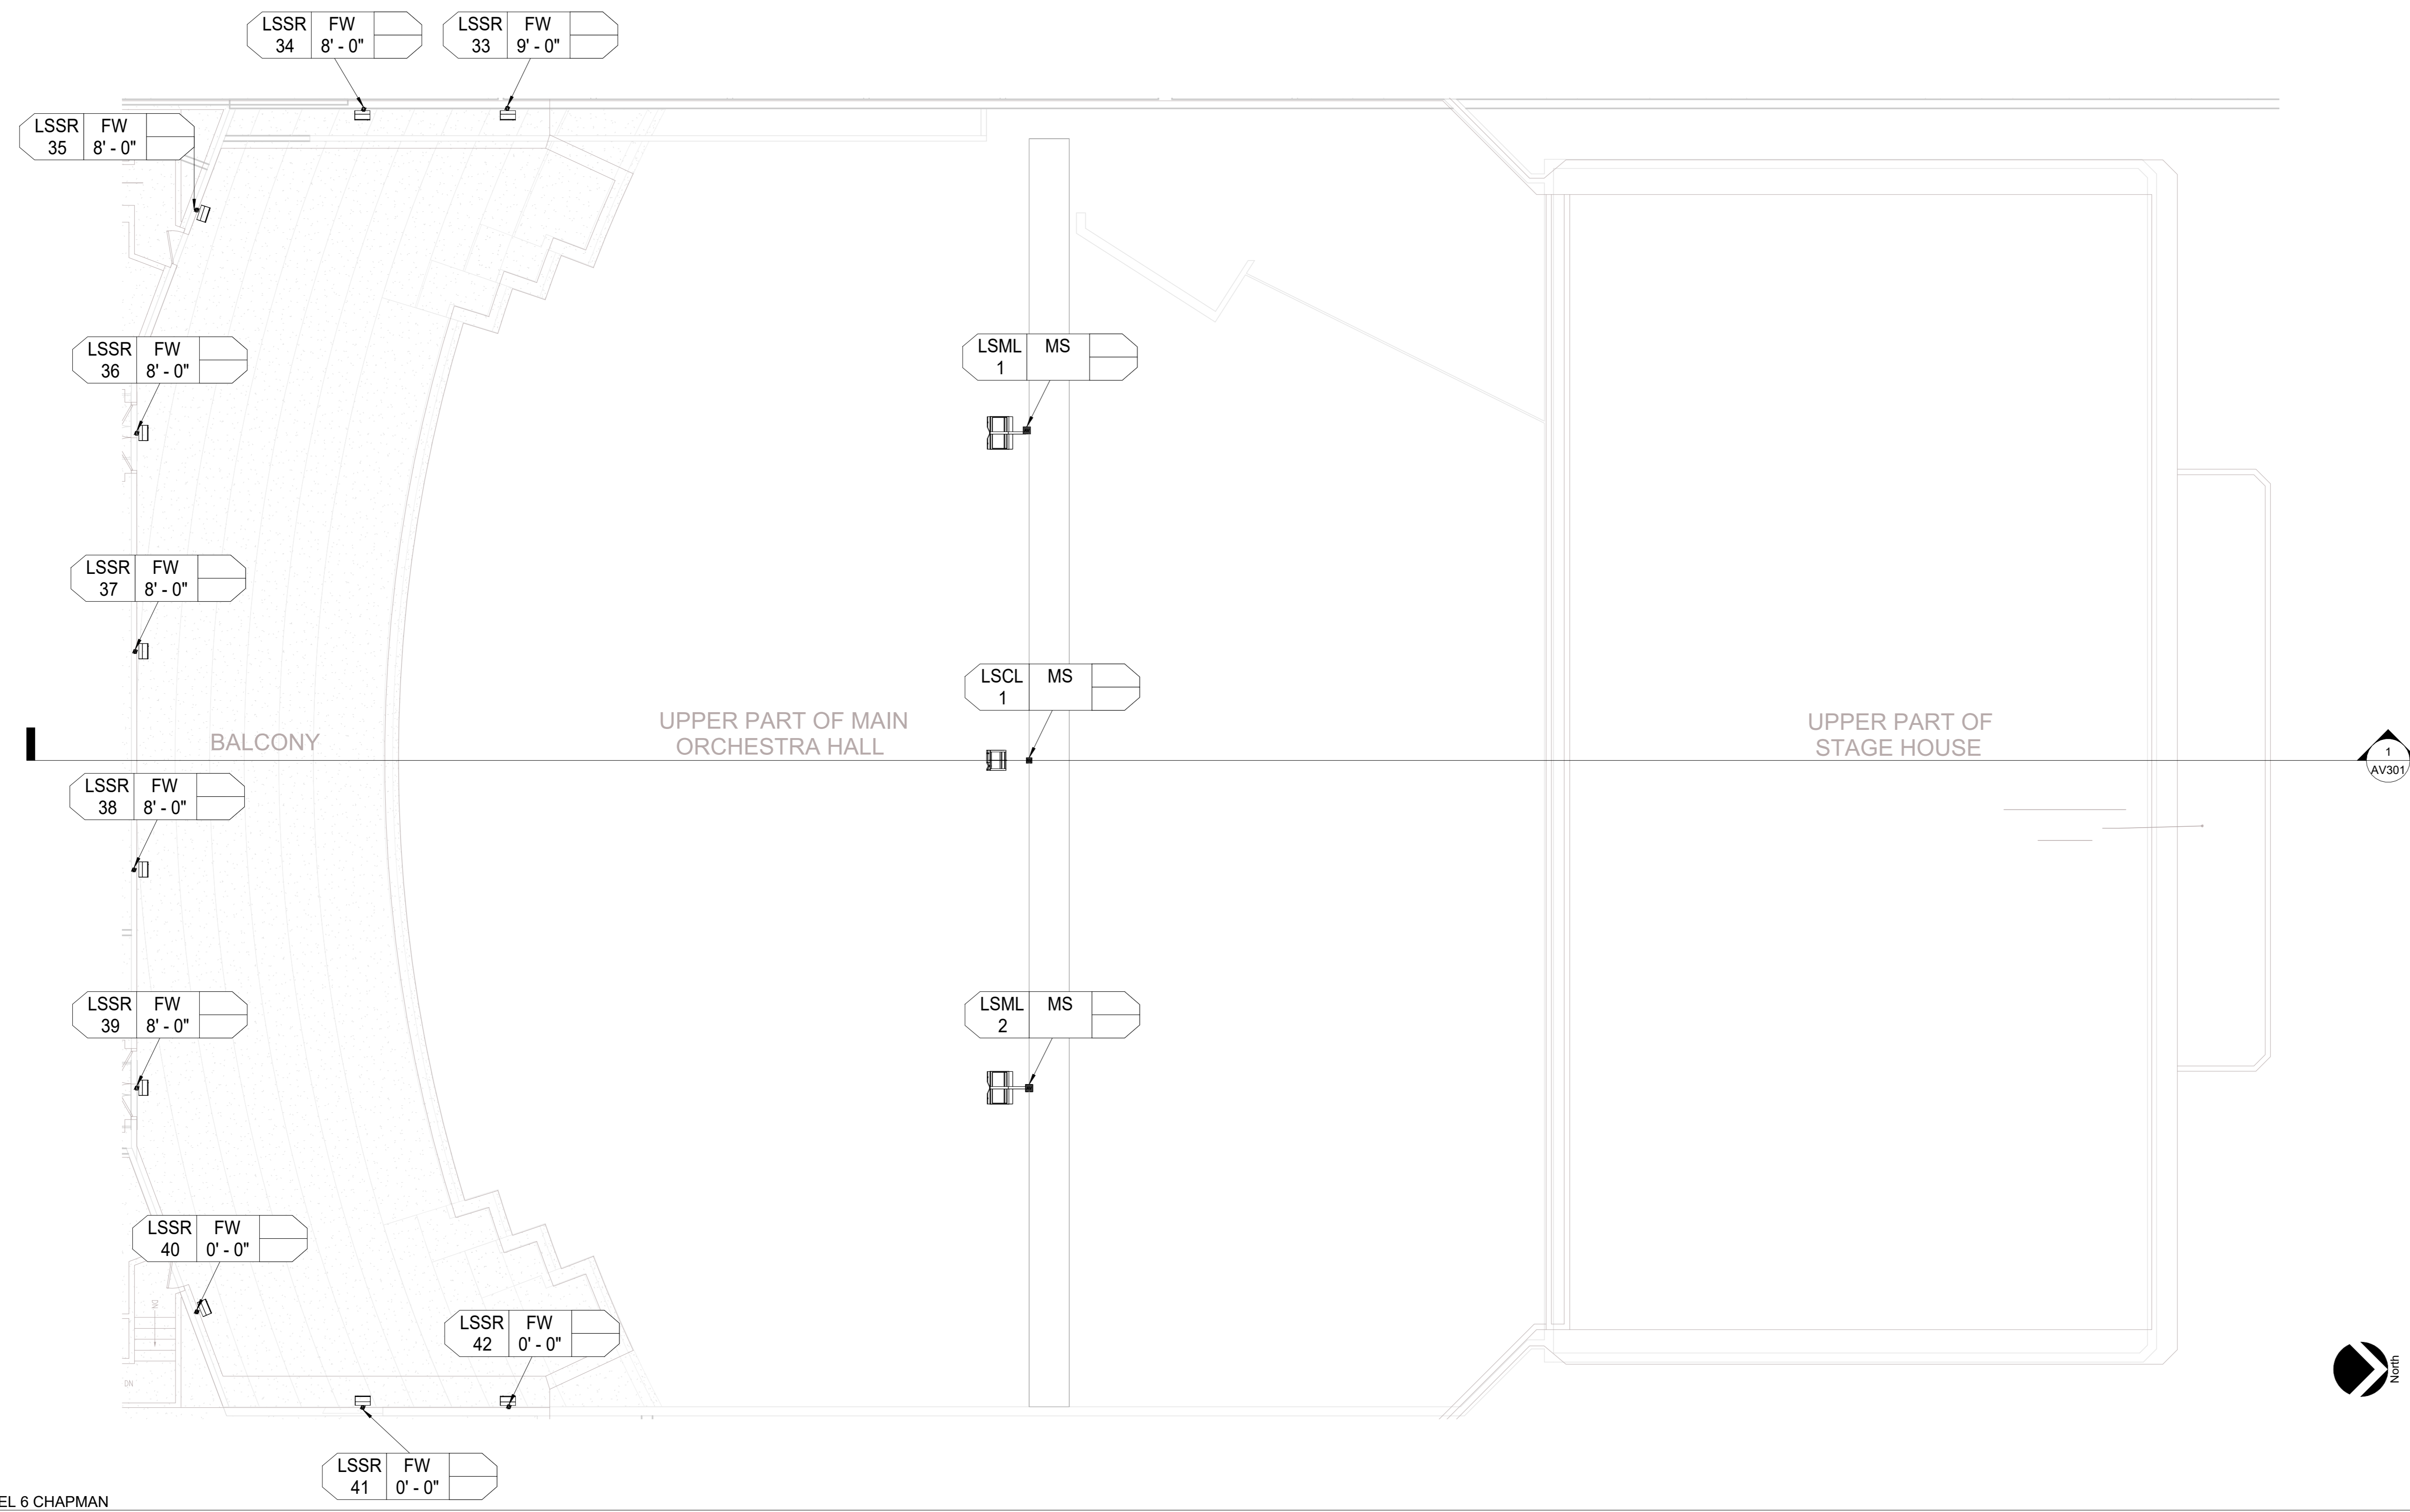
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AV106

AV 6th FLOOR PLAN -
CHAPMAN



1 LEVEL 6 CHAPMAN
1/8" = 1'-0"

- NOTES:
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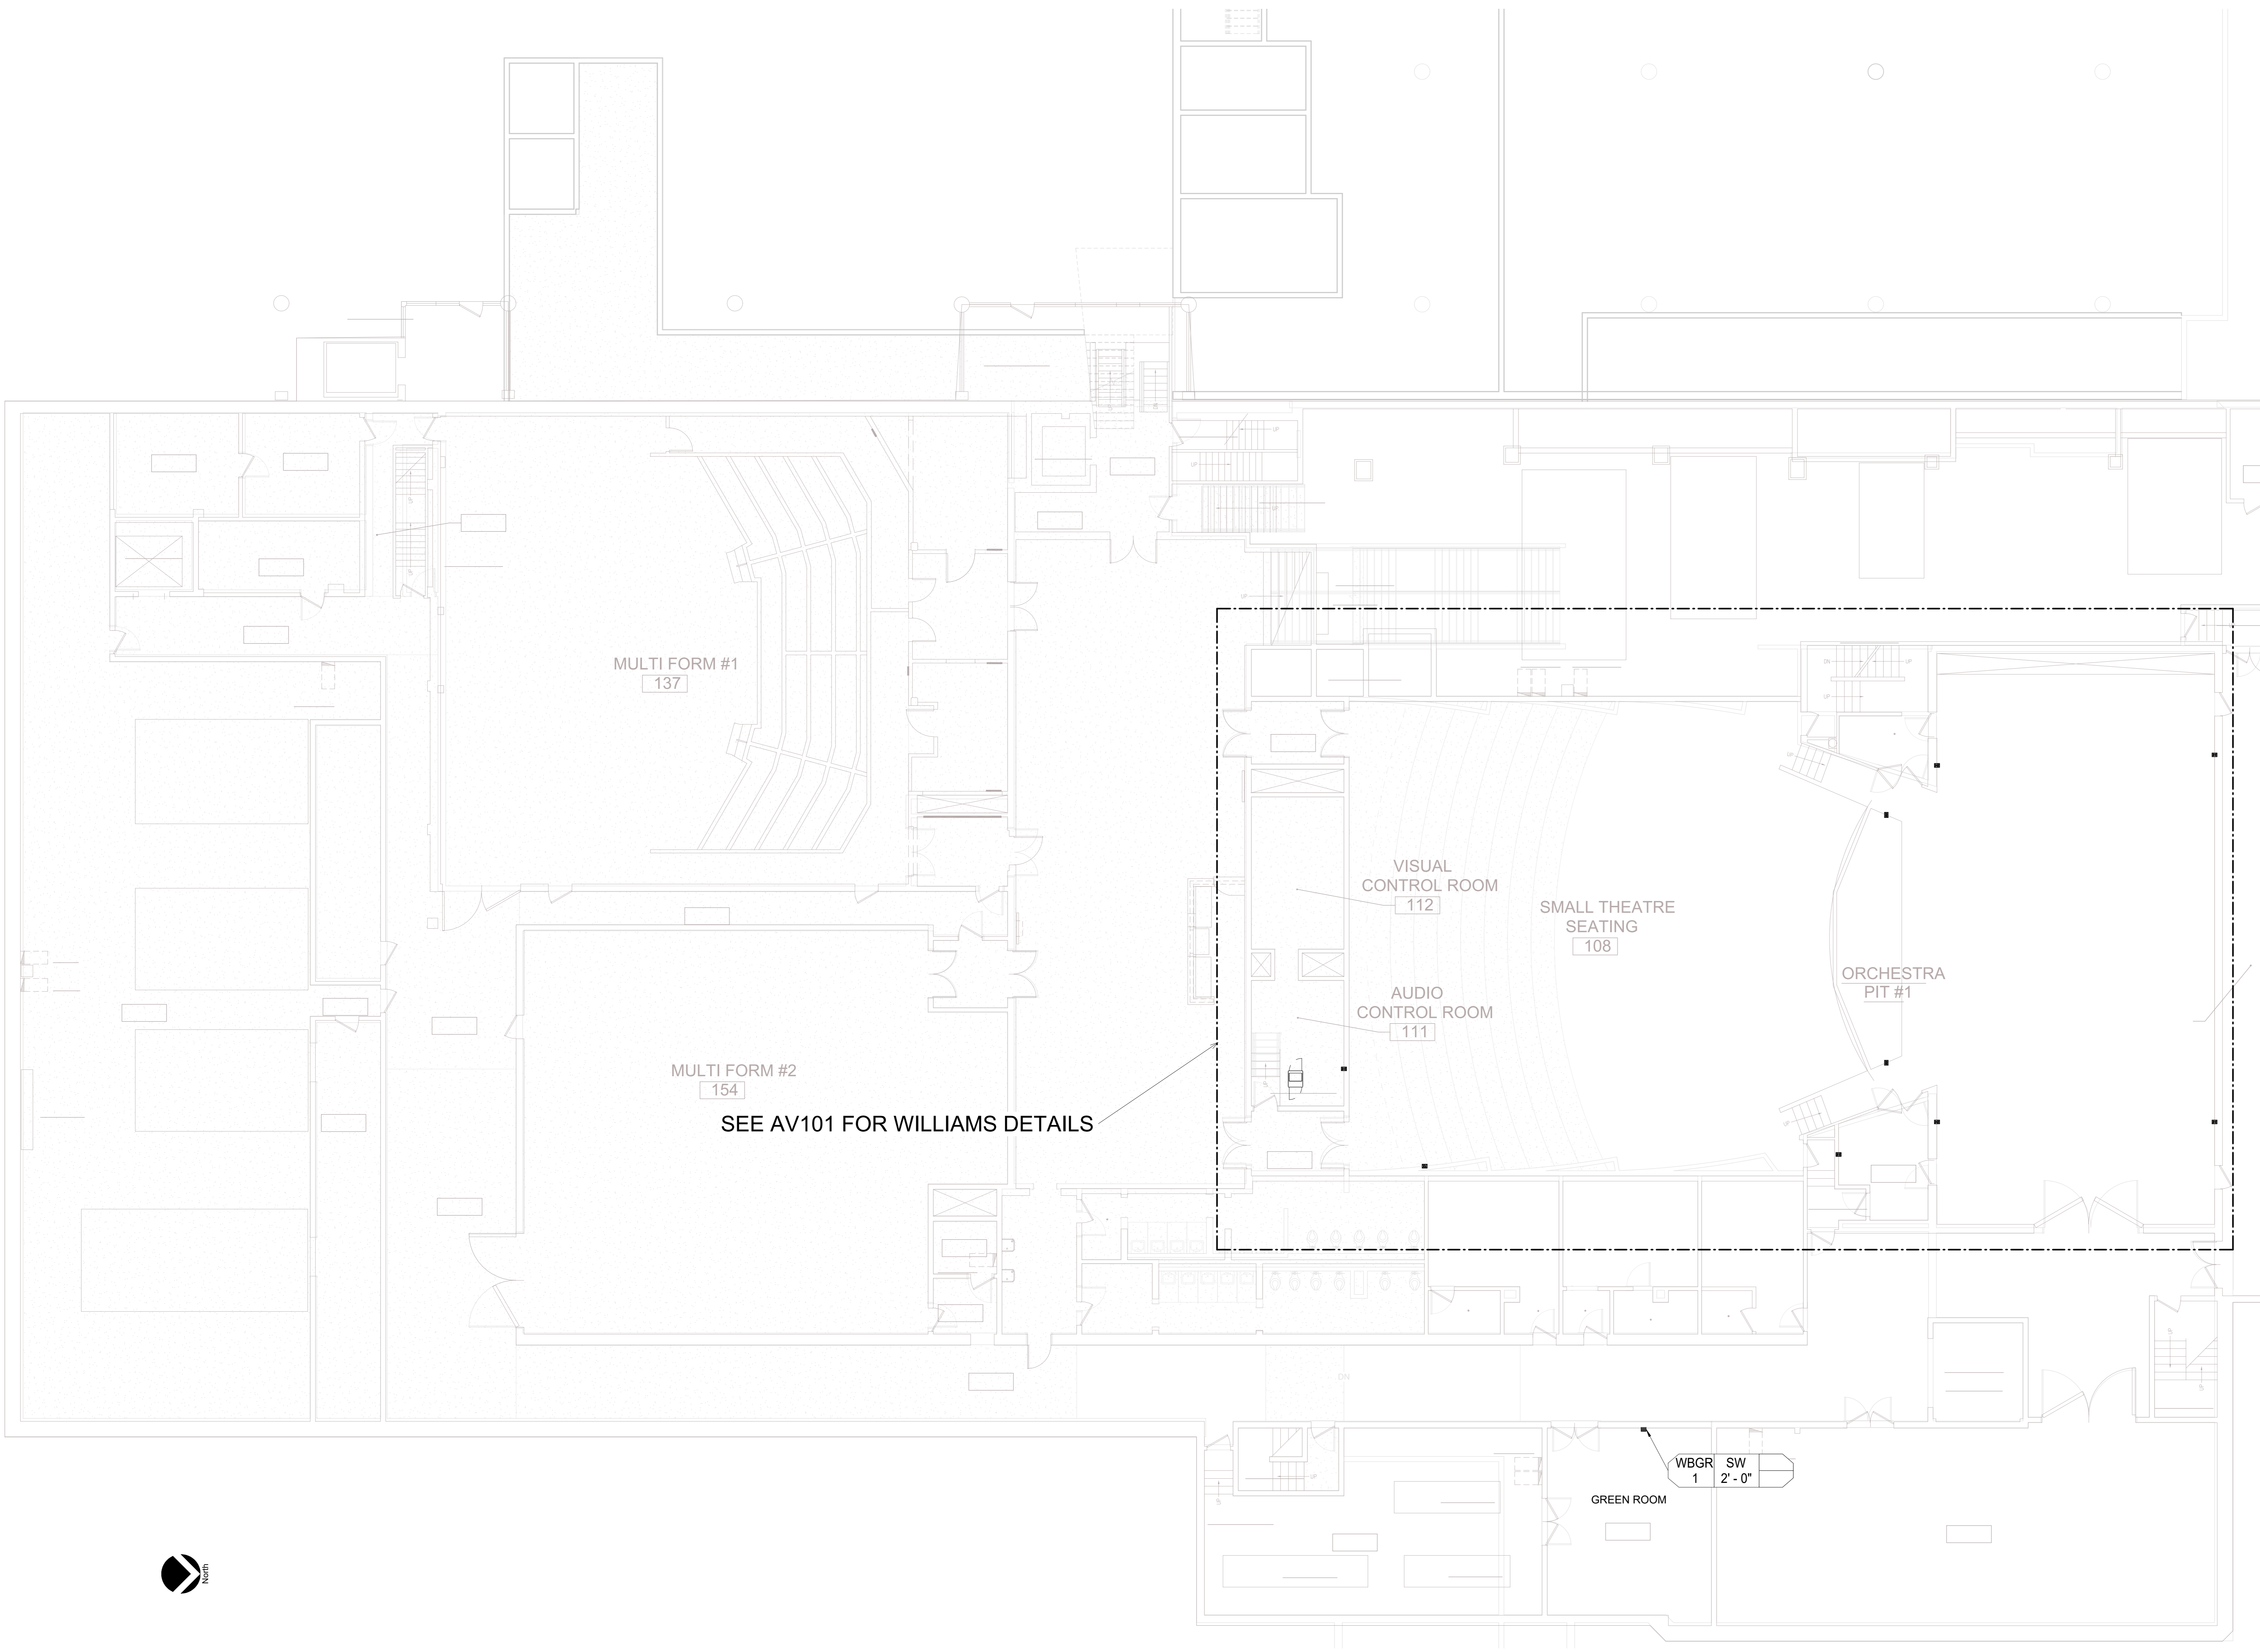
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AV107
AV 1st FLOOR
FACILITY PLAN



① LEVEL 1
1/8" = 1'-0"



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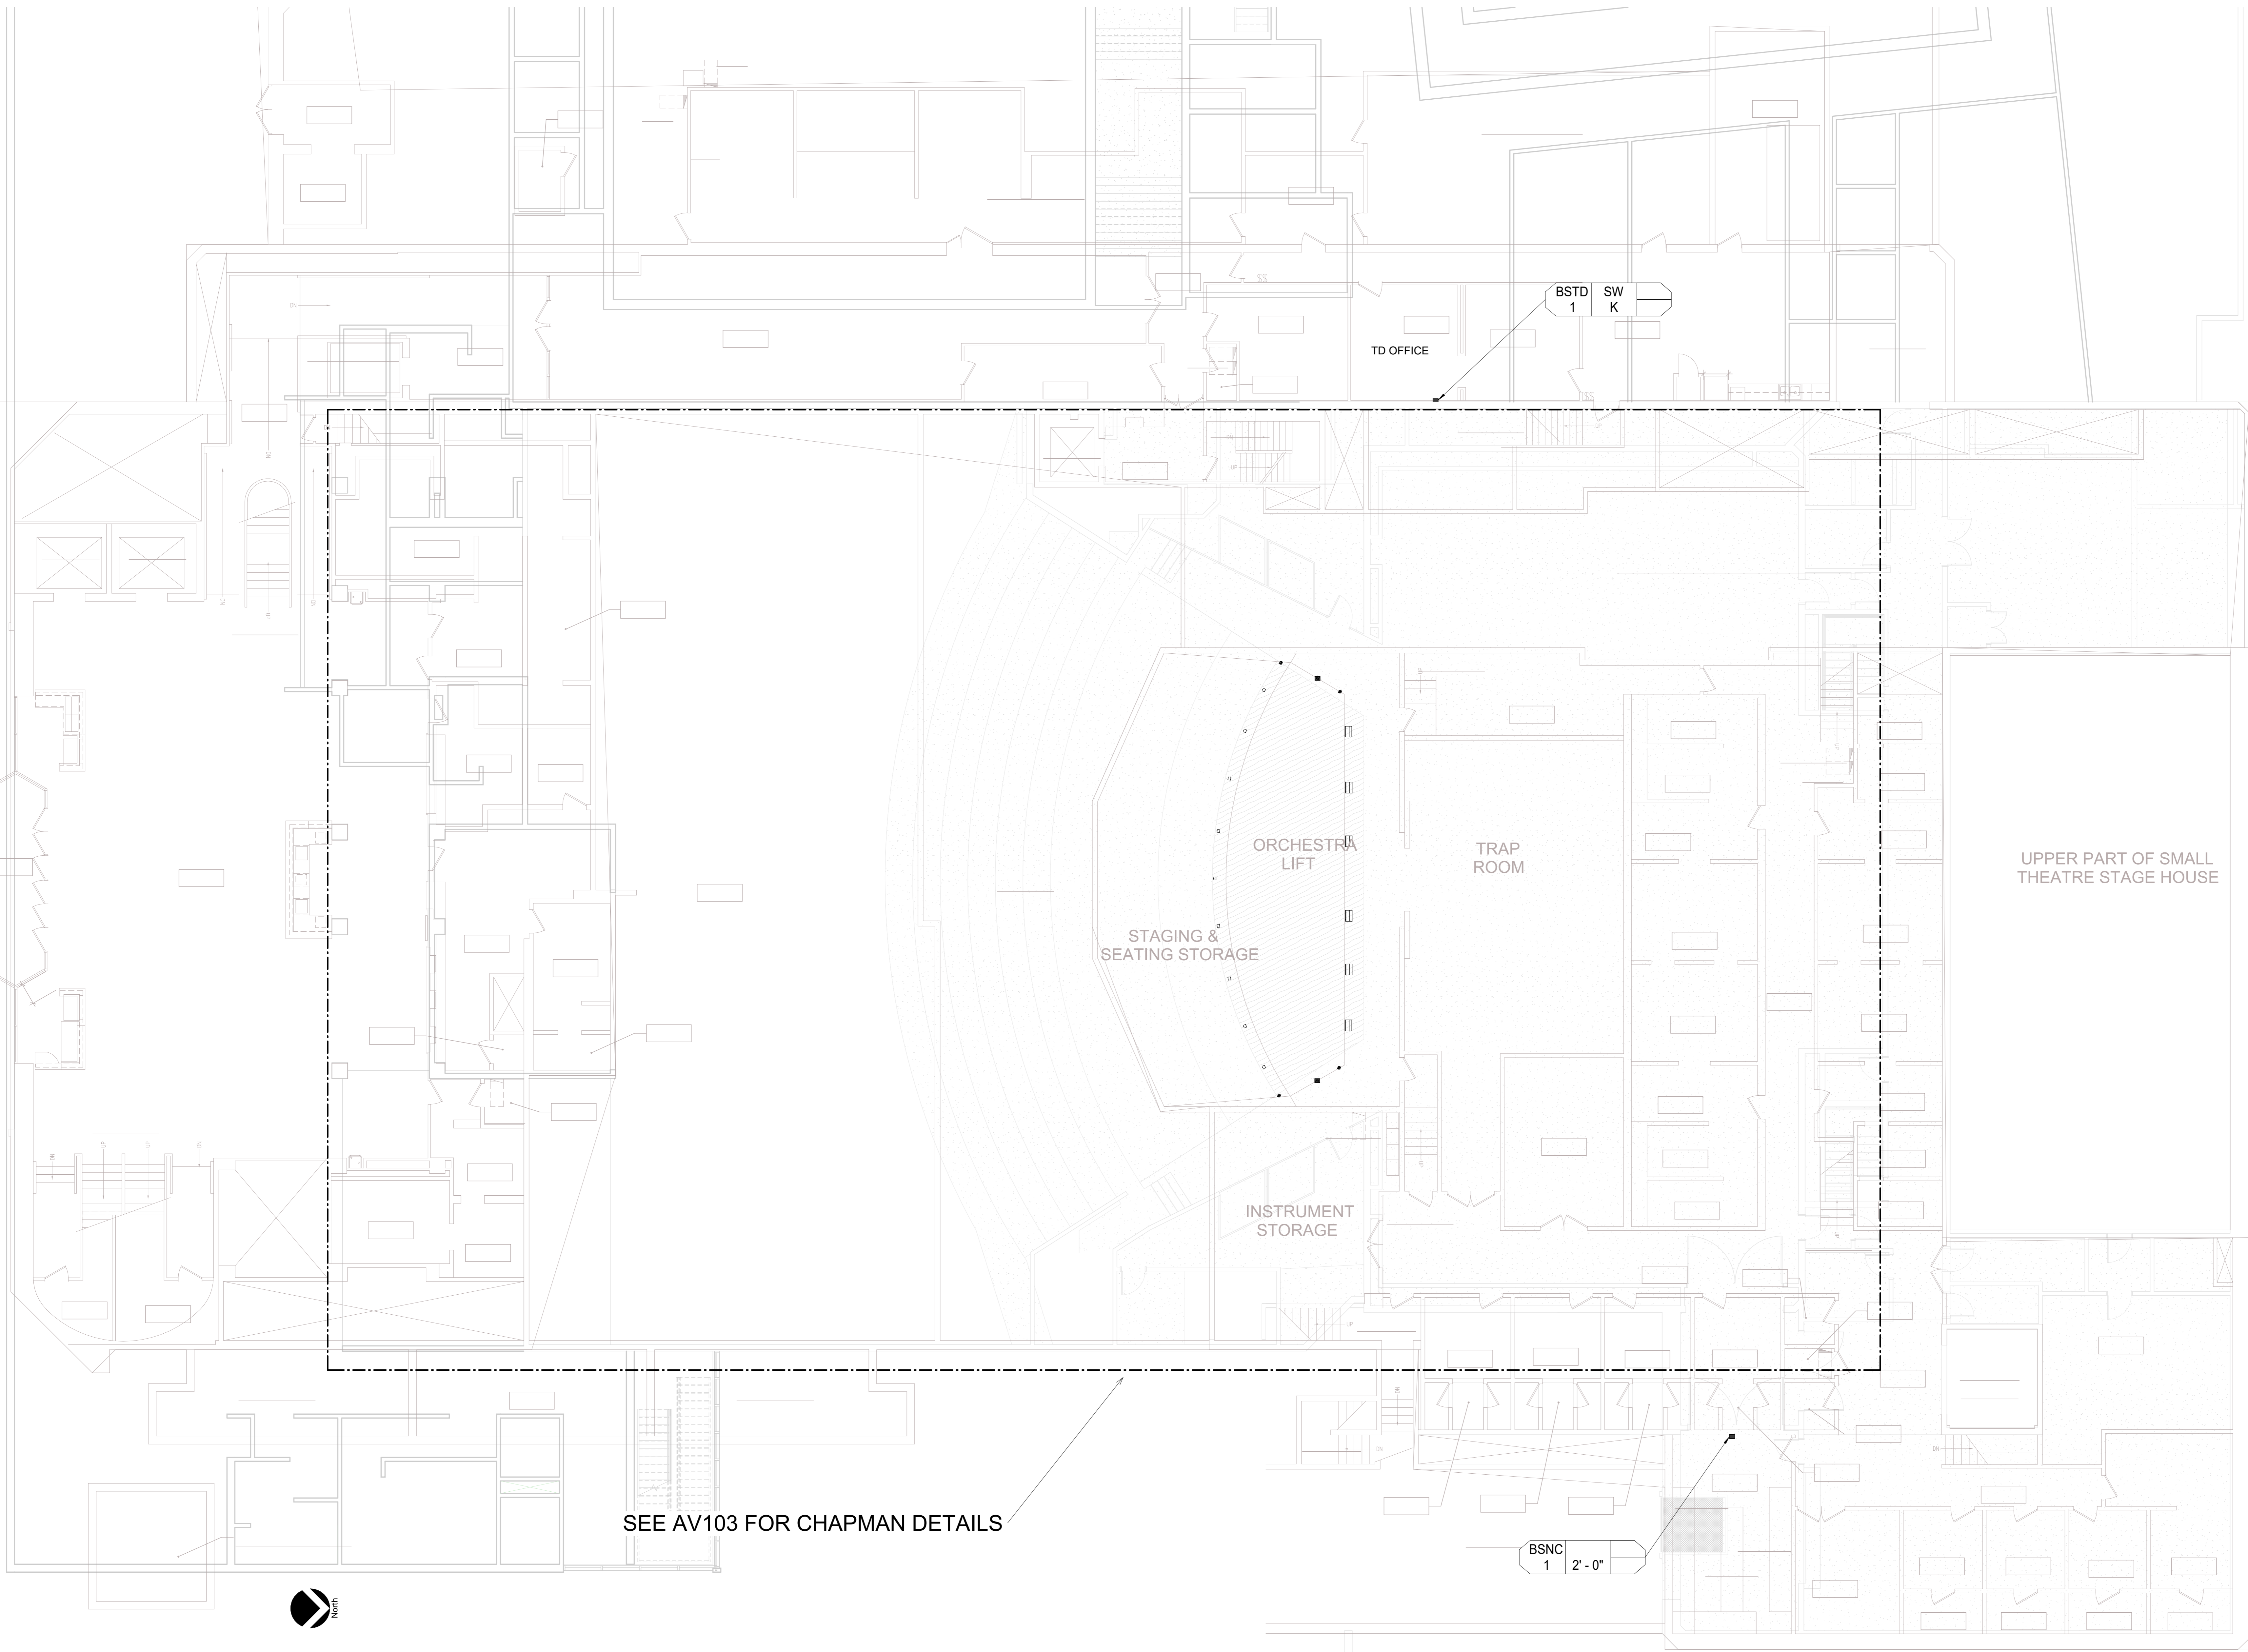
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AV108
AV 3rd FLOOR
FACILITY PLAN



SEE AV103 FOR CHAPMAN DETAILS

BSNC
1 2'-0"

LEVEL 3
1/8" = 1'-0"



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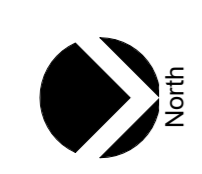
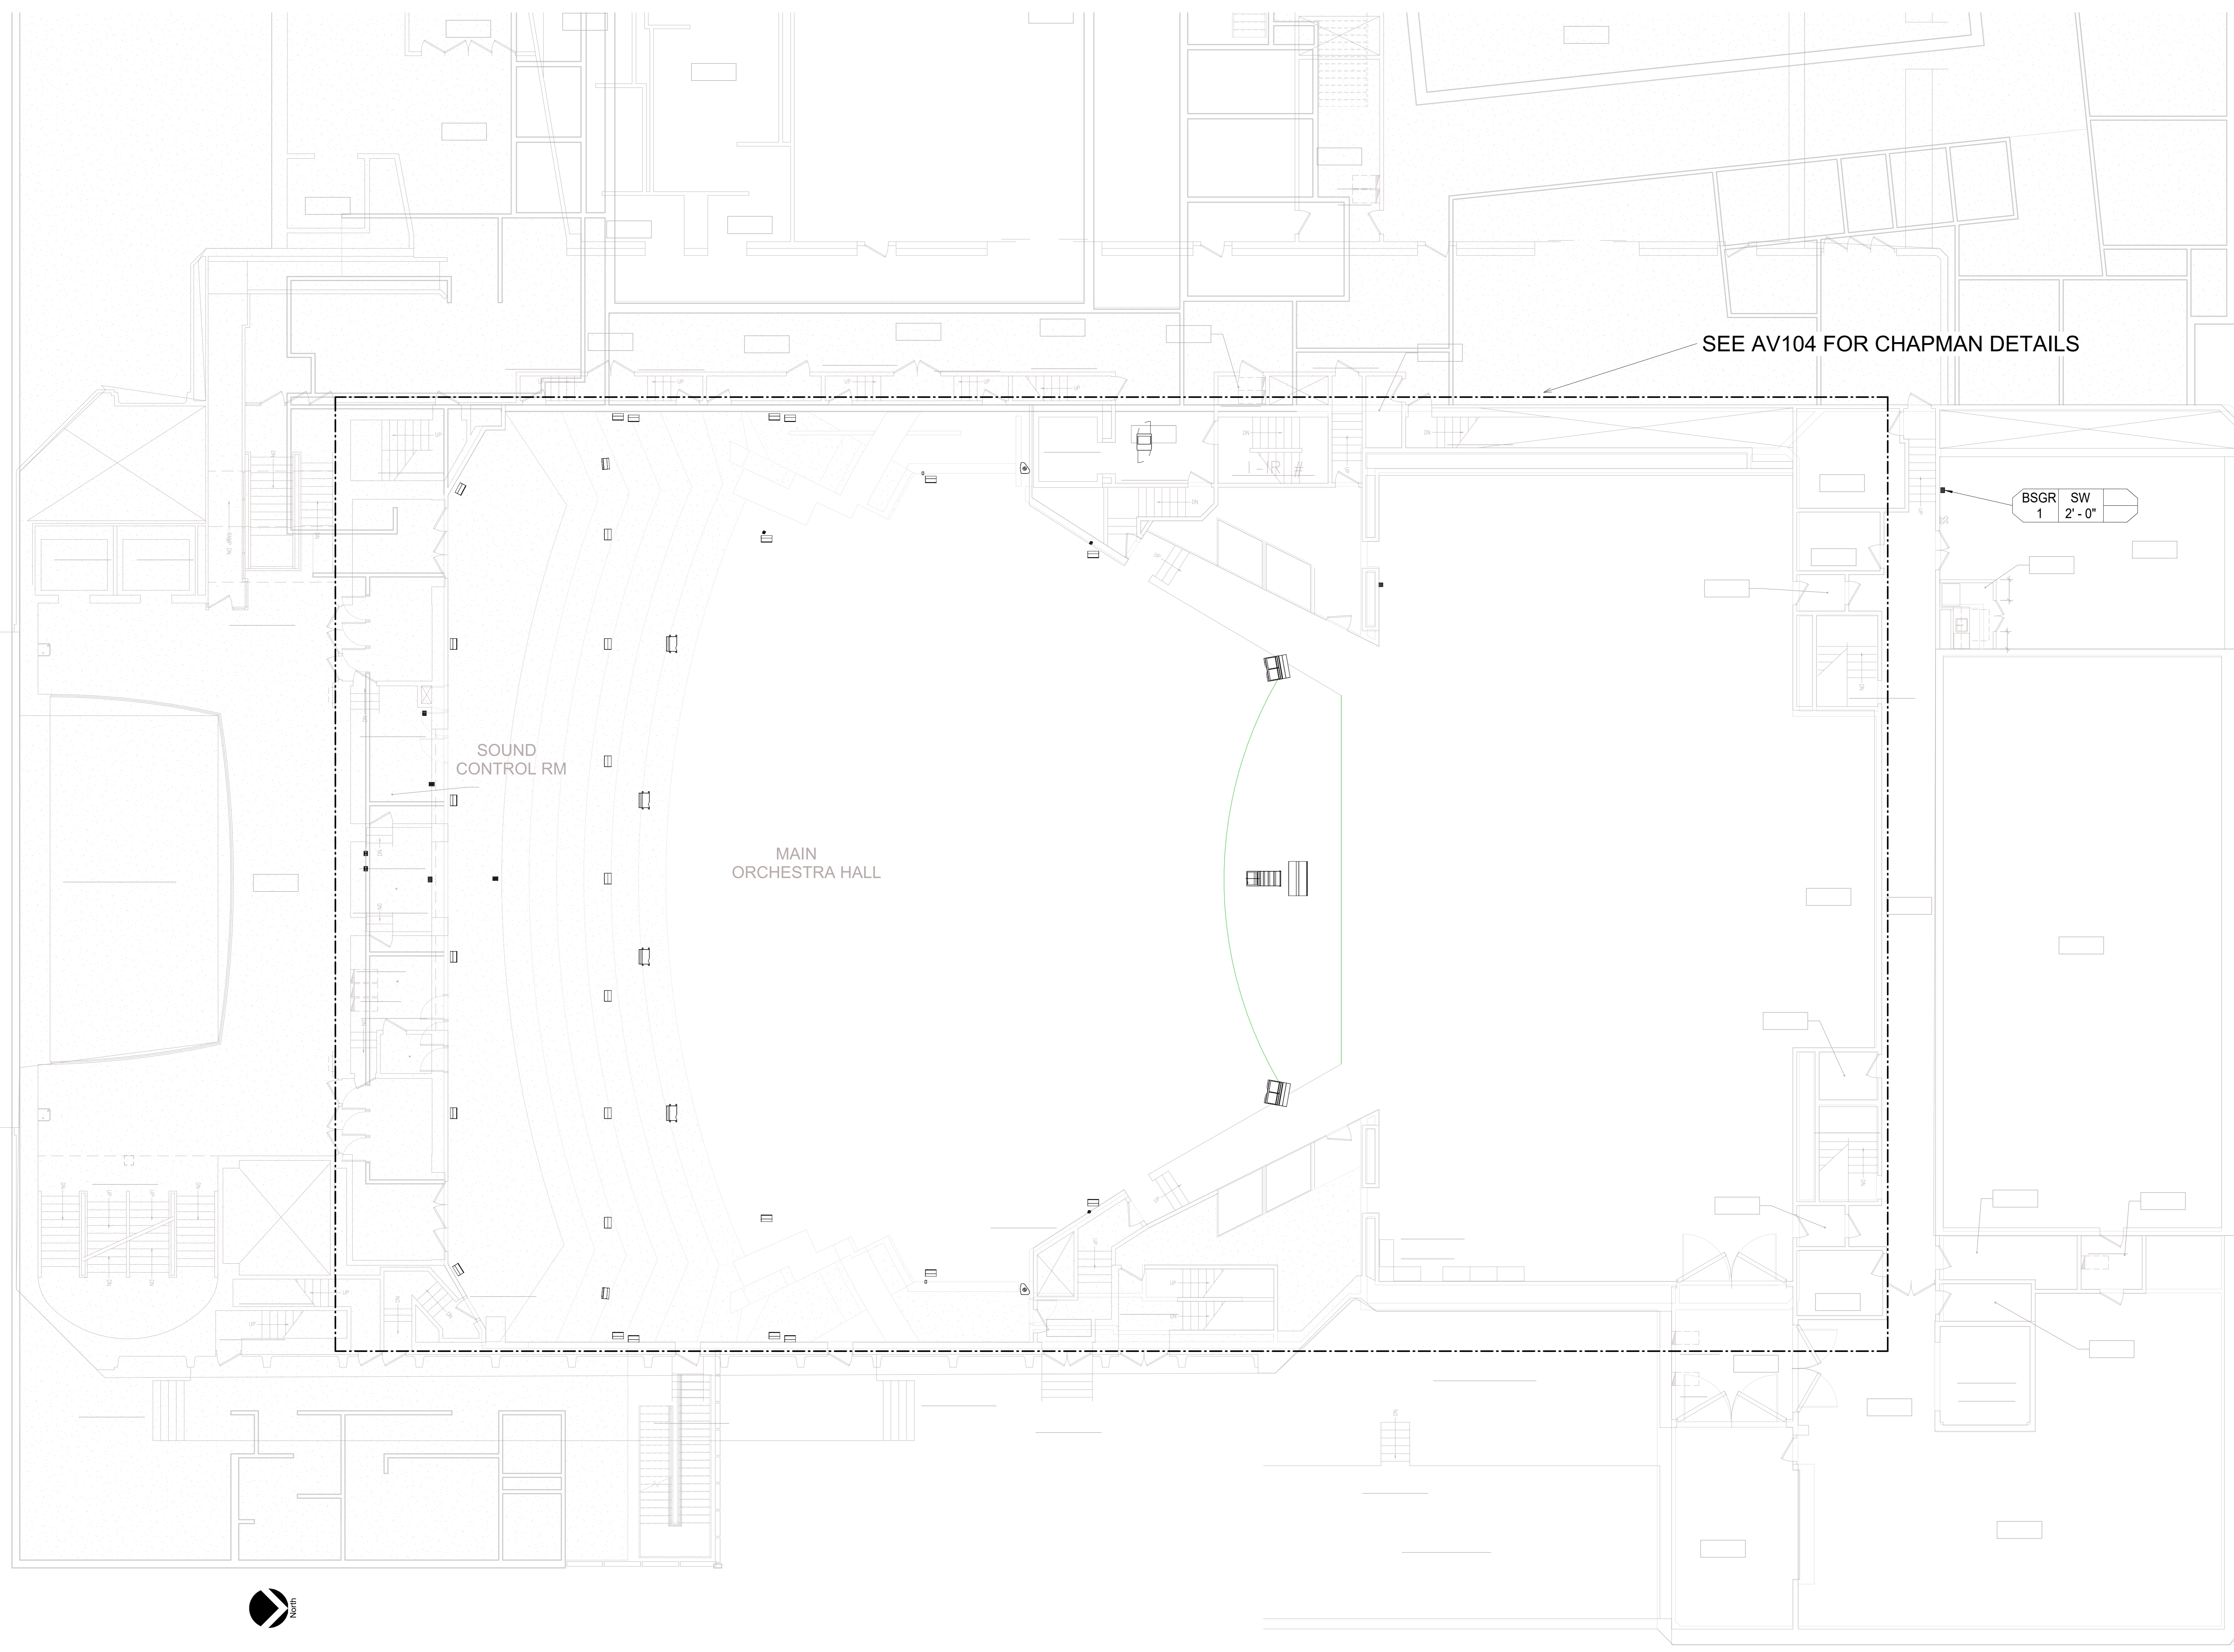
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AV109

AV 4th FLOOR
FACILITY PLAN



① LEVEL 4
1/8" = 1'-0"



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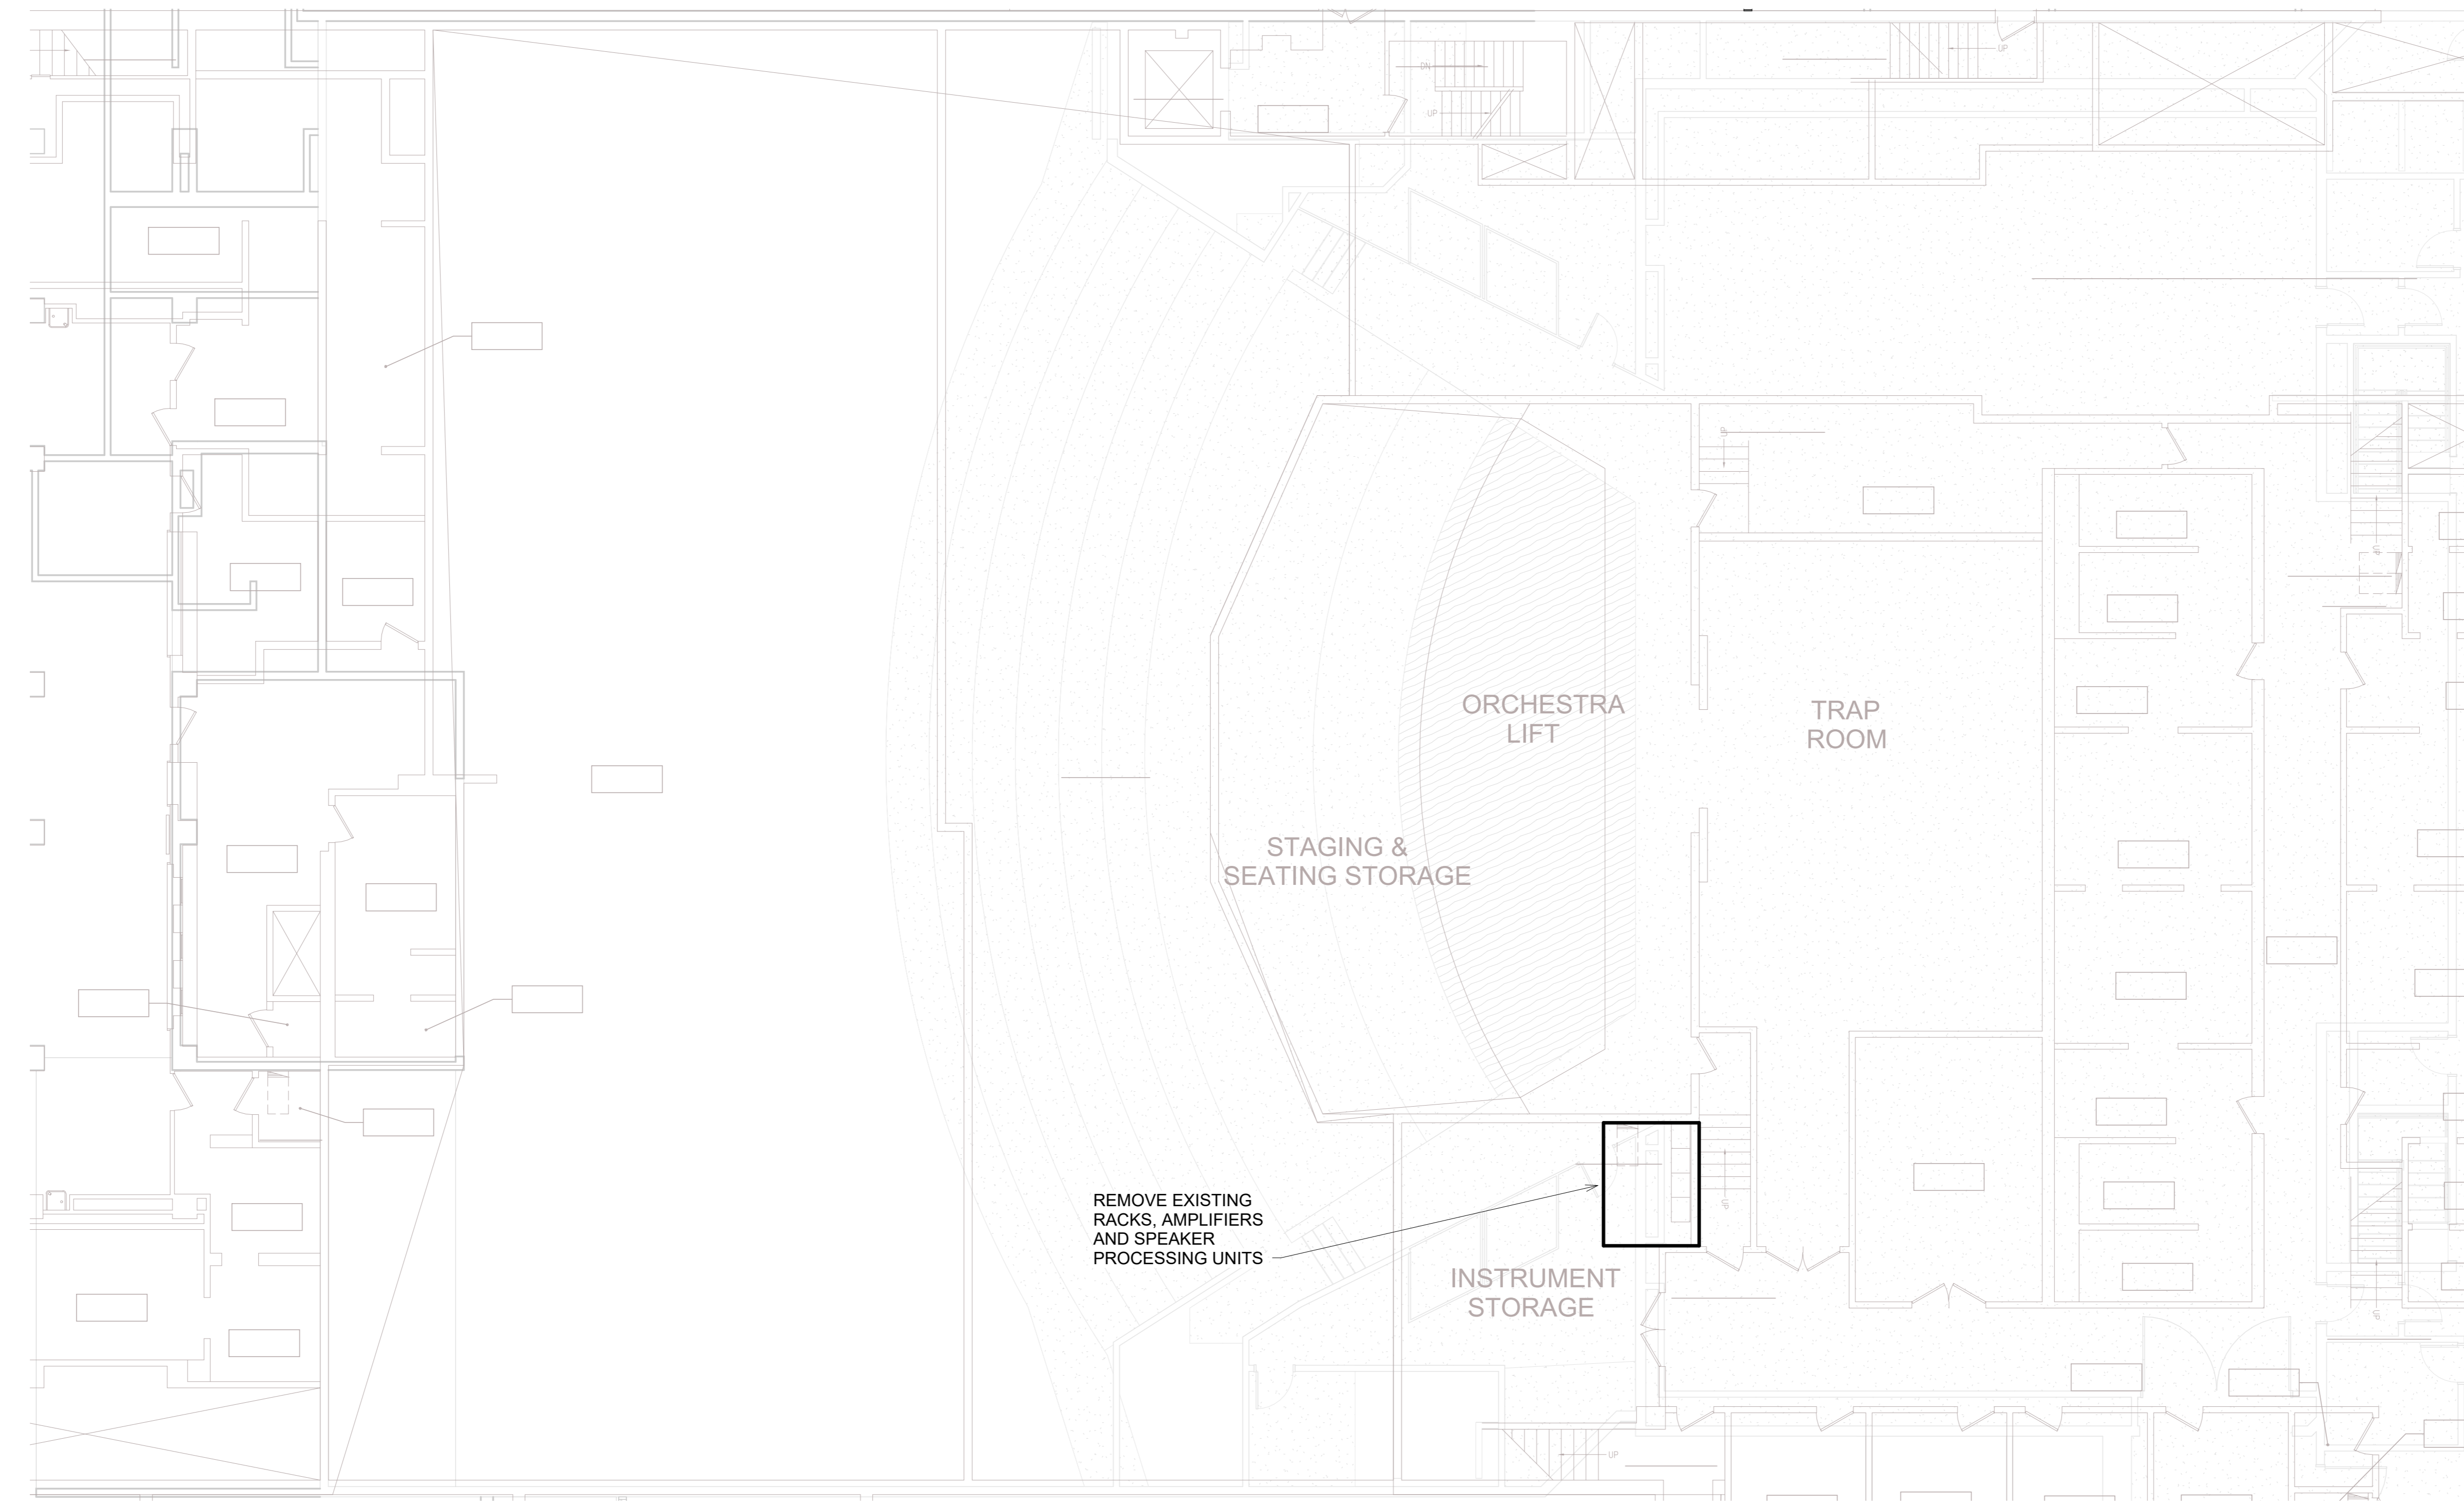
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AV113

AV 3rd FLOOR PLAN -
CHAPMAN DEMO



① LEVEL 3 CHAPMAN DEMO
1/8" = 1'-0"



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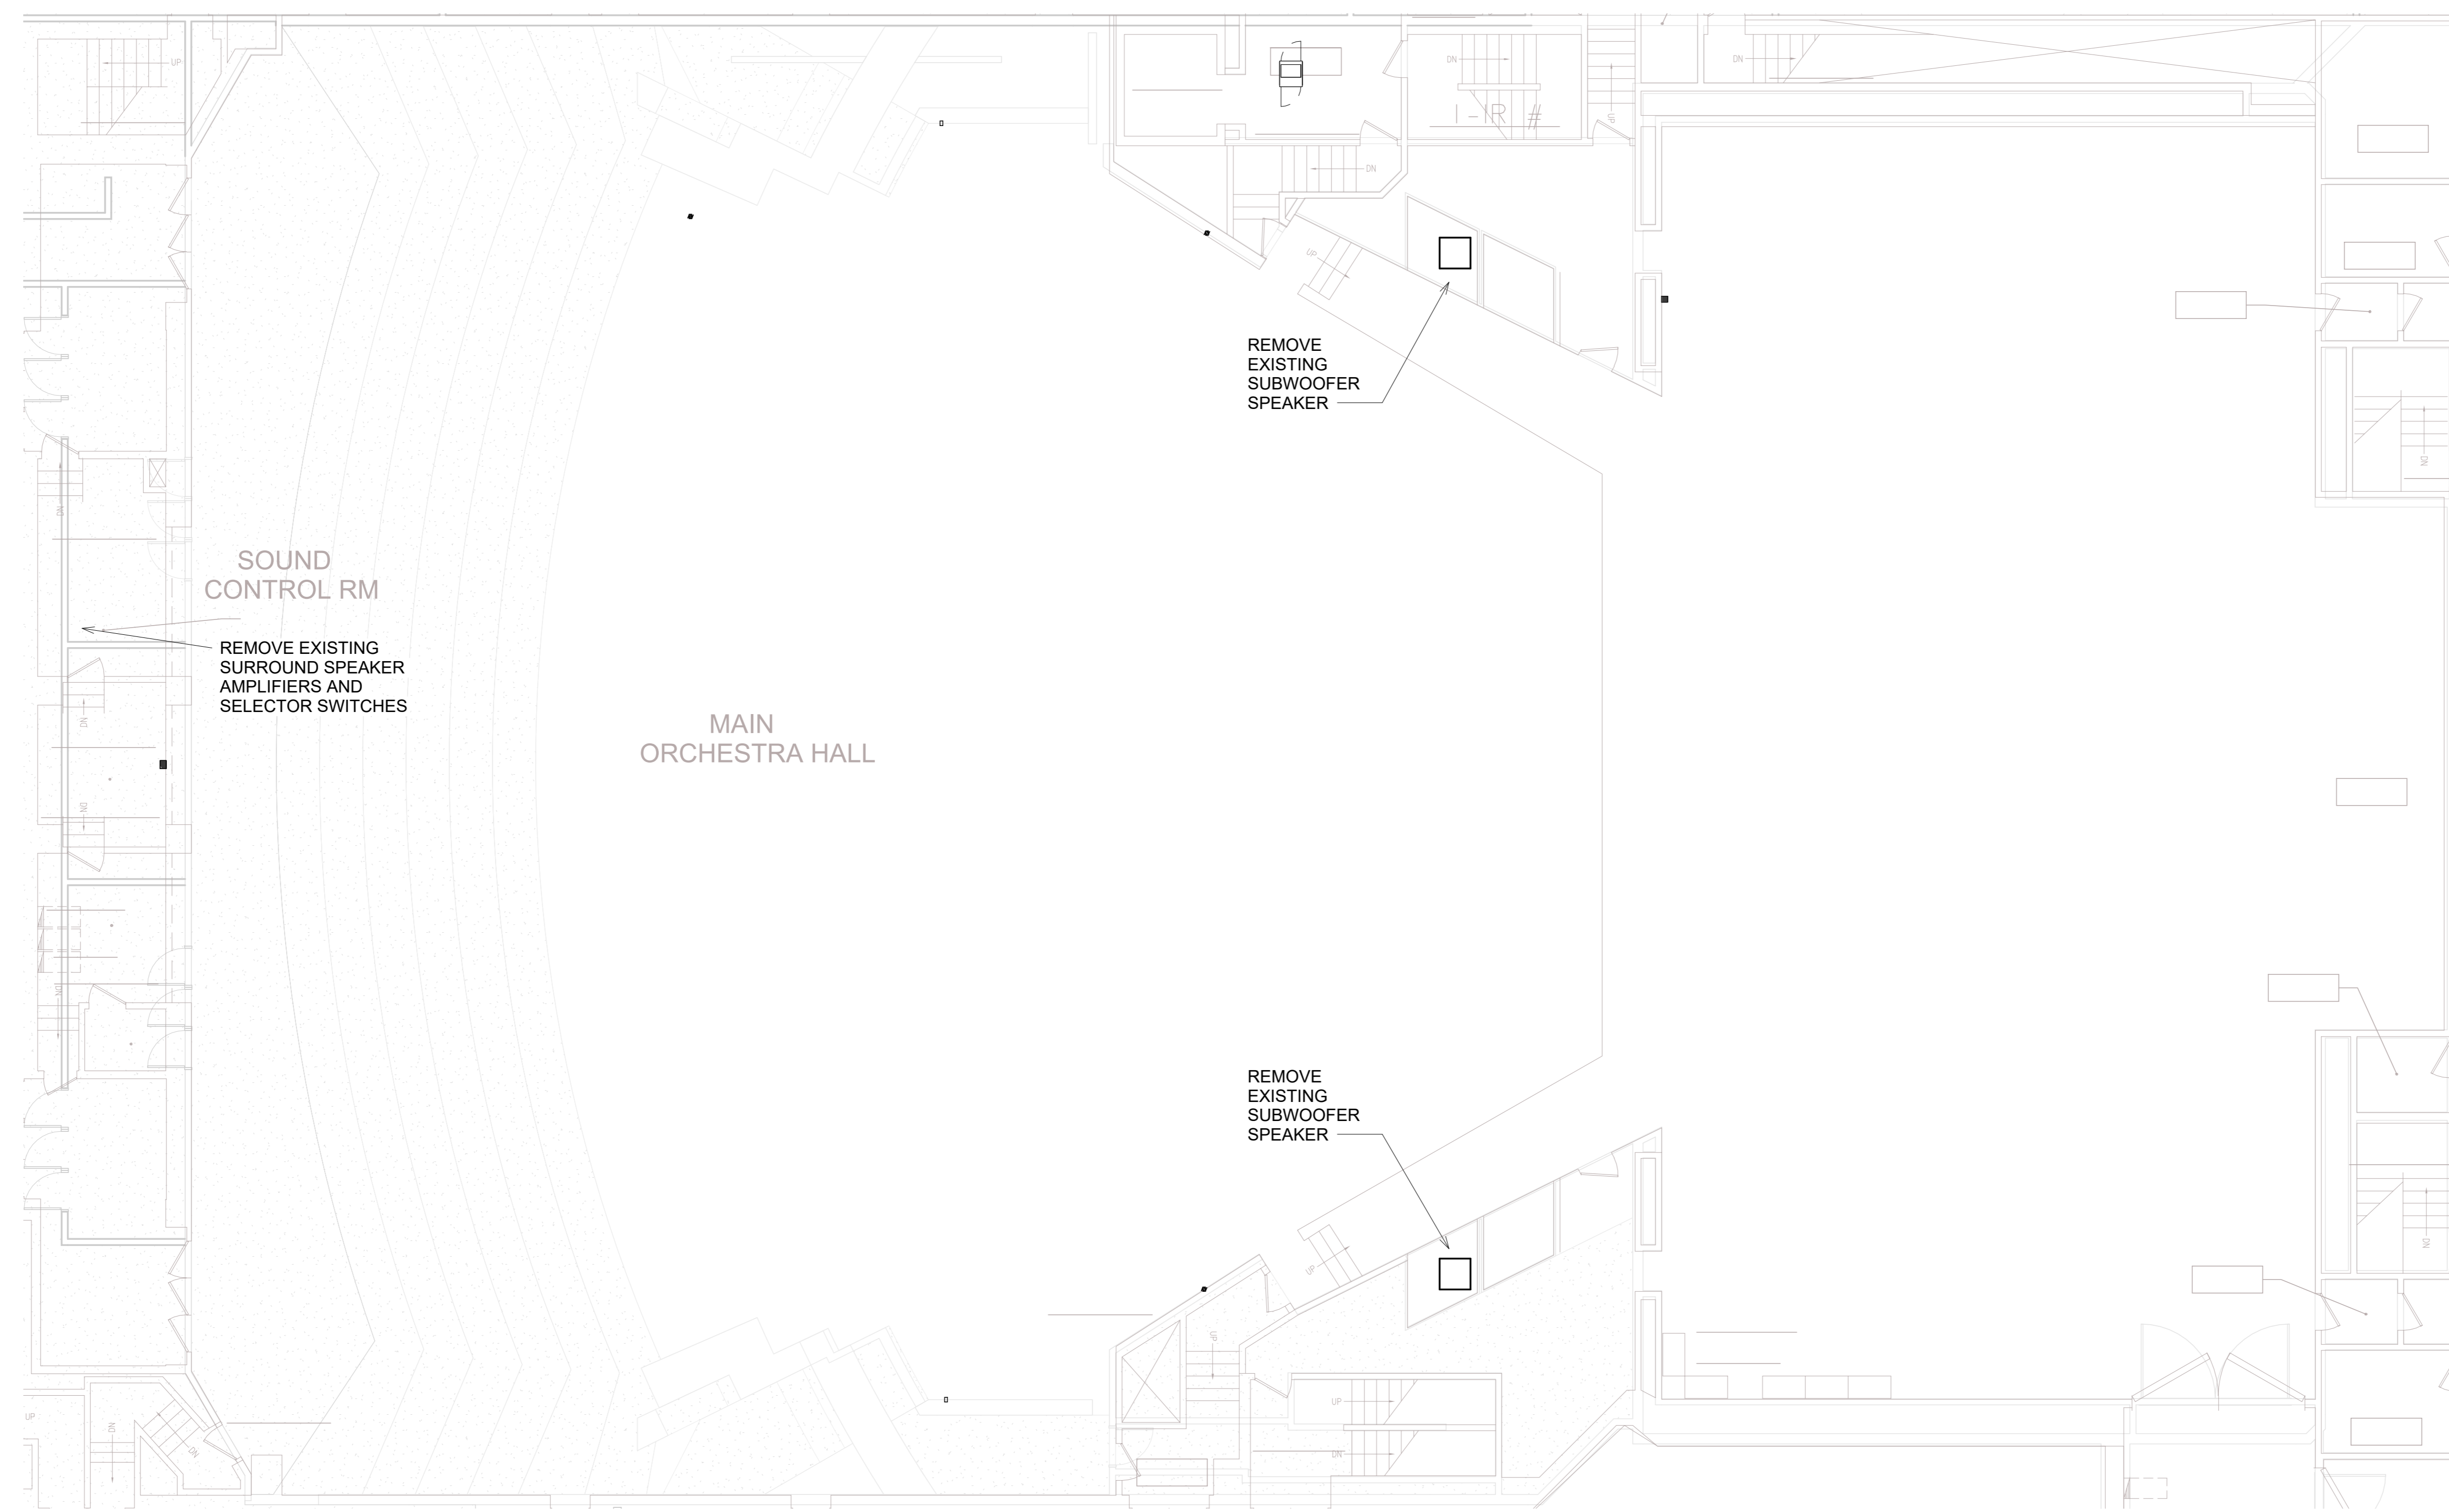
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AV114

AV 4th FLOOR PLAN -
CHAPMAN DEMO



① LEVEL 4 CHAPMAN DEMO
1/8" = 1'-0"



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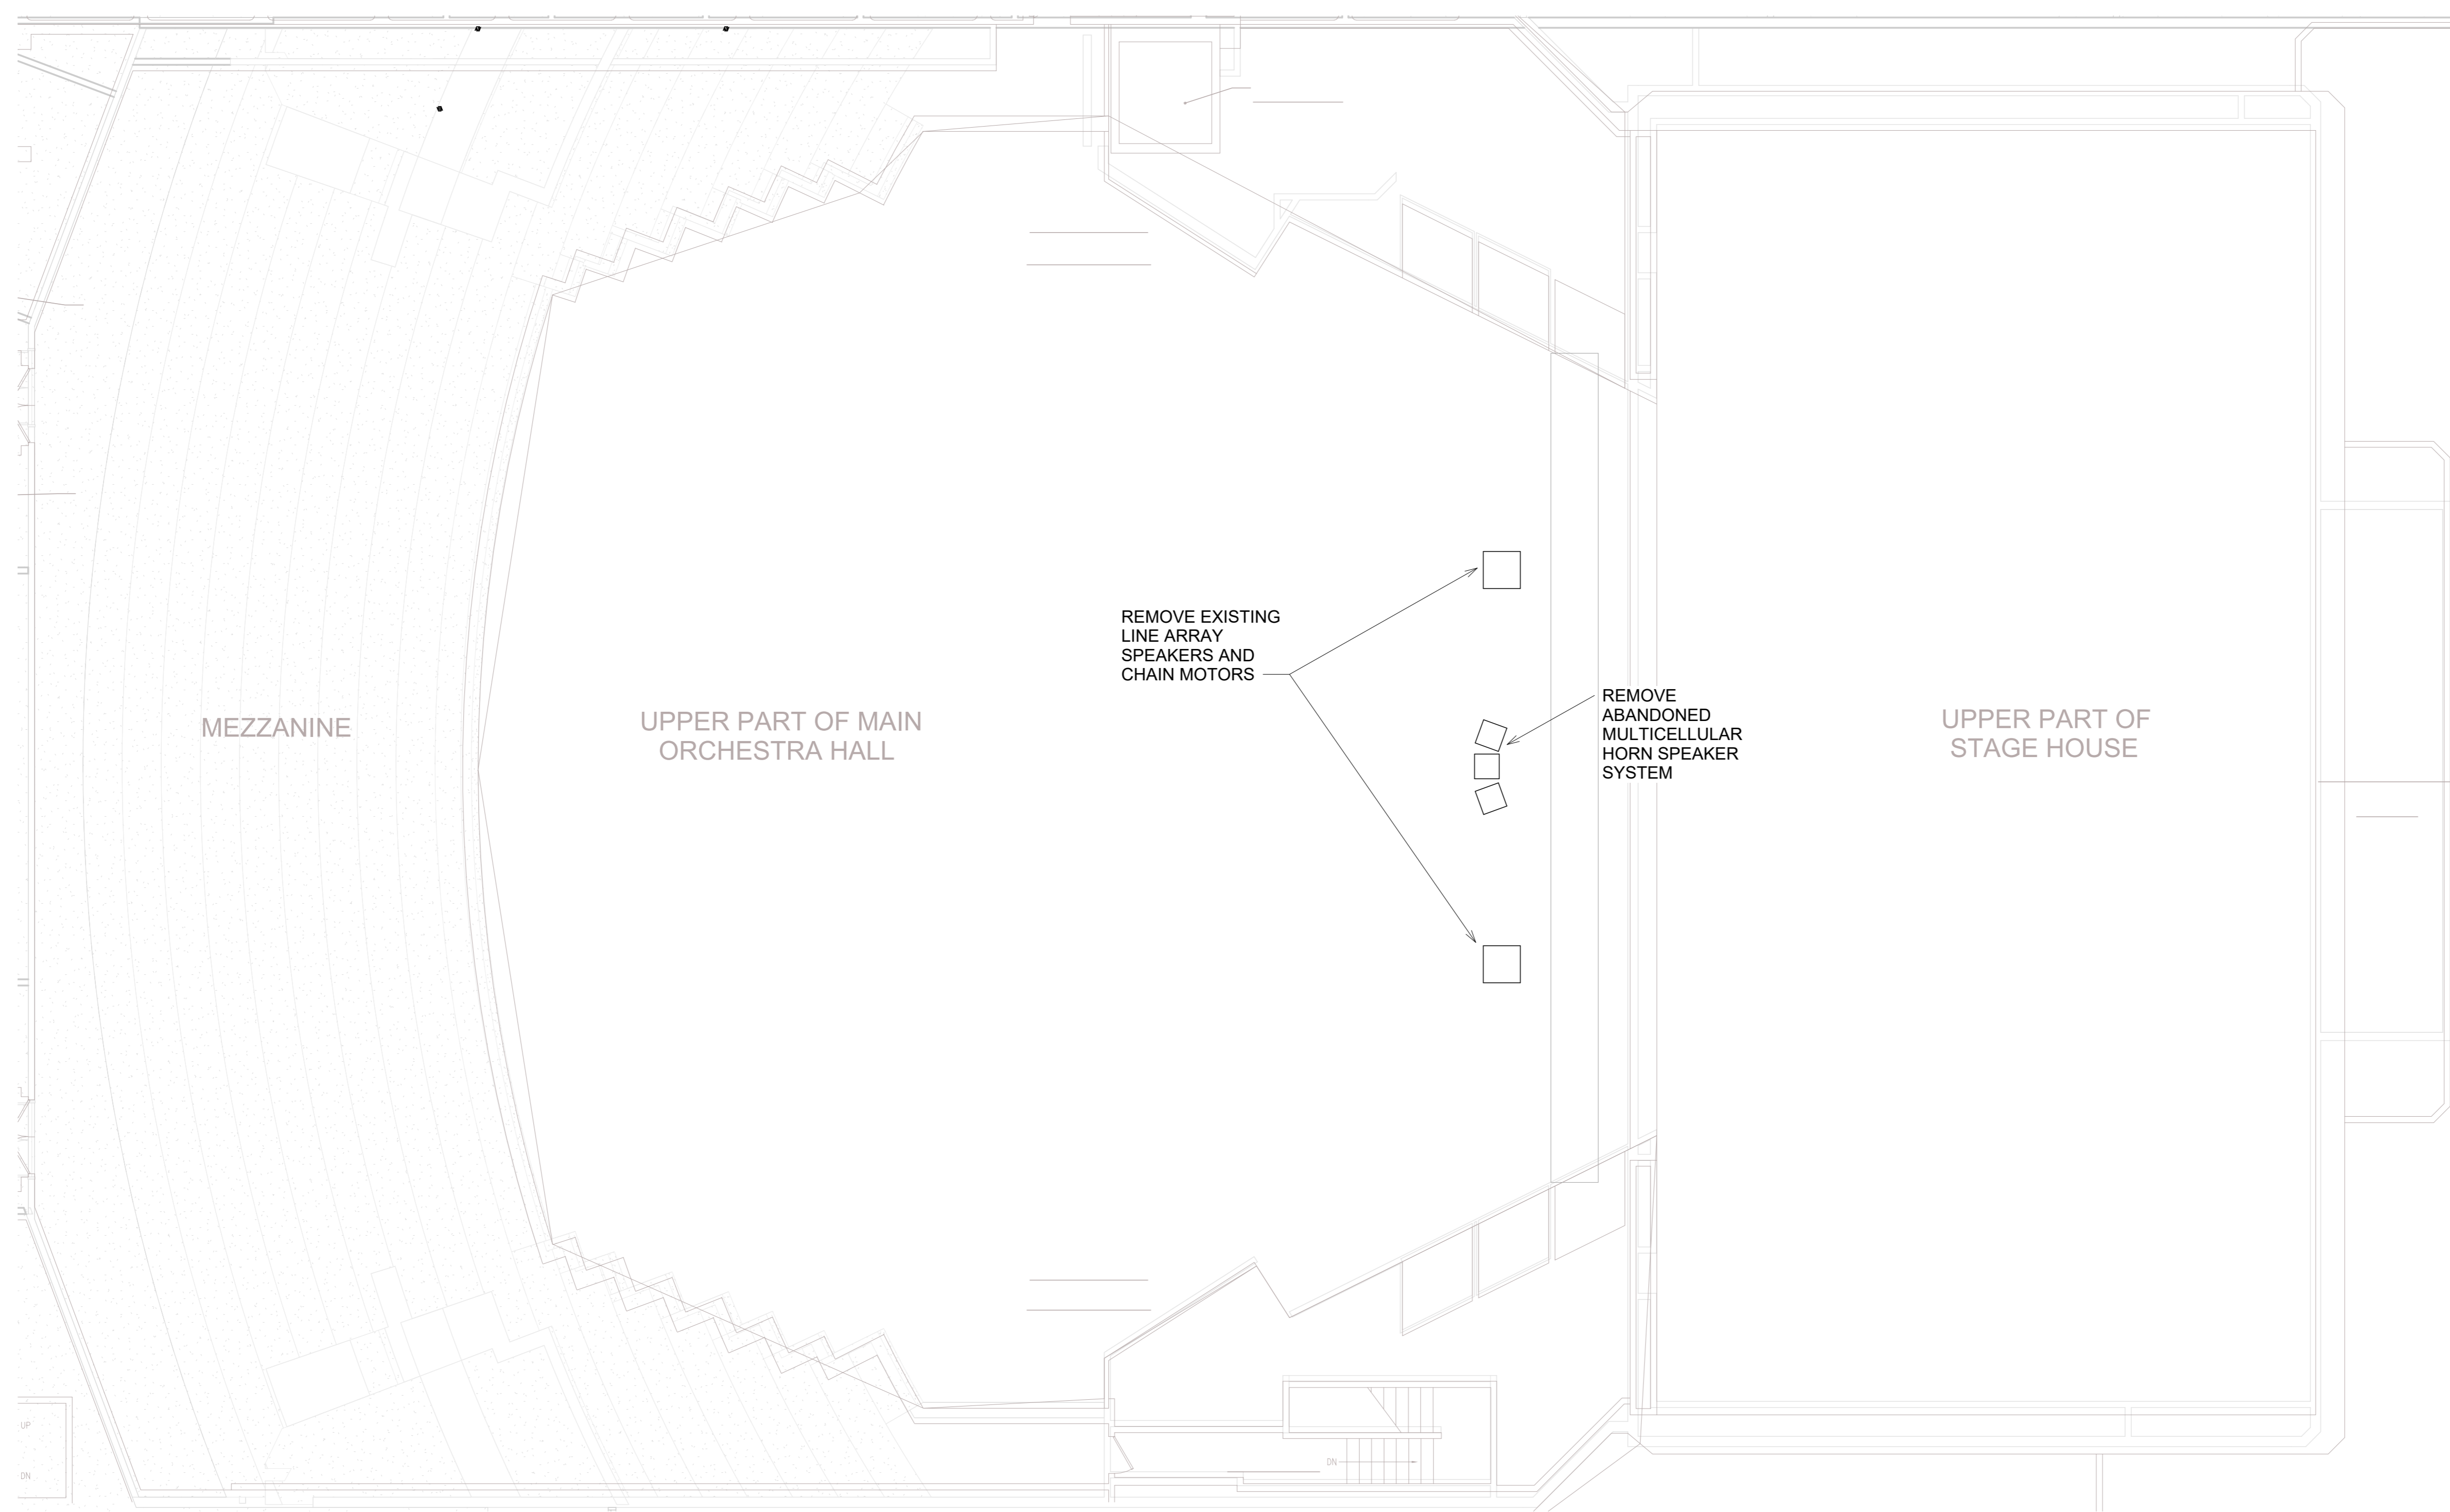
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AV115

AV 5th FLOOR PLAN -
CHAPMAN DEMO



① LEVEL 5 CHAPMAN DEMO
1/8" = 1'-0"



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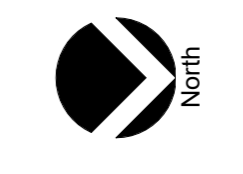
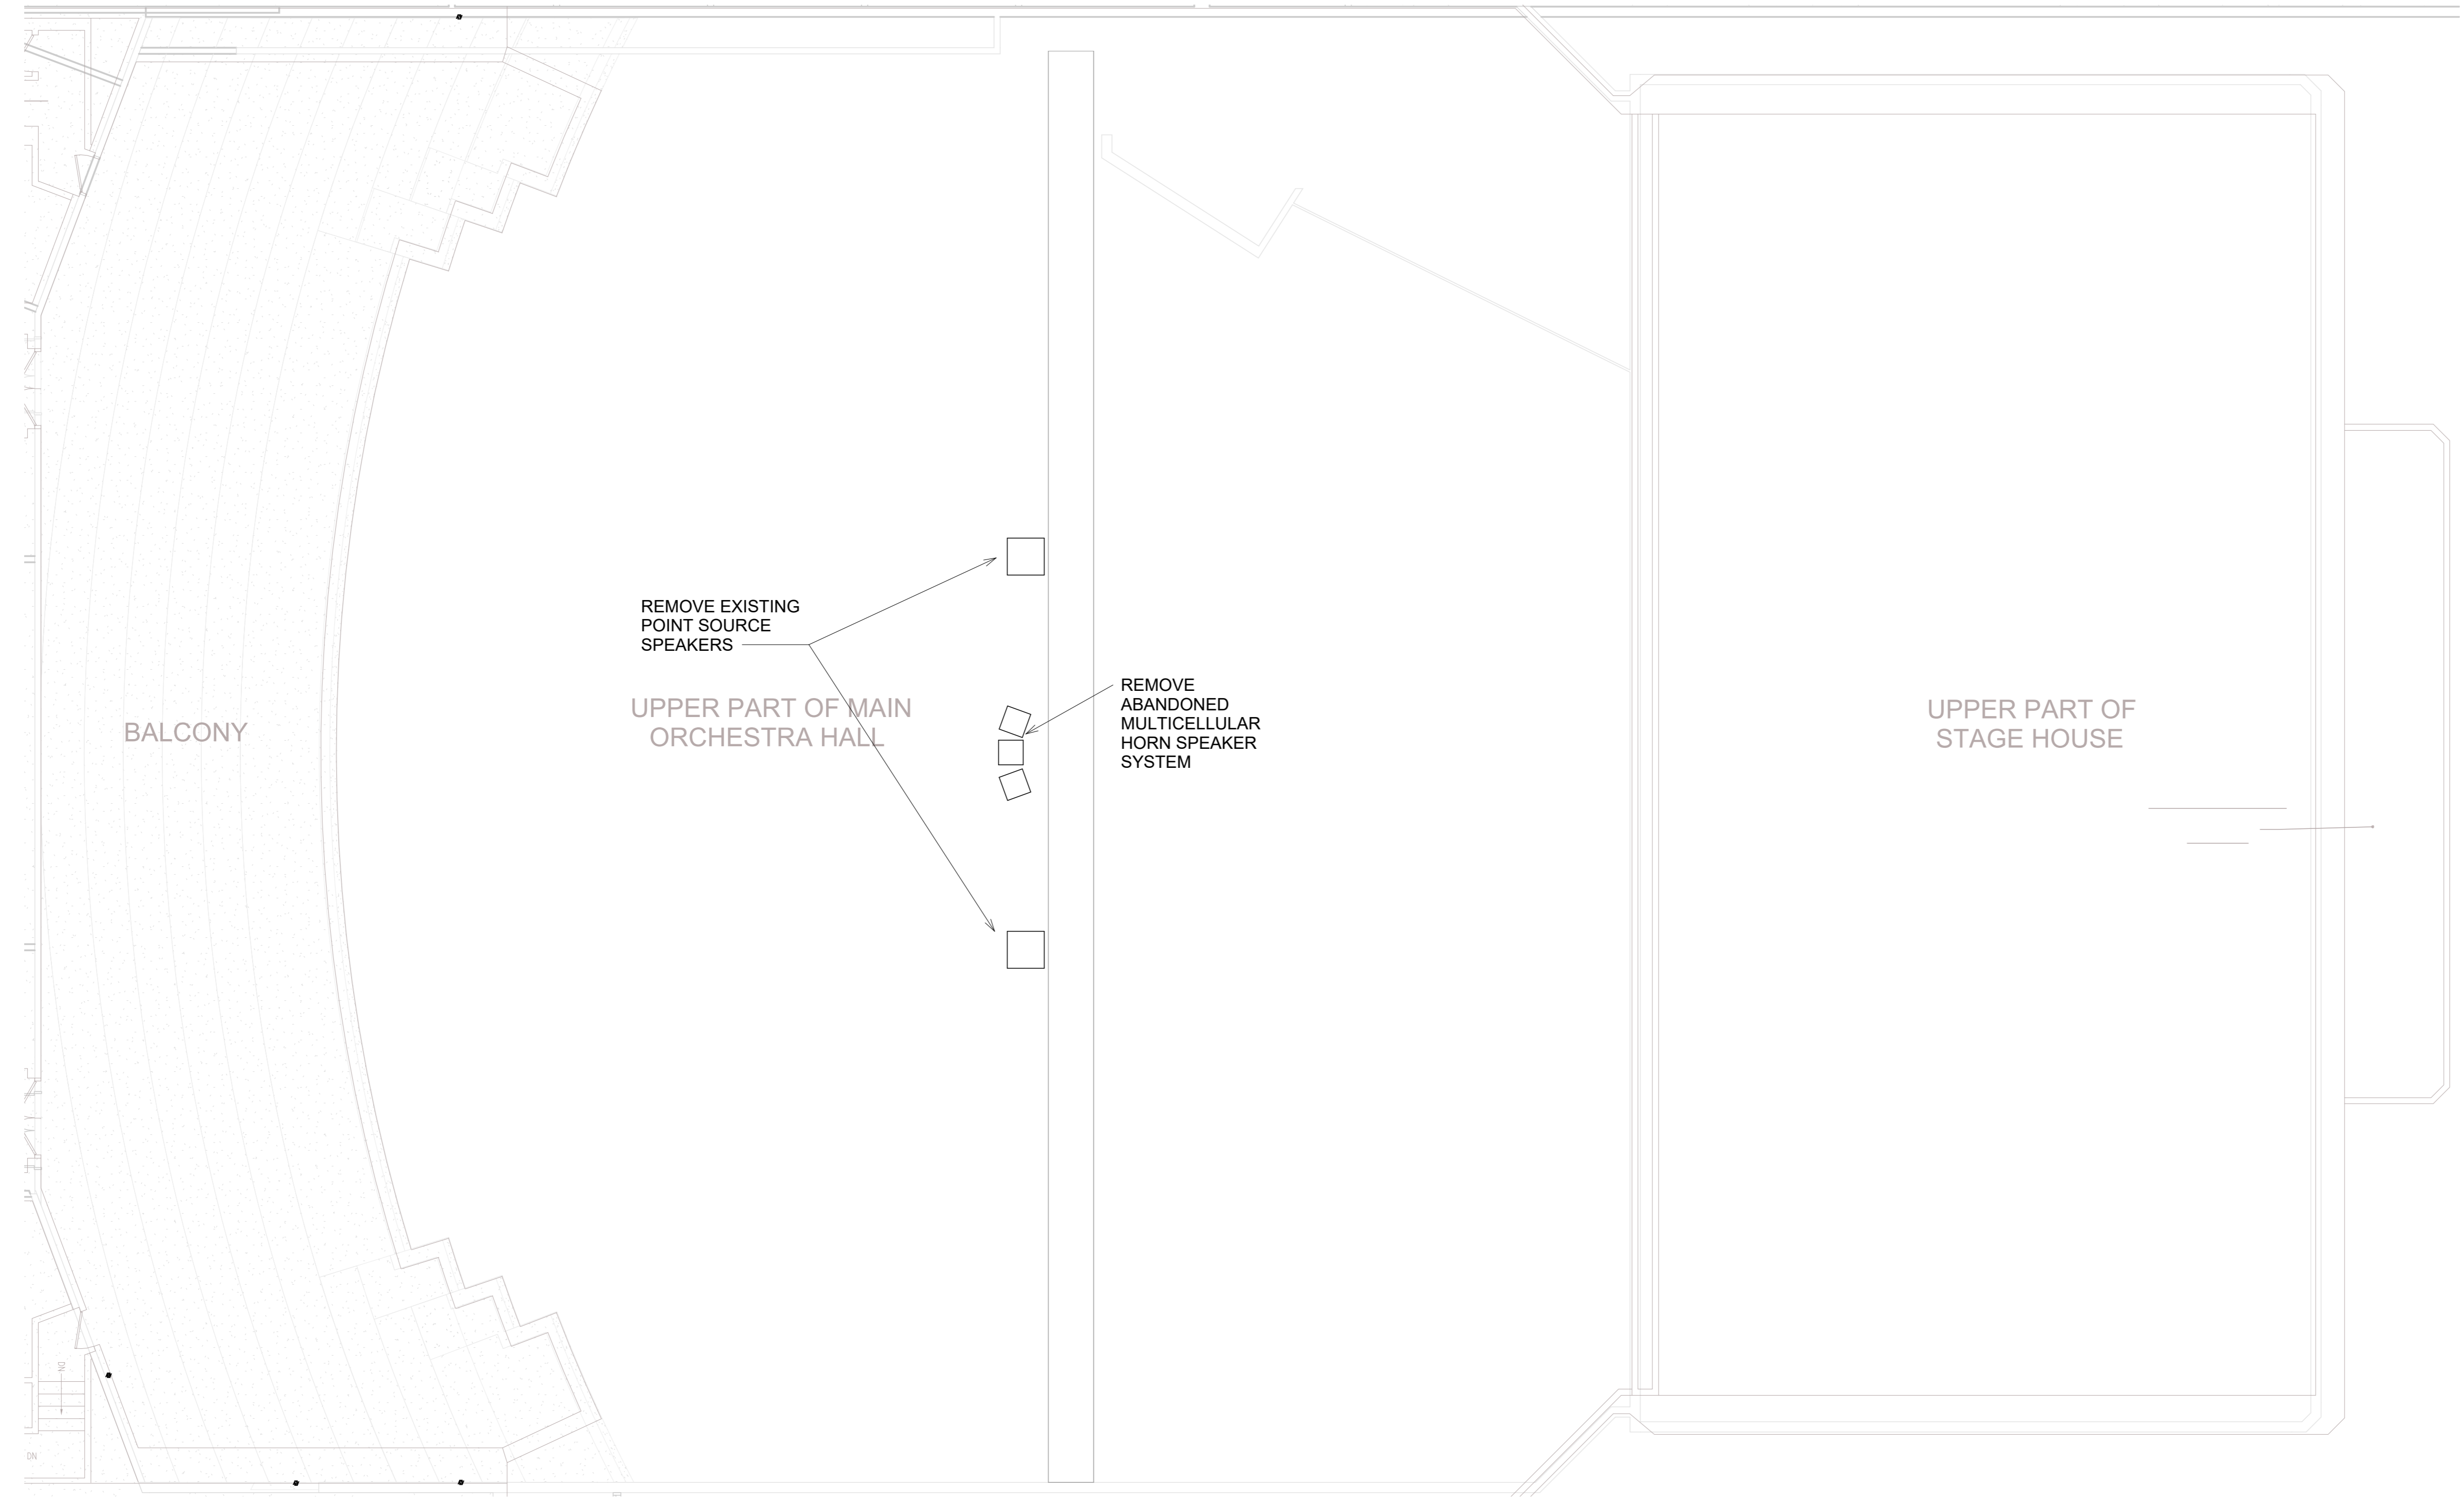
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AV116
AV 6th FLOOR PLAN -
CHAPMAN DEMO



① LEVEL 6 CHAPMAN DEMO
1/8" = 1'-0"

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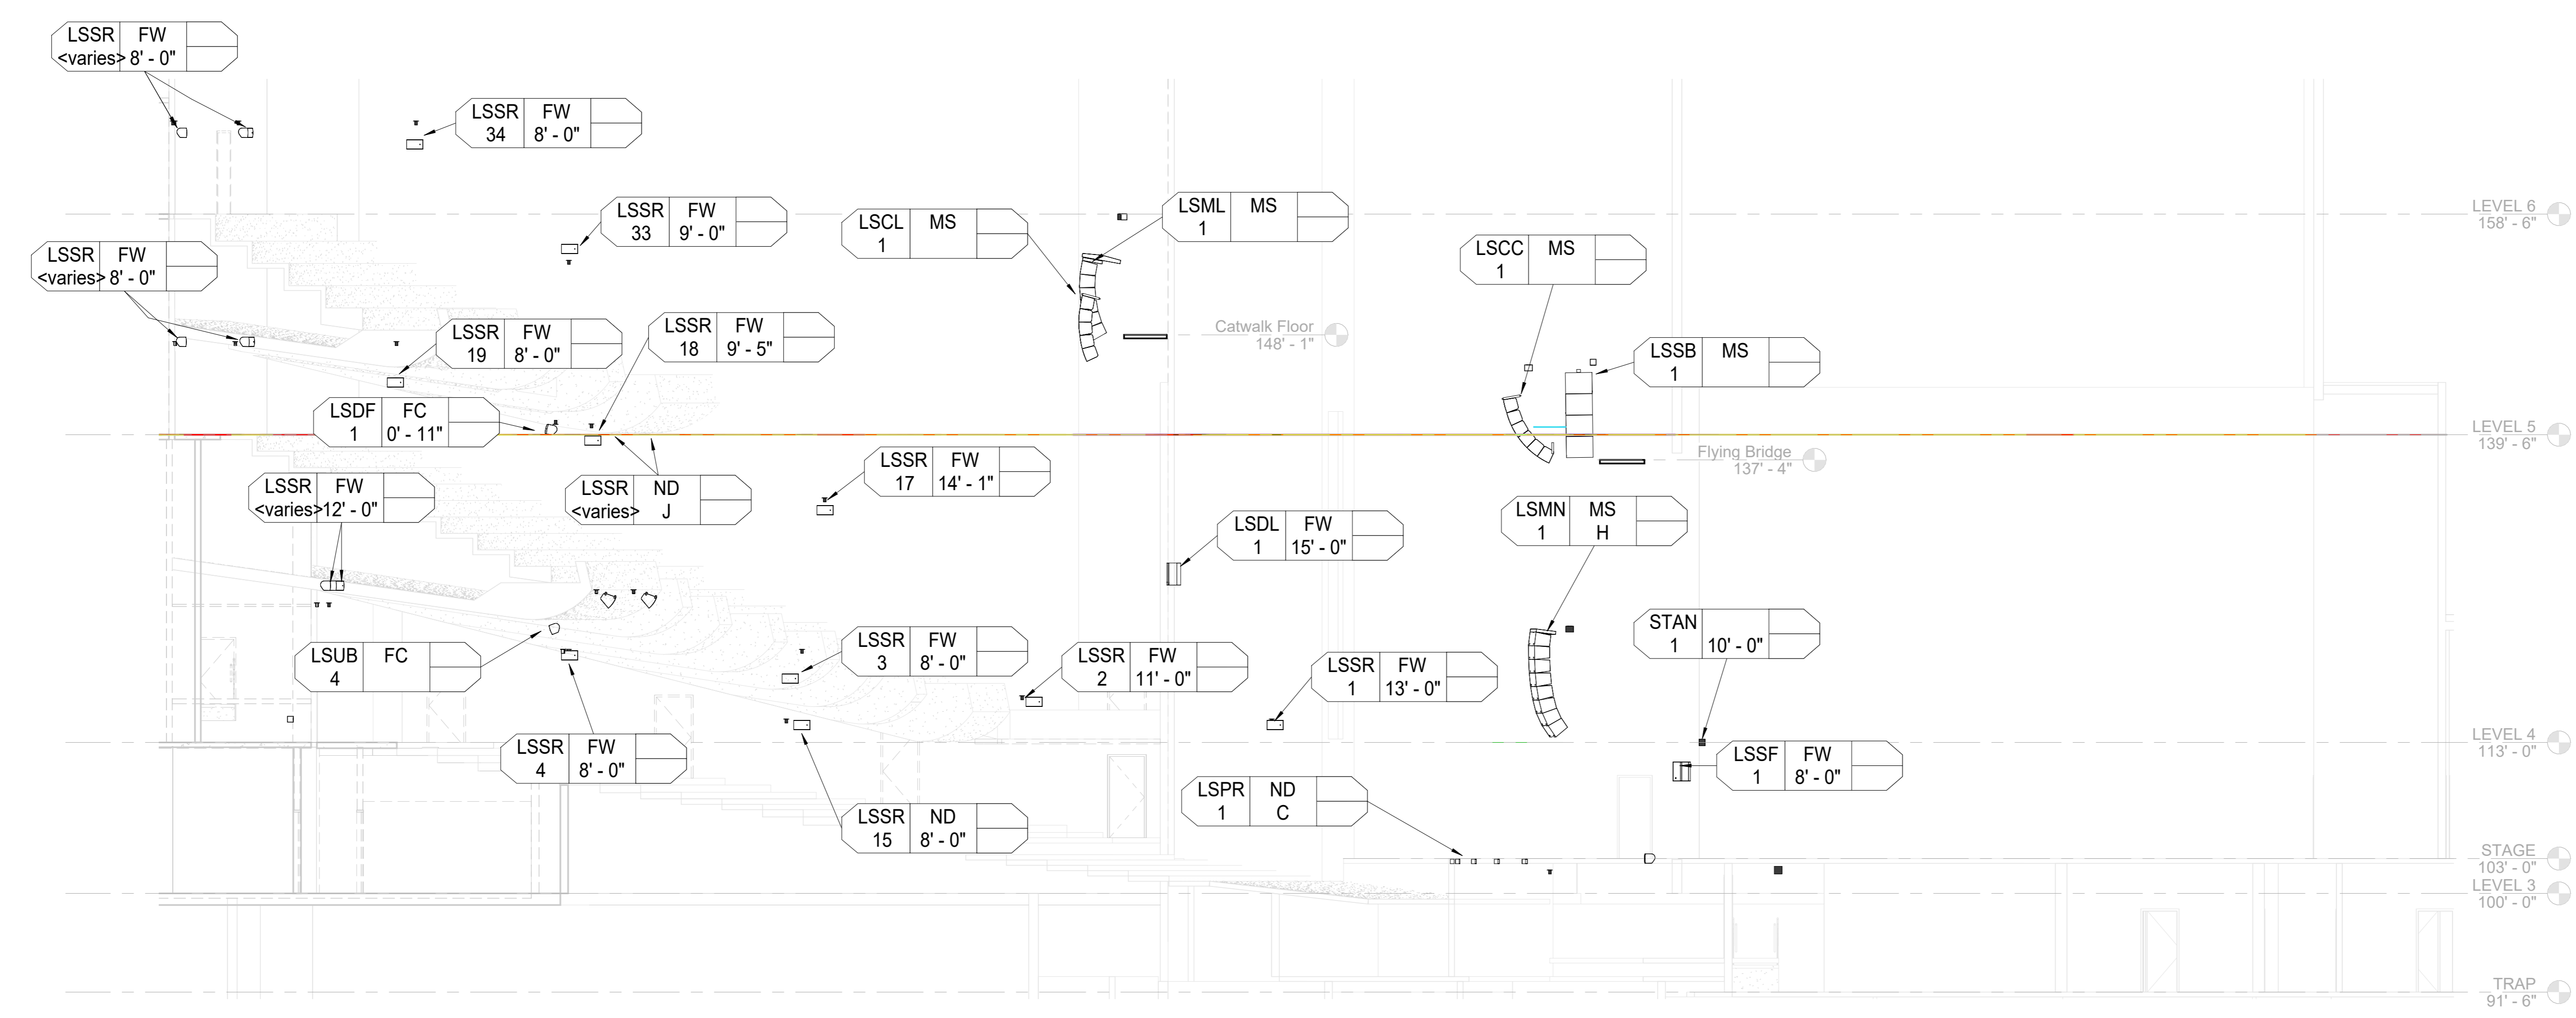
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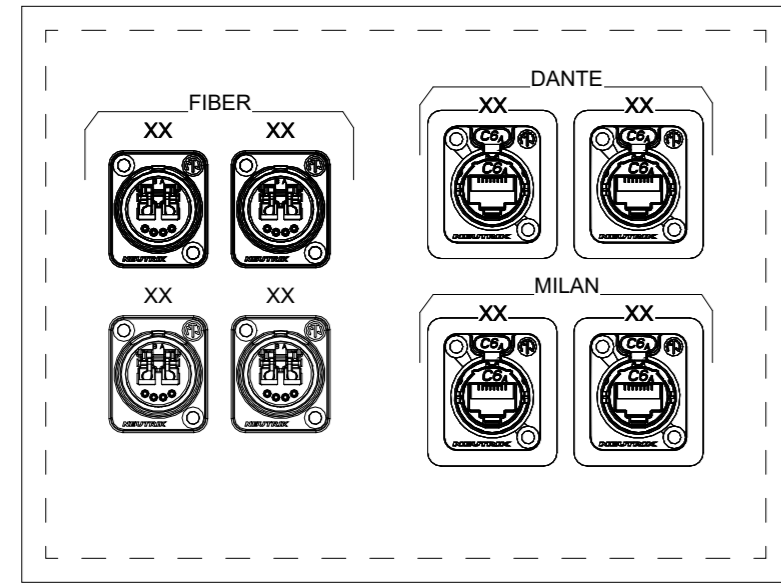
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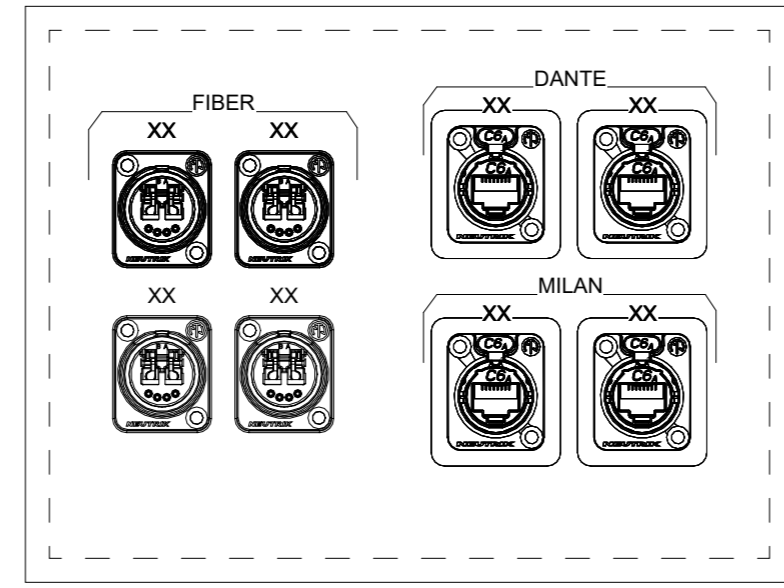
SHEET NUMBER:
AV301
AV SECTION -
CHAPMAN
CENTERLINE




① CHAPMAN CENTERLINE SECTION
 1/8" = 1'-0"




1 PANEL: HSMX - HOUSE MIX
AV BOX TYPE: 6X8X6




2 PANEL: CRMX - CONTROL ROOM MIX
AV BOX TYPE: 6X8X6

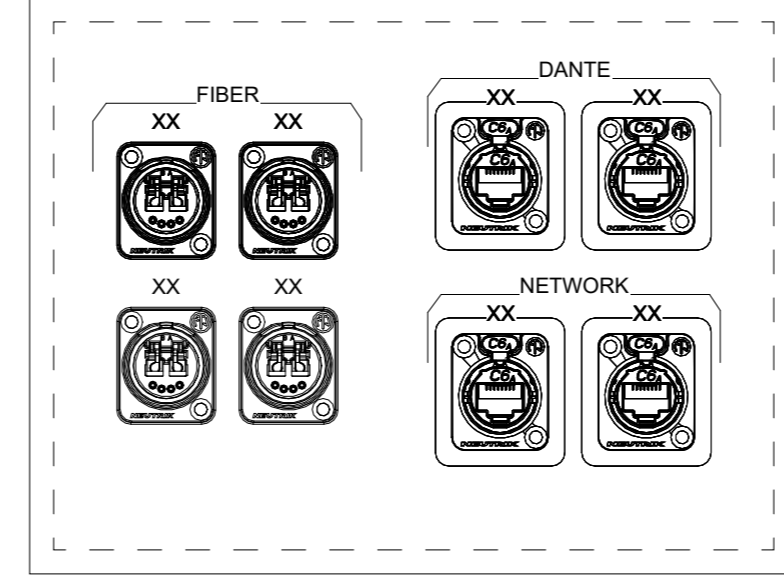


3 PANEL: CRCB - CONTROL CENTER BOOTH
AV BOX TYPE: 6X8X6

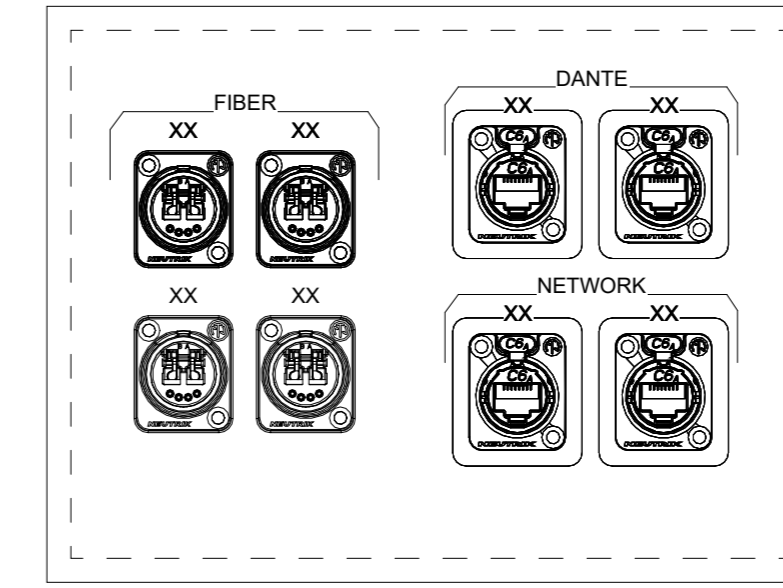


4 PANEL: STGA - STAGE A DS
AV BOX TYPE: 6X8X6

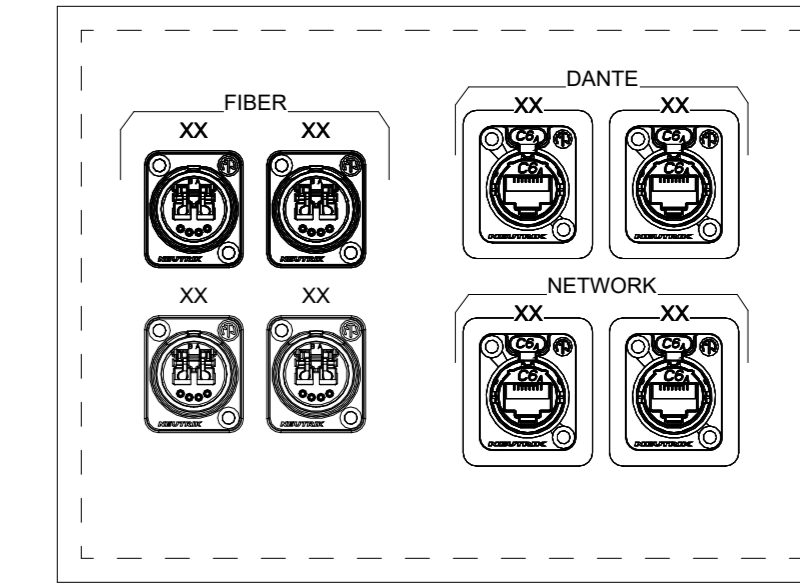


5 PANEL: STGB - STAGE B US
AV BOX TYPE: 6X8X6

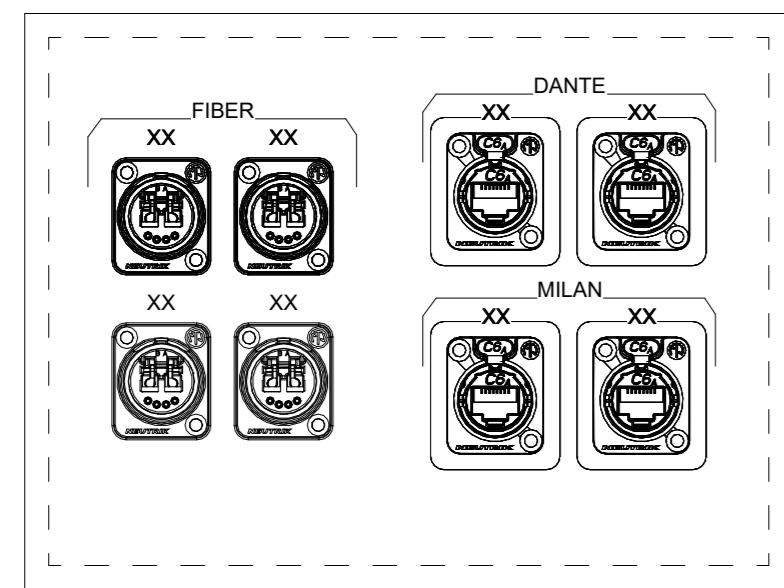


6 PANEL: STA2 - STAGE A2
AV BOX TYPE: 6X8X6

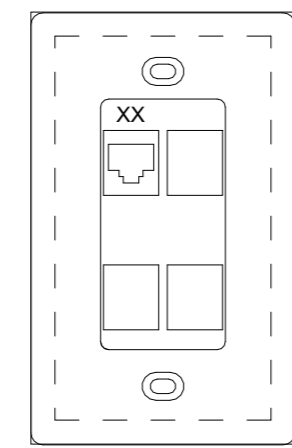


7 PANEL: STAN - STAGE ANTENNA
AV BOX TYPE: 1 GANG

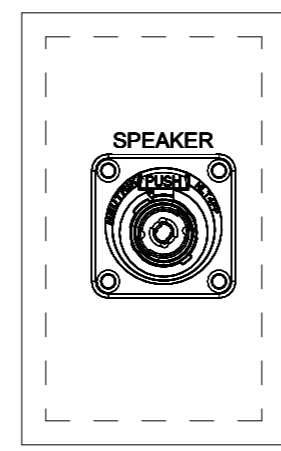


8 PANEL: LSSR - SURROUND LOUDSPEAKER
AV BOX TYPE: 1 GANG

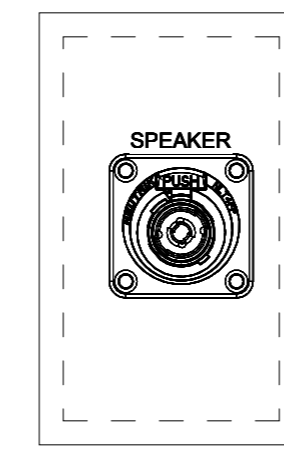


9 PANEL: LSDL - DELAY LOUDSPEAKER
AV BOX TYPE: 1 GANG

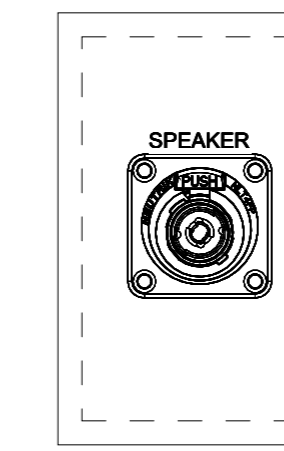


10 PANEL: LSSF - SIDE FILL LOUDSPEAKER
AV BOX TYPE: 1 GANG

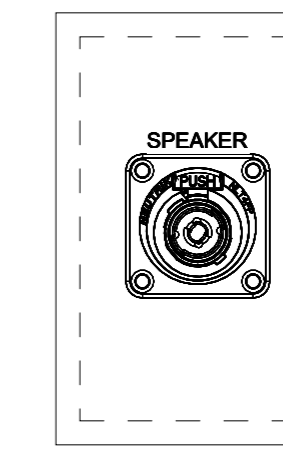


11 PANEL: LSDF - DELAY FILL LOUDSPEAKER
AV BOX TYPE: 1 GANG

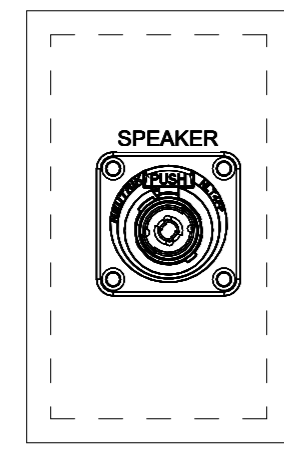


12 PANEL: LSUB - UNDERBALCONY LOUDSPEAKER
AV BOX TYPE: 1 GANG

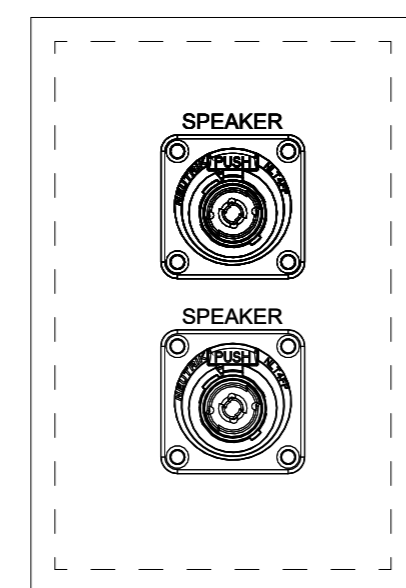


13 PANEL: LSPR - PIT RAIL LOUDSPEAKER
AV BOX TYPE: 6X4X4

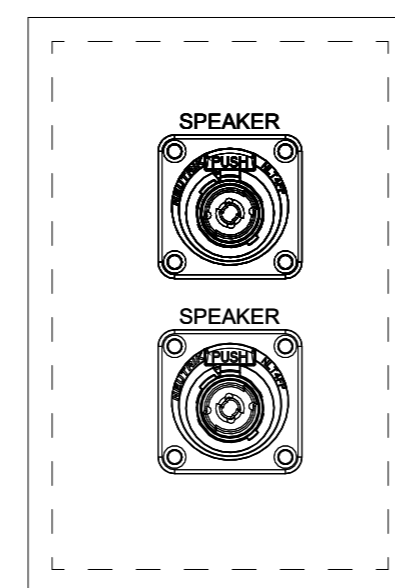


14 PANEL: LSSL - STAGE LIP LOUDSPEAKER
AV BOX TYPE: 6X4X4

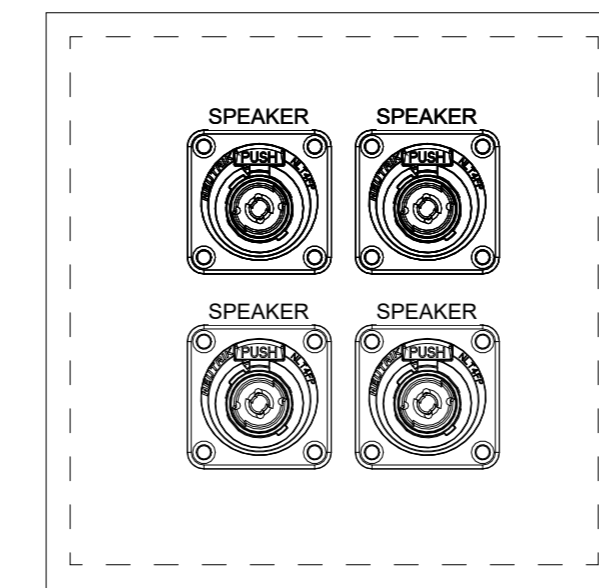


15 PANEL: LSCL - CENTER DELAY LOUDSPEAKER
AV BOX TYPE: 6X6X6

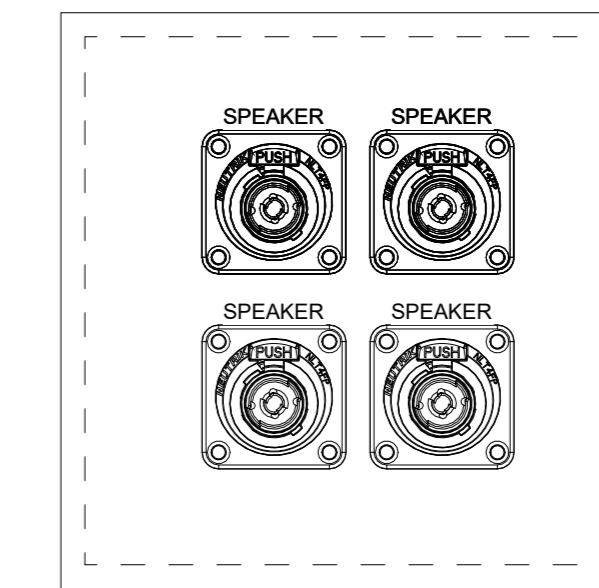


16 PANEL: LSSB - SUBWOOFER LOUDSPEAKER
AV BOX TYPE: 6X6X6

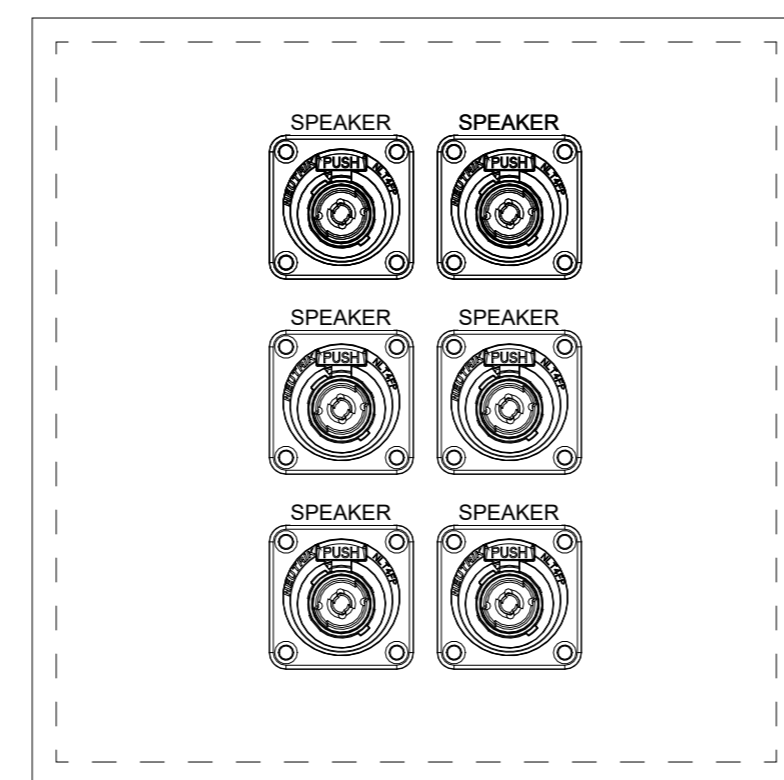

17 PANEL: LSCC - CENTER CLUSTER LOUDSPEAKER
AV BOX TYPE: 6X8X6

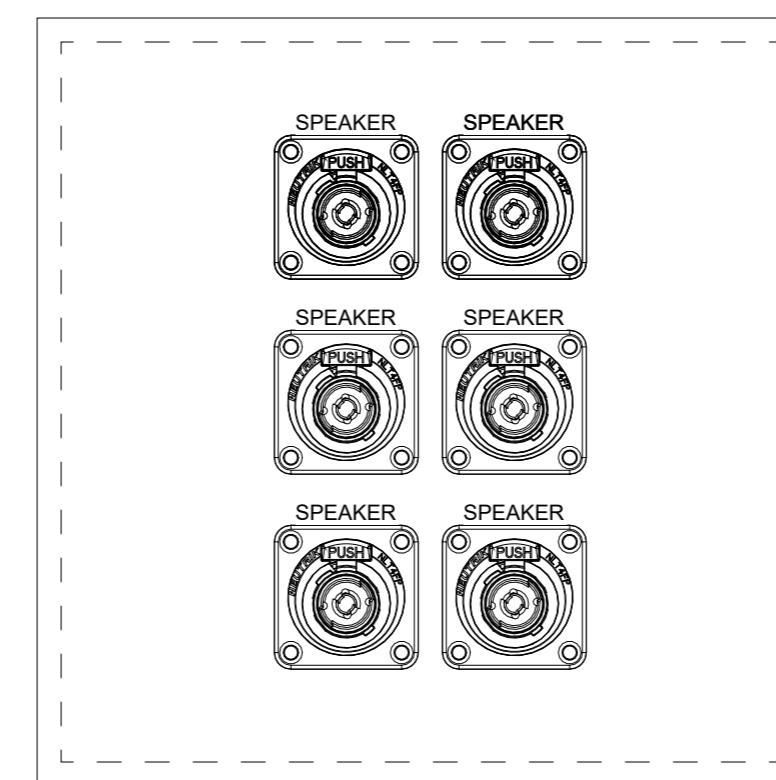

18 PANEL: LSML - MAIN DELAY LOUDSPEAKER
AV BOX TYPE: 6X8X6

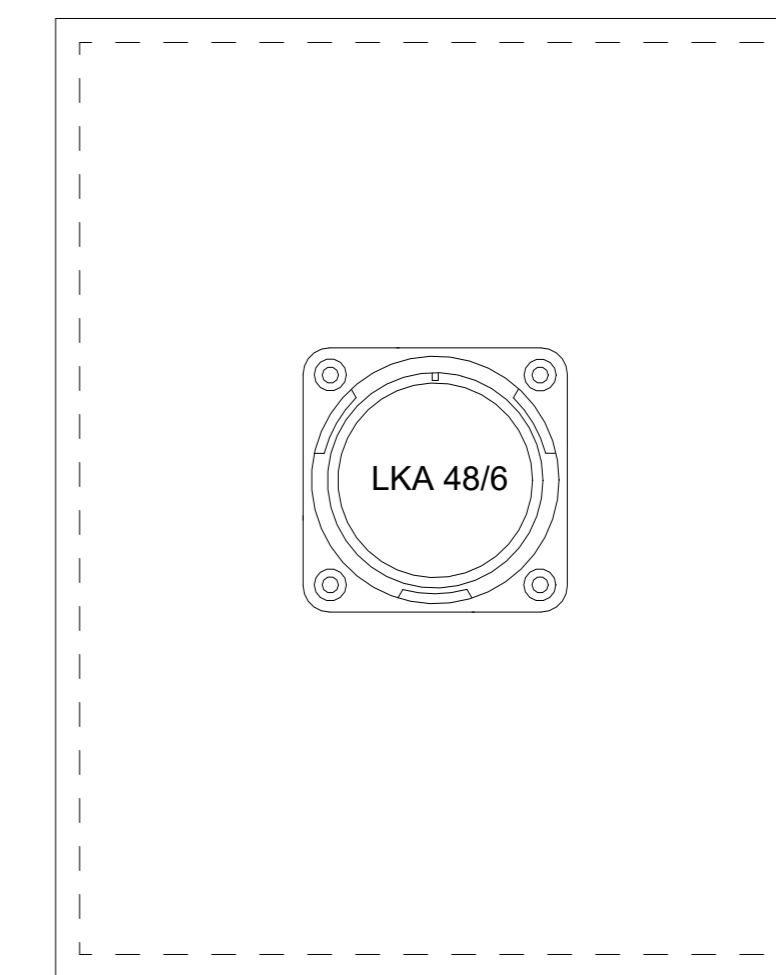

19 PANEL: LSMN - MAIN LOUDSPEAKER
AV BOX TYPE: 10X8X6



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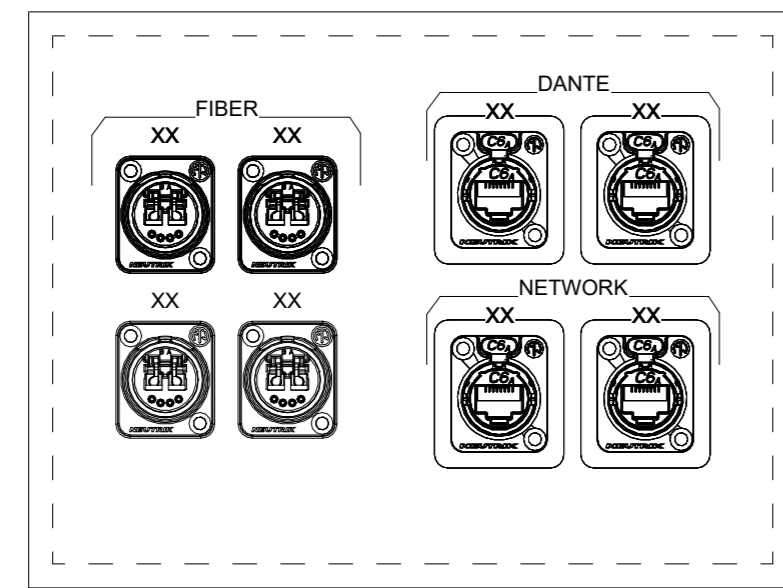
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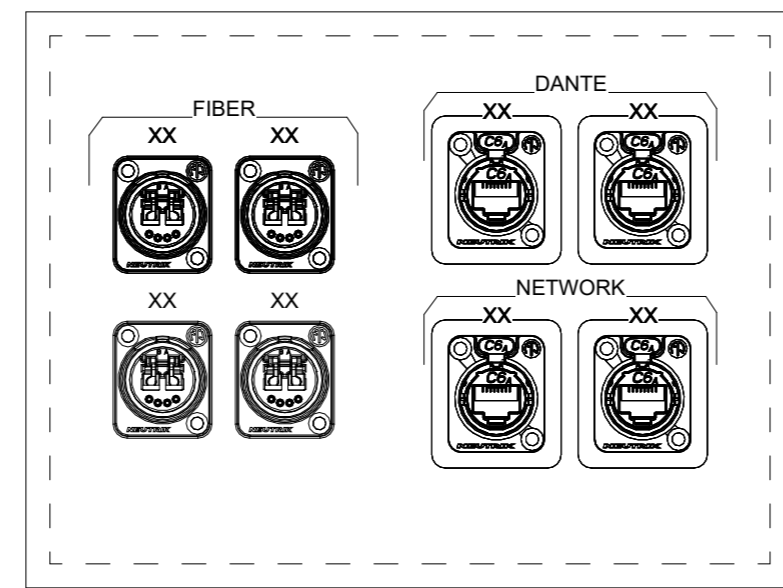
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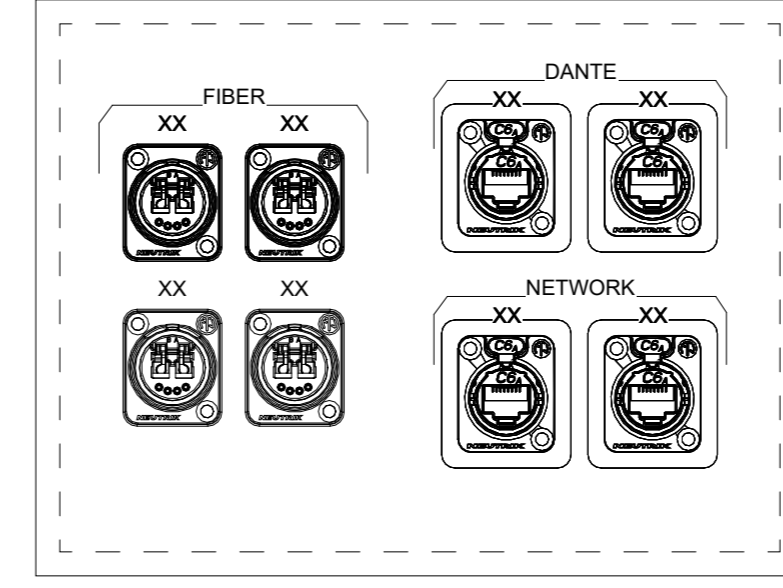
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AV521
AV PANEL DETAILS -
CHAPMAN 1




1 PANEL: STTR - STAGE TRAP ROOM
AV BOX TYPE: 6X8X6




2 PANEL: PITA - PIT TYPE A
AV BOX TYPE: 6X8X6




3 PANEL: BSGR - BACKSTAGE GREEN ROOM
AV BOX TYPE: 6X8X6

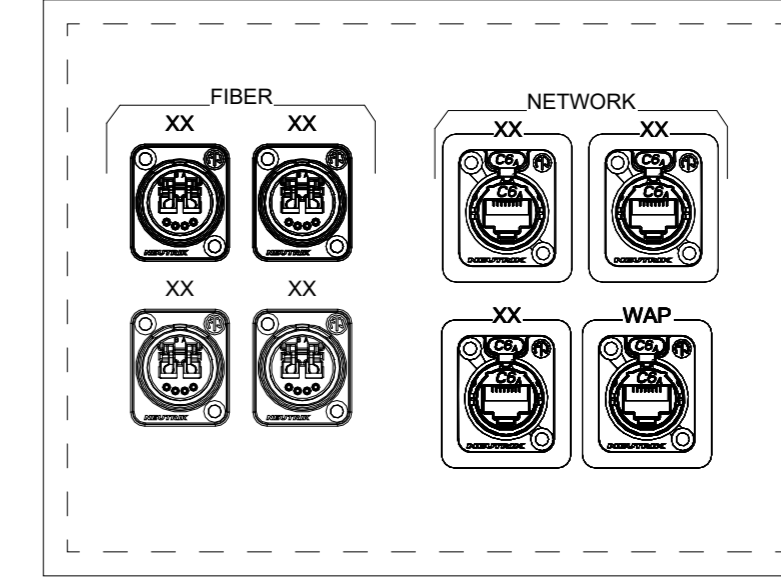

4 PANEL: HSBR - HOUSE BALCONY RAIL
AV BOX TYPE: 6X8X6

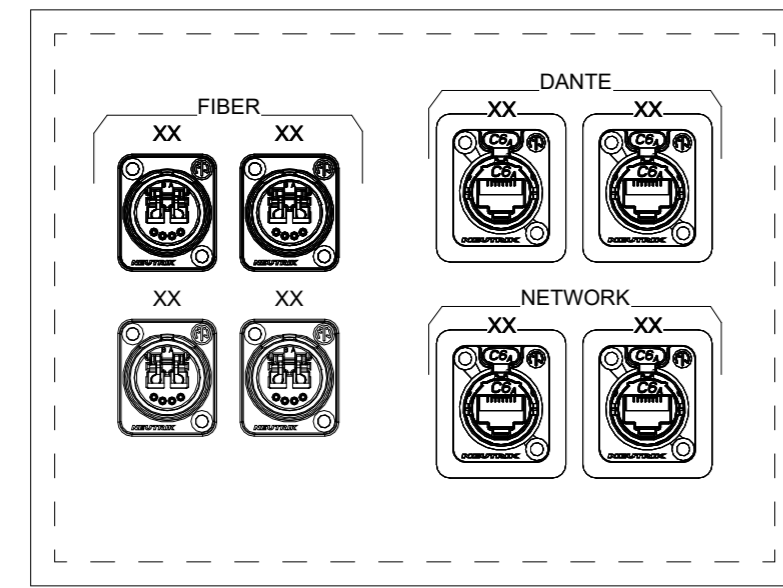

5 PANEL: BSNC - BACKSTAGE NETWORK CLOSET
AV BOX TYPE: 6X8X6

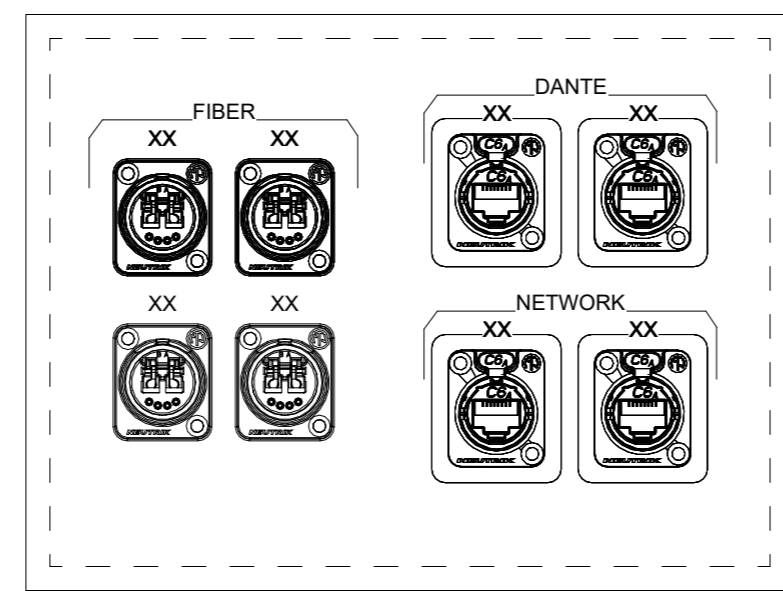


6 PANEL: BSTD - BACKSTAGE TECHNICAL OFFICE
AV BOX TYPE: 6X8X6


REVISIONS:

No	Description	Date


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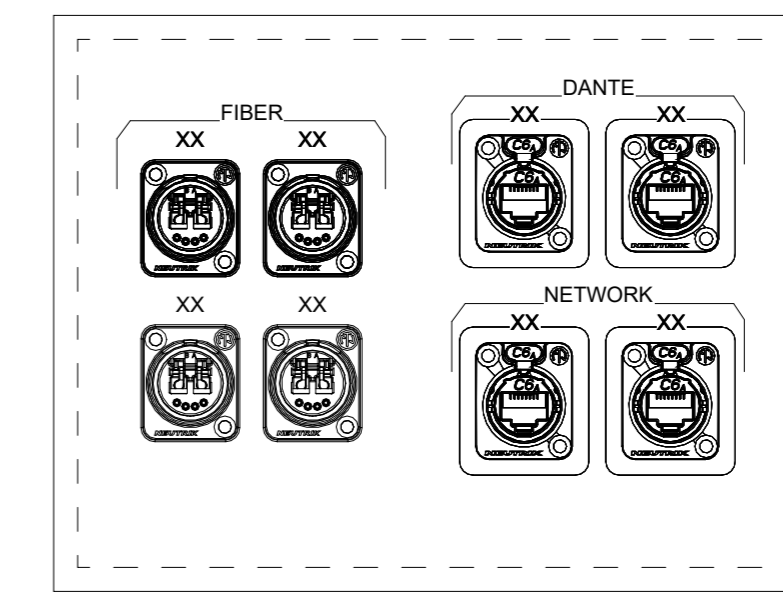
1 PANEL: WHMX - WILLIAMS HOUSE MIX
AV BOX TYPE: 6X8X6

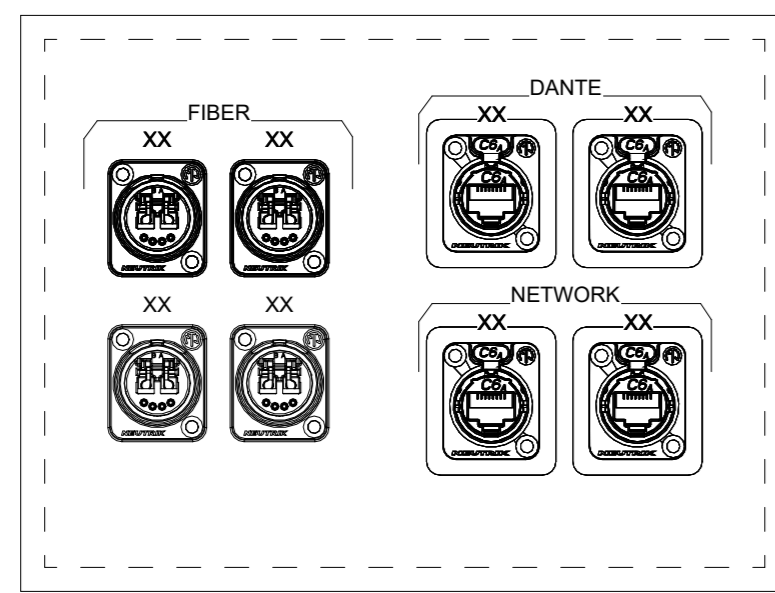


2 PANEL: WCMX - WILLIAMS CONTROL RM MIX
AV BOX TYPE: 6X8X6

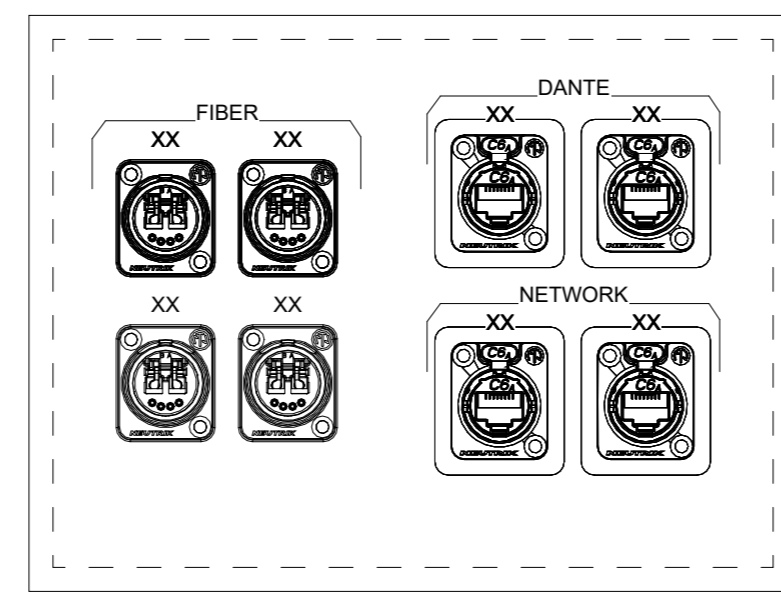


3 PANEL: WSGA - WILLIAMS STAGE A
AV BOX TYPE: 6X8X6

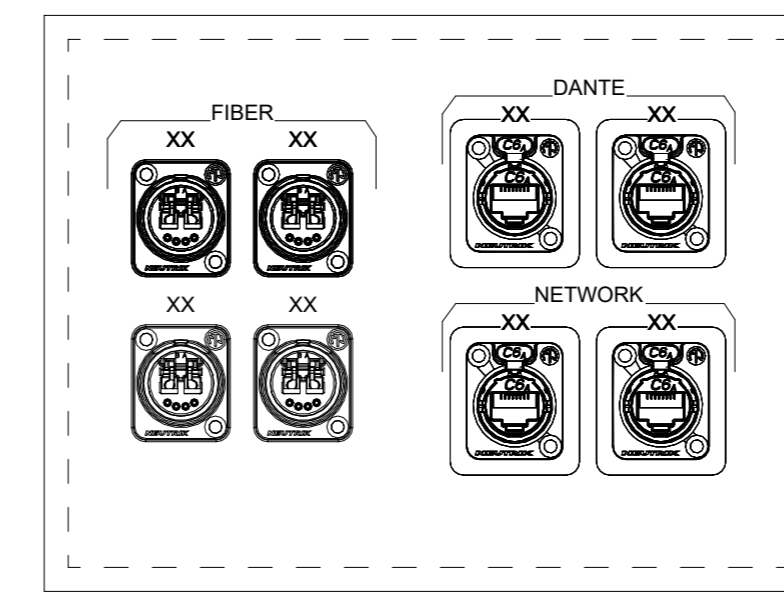


4 PANEL: WSGB - WILLIAMS STAGE B
AV BOX TYPE: 6X8X6

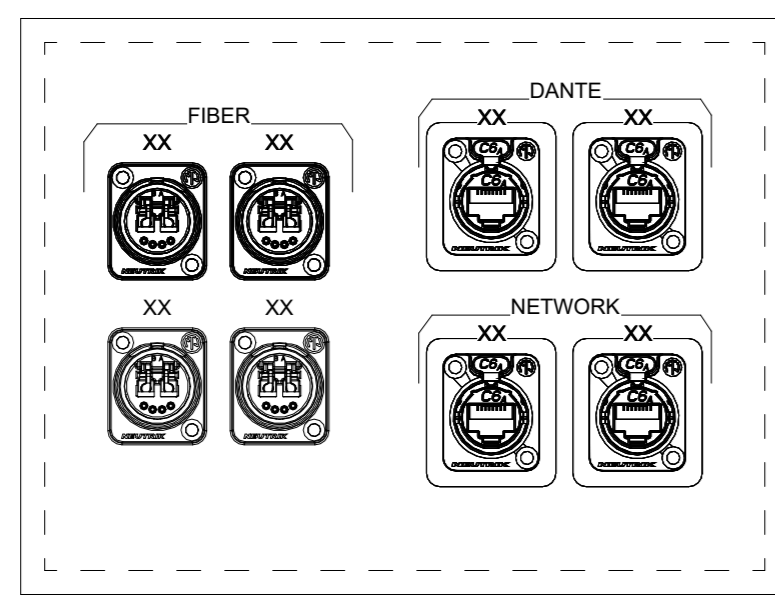


5 PANEL: WSA2 - WILLIAMS STAGE A2
AV BOX TYPE: 6X8X6

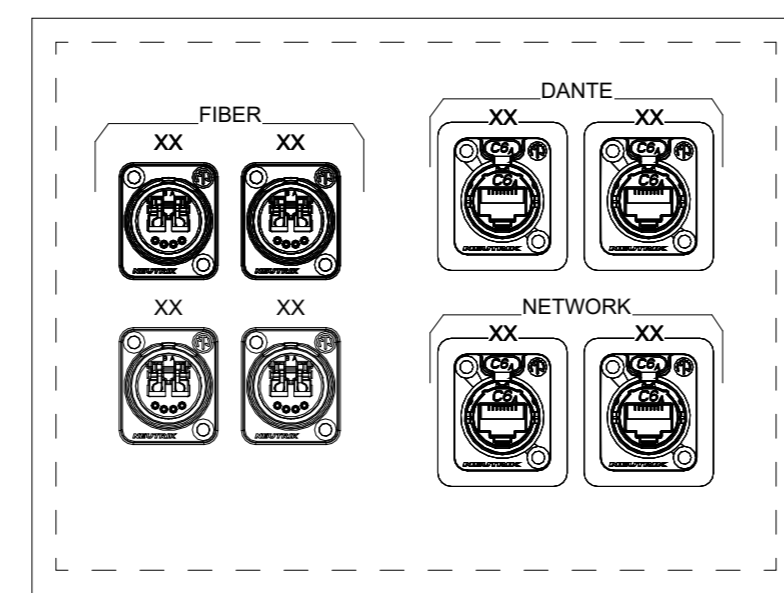

6 PANEL: WBGR - WILLIAMS GREEN ROOM
AV BOX TYPE: 6X8X6

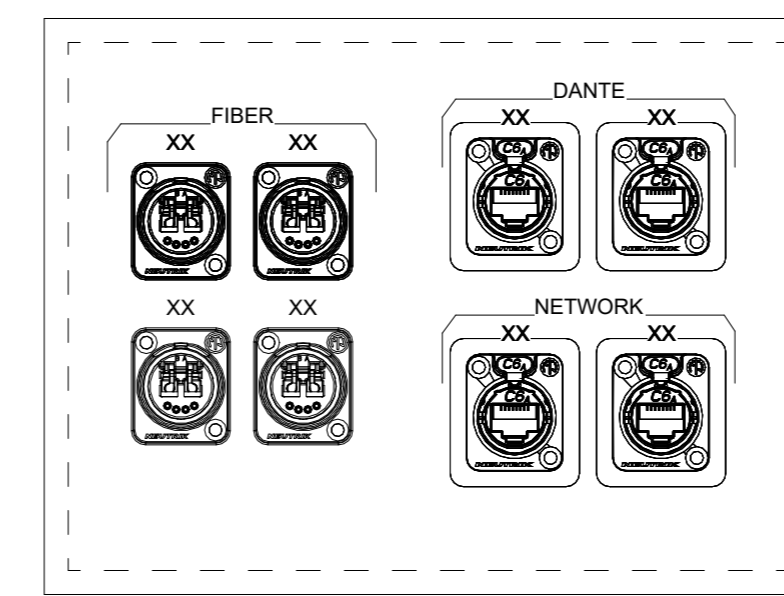

7 PANEL: WPTA - WILLIAMS PIT TYPE A
AV BOX TYPE: 6X8X6

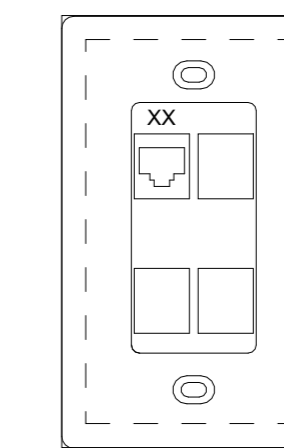

8 PANEL: WHAN - WILLIAMS STAGE ANTENNA
AV BOX TYPE: 1 GANG



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F: 918.585.1967

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SUITE 135
OKLAHOMA CITY, OK 73102
T: 405.232.7007

PROJECT:
TULSA
PERFORMING
ARTS CENTER

PROJECT NUMBER:
202331.00

CONSULTANT:



REVISIONS:

No	Description	Date

SEAL:

ISSUE DATE:
1.24.2024

SHEET NUMBER:

AV523
AV PANEL DETAILS -
WILLIAMS



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PROJECT:
TULSA
PERFORMING
ARTS CENTER

PROJECT NUMBER:
202331.00

CONSULTANT:

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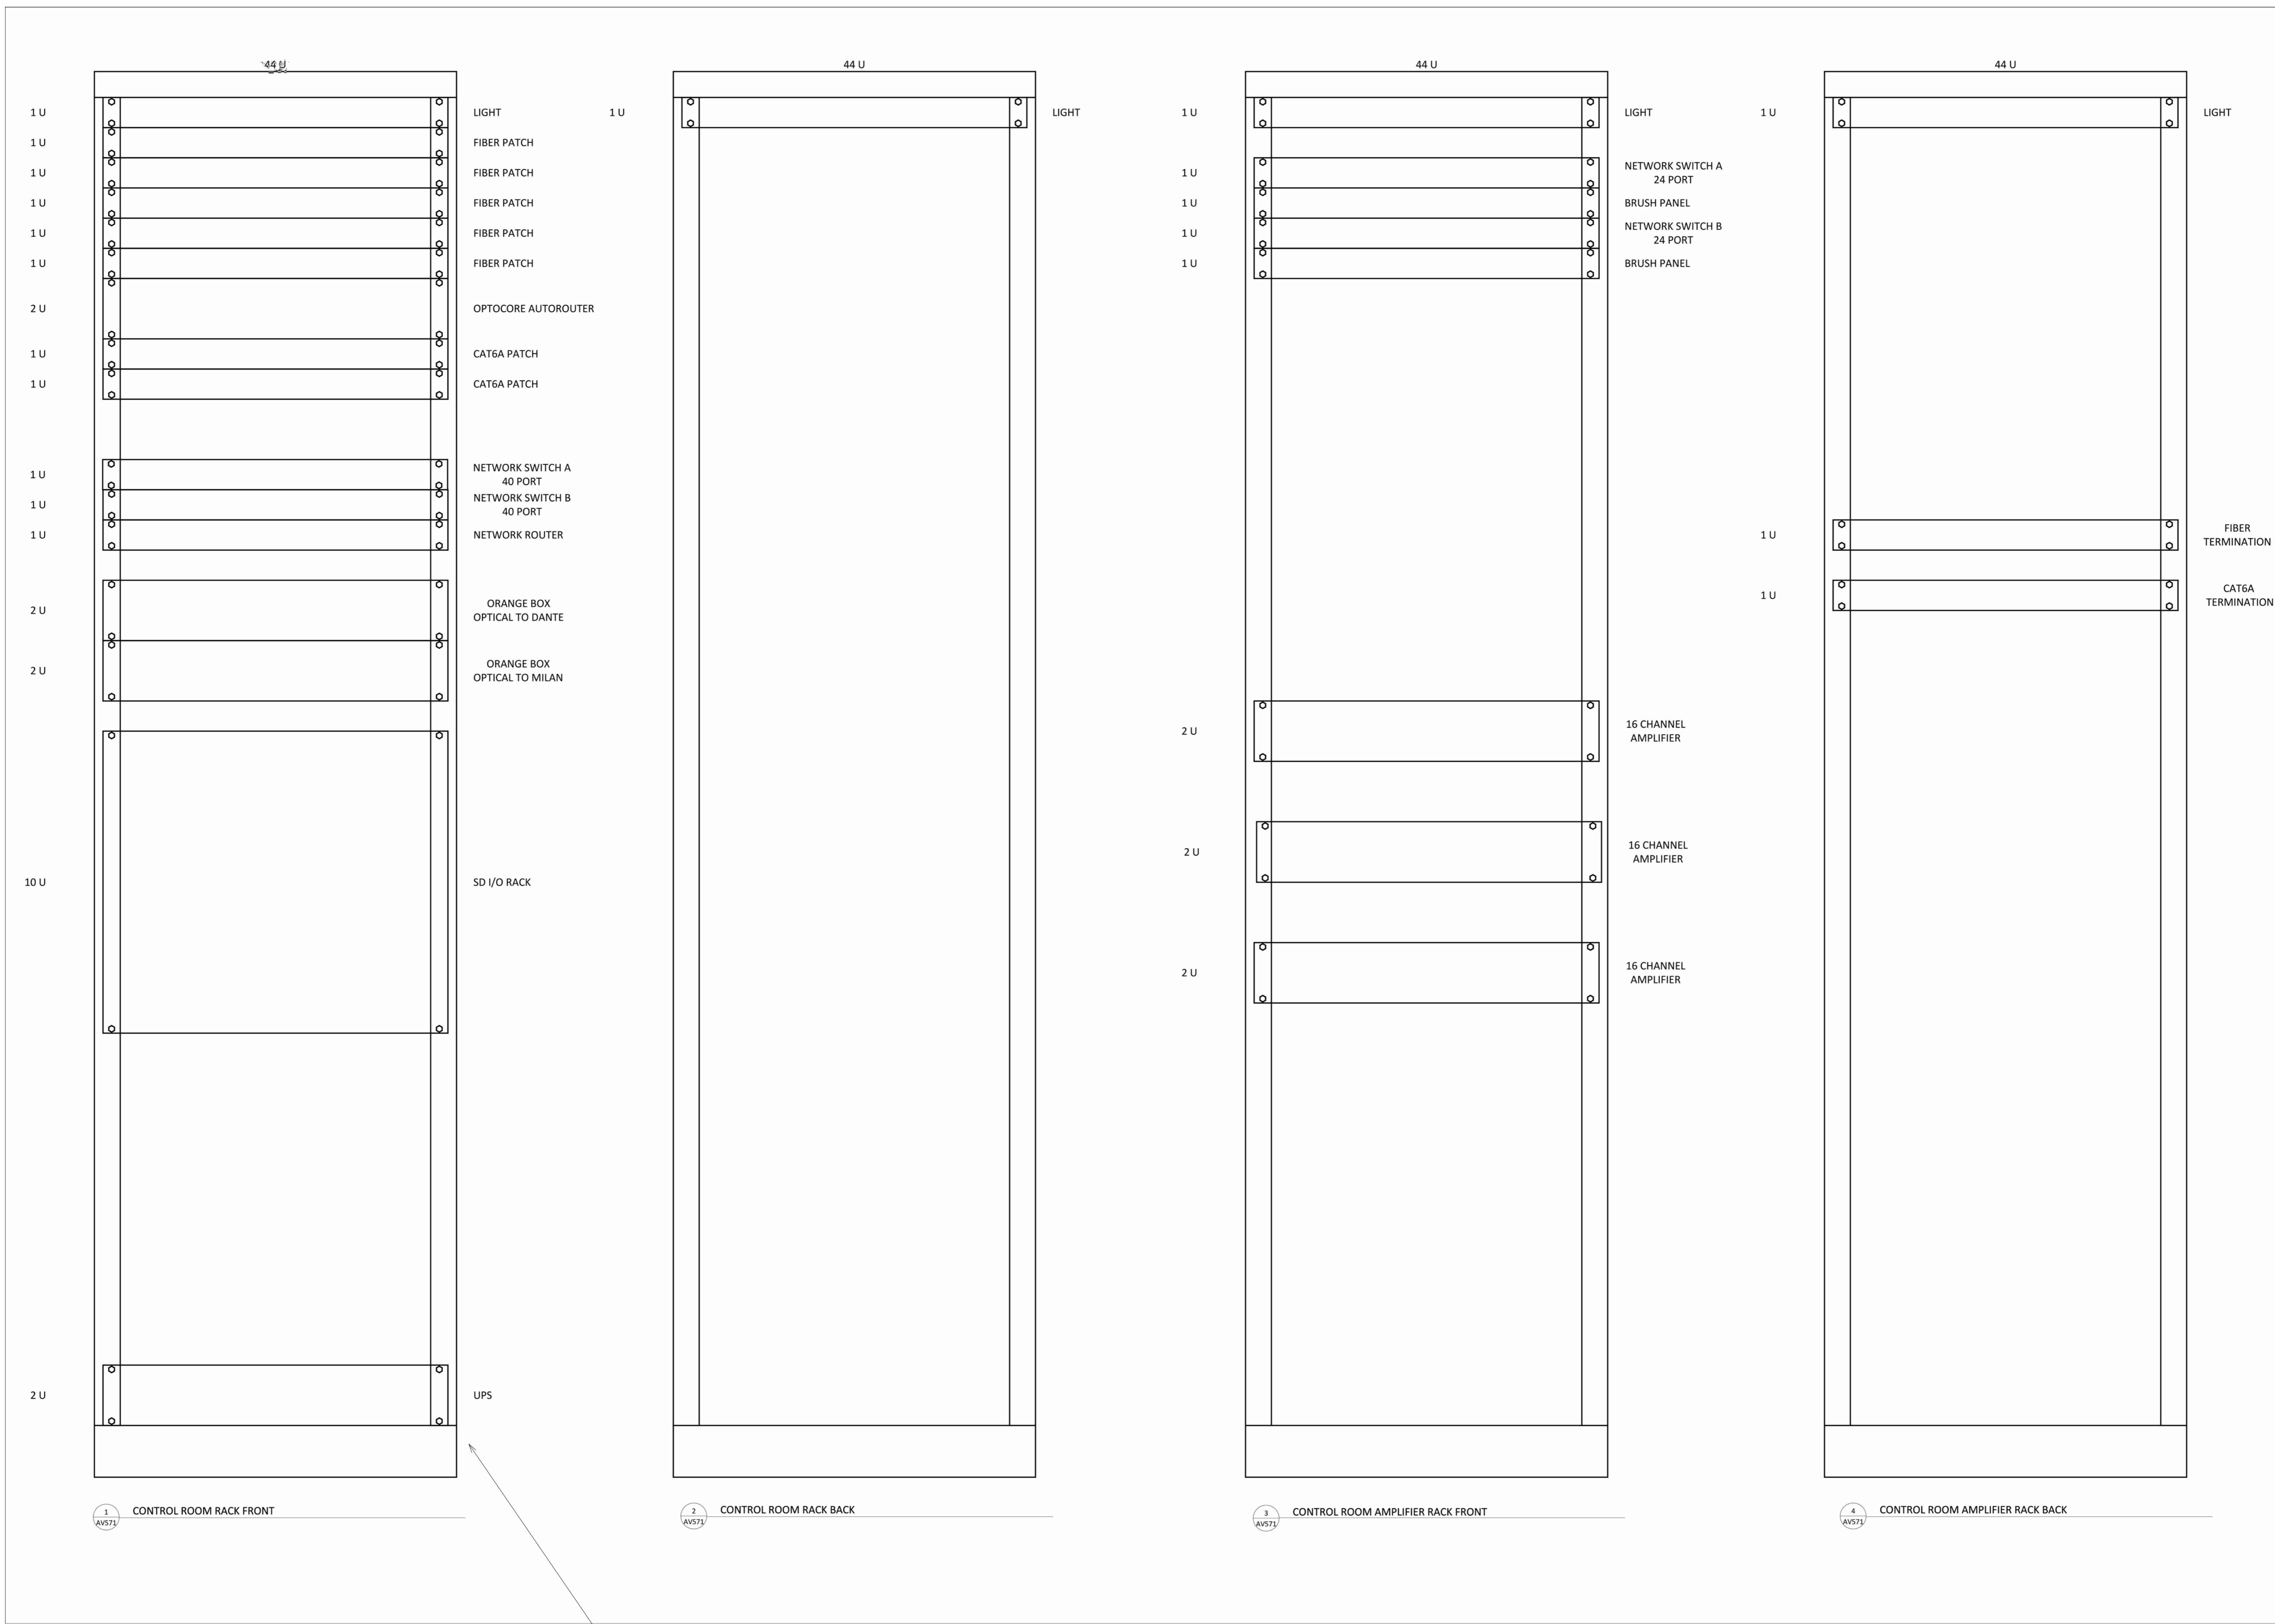
REVISIONS:

No	Description	Date

SEAL:

ISSUE DATE:
1.24.2024

SHEET NUMBER:
AV571
AV RACK ELEVATIONS
- CHAPMAN 1



COORDINATE INTEGRATION WITH EXISTING EQUIPMENT. SOME EQUIPMENT MIGHT NEED TO BE INSTALLED IN EXISTING RACKS OR VICE VERSA.

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TULSA
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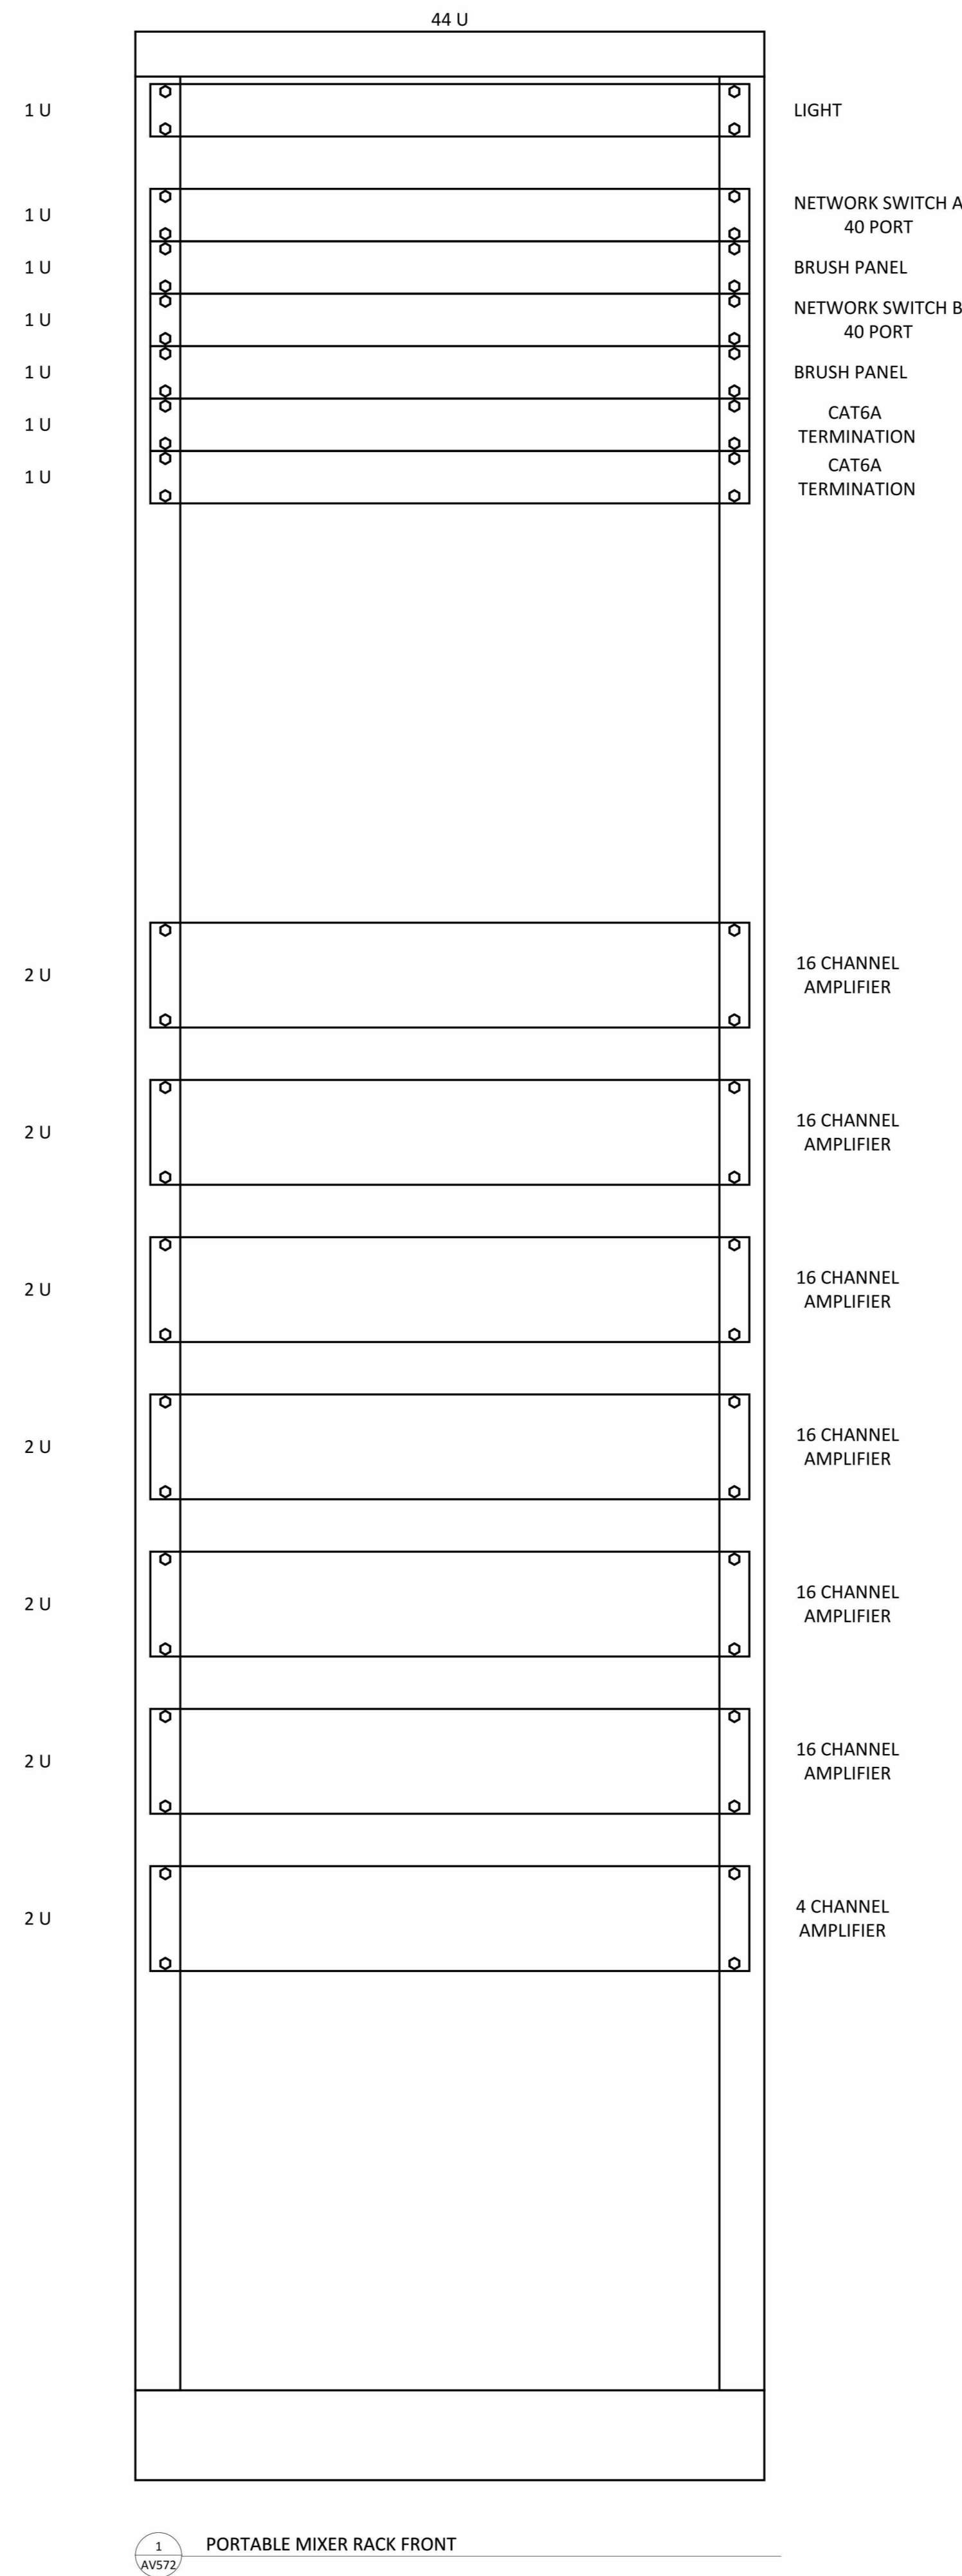
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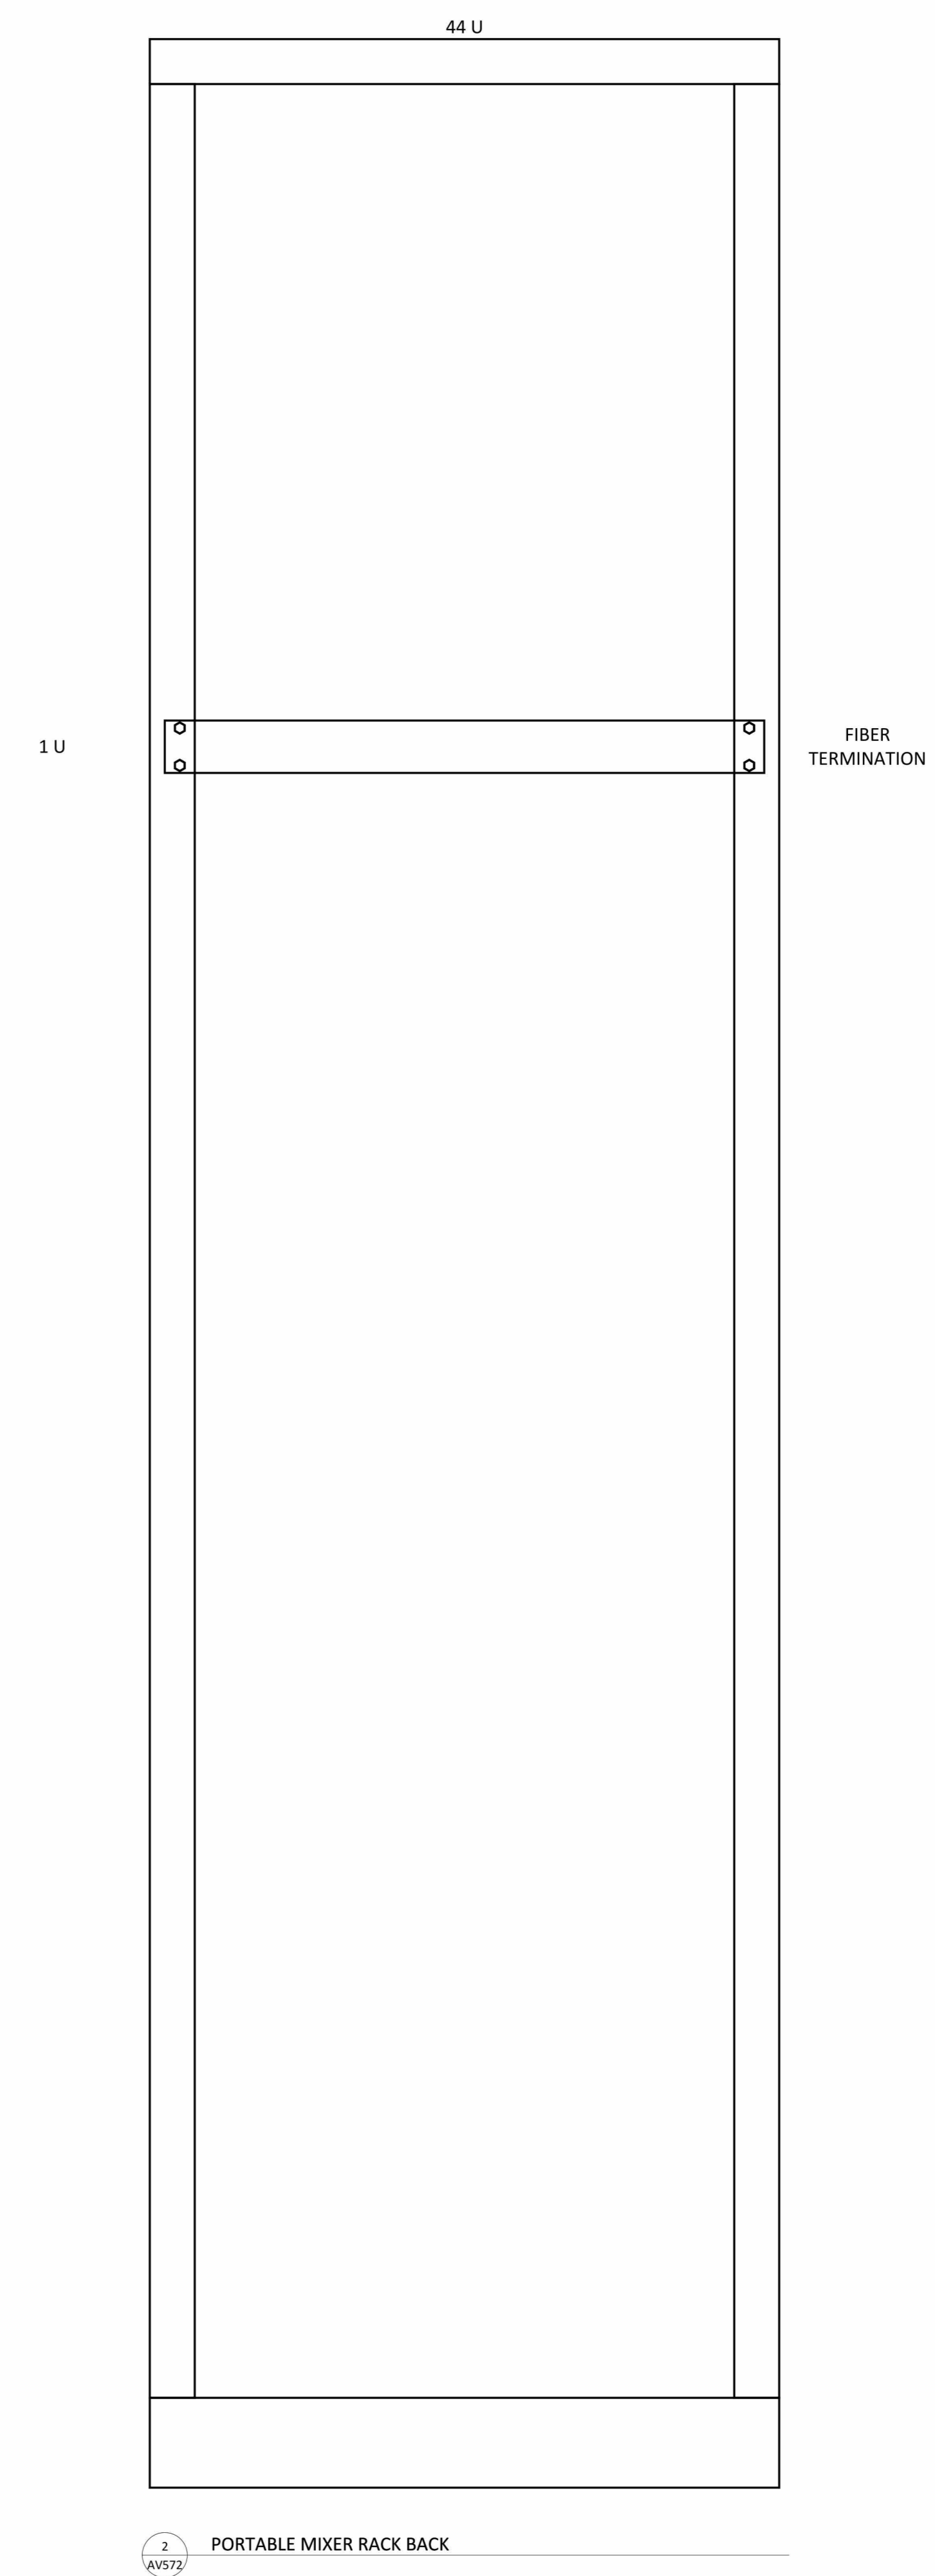
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ISSUE DATE:
1.24.2024


SHEET NUMBER:
AV572
 AV RACK ELEVATIONS
 - CHAPMAN 2




1 AV572 PORTABLE MIXER RACK FRONT




2 AV572 PORTABLE MIXER RACK BACK

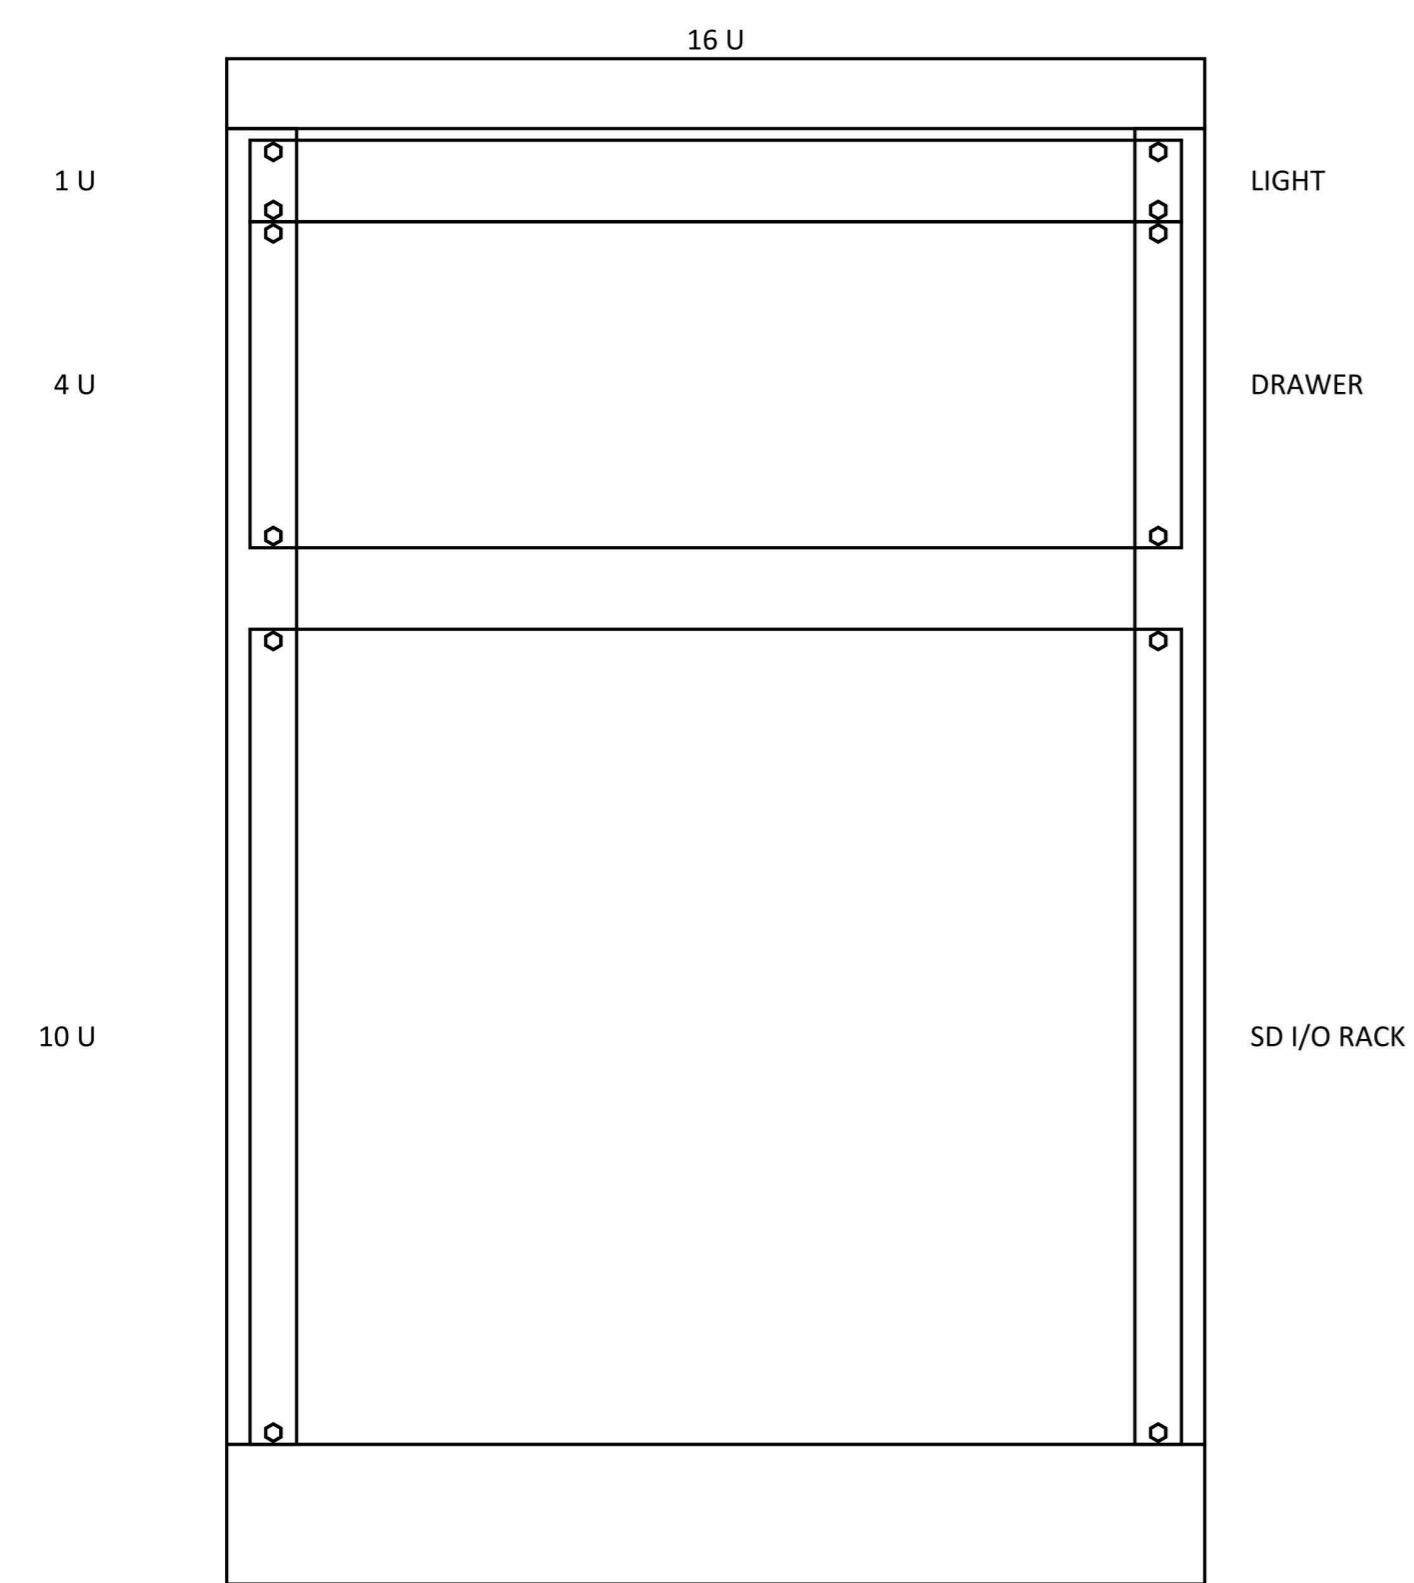


1 STAGE RACK 1 FRONT
AV573

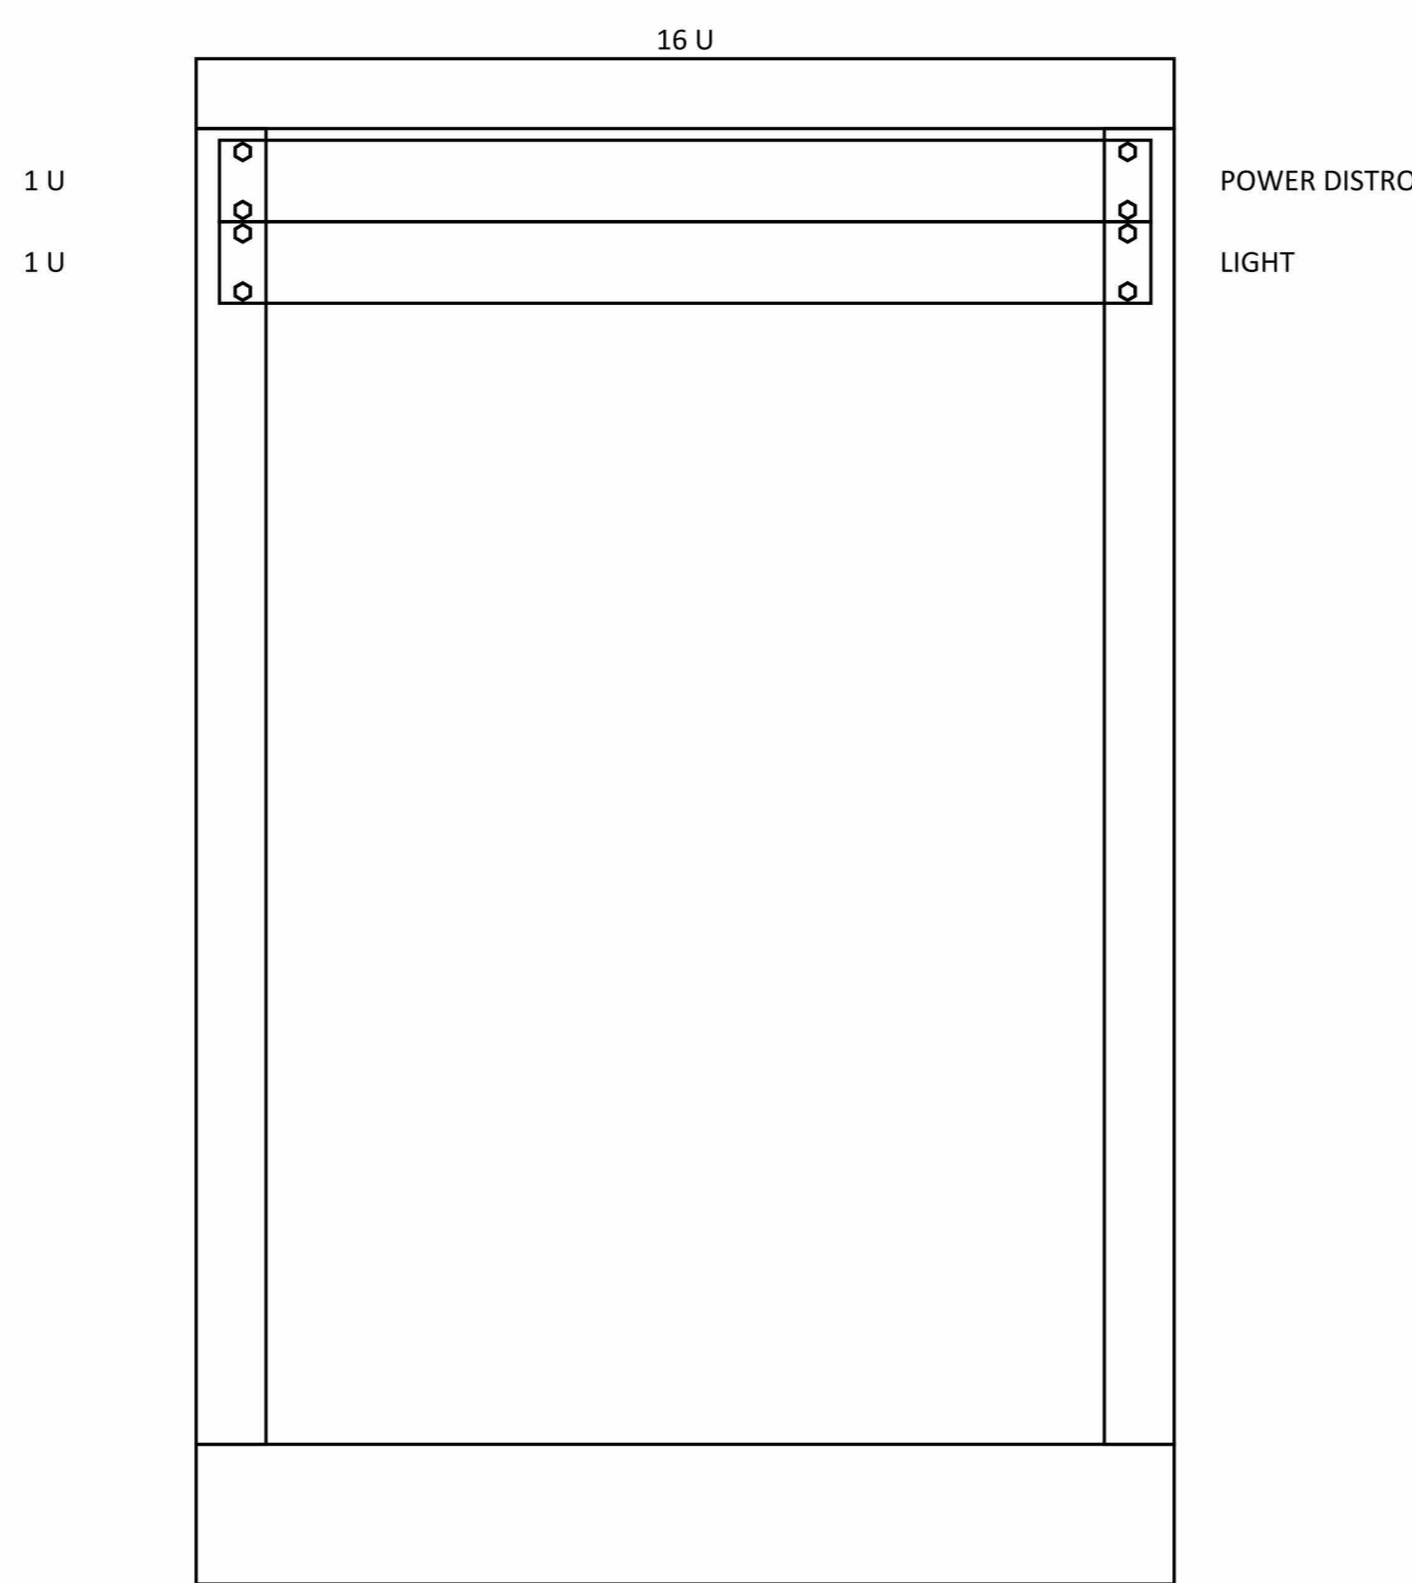


2 STAGE RACK 1 BACK
AV573

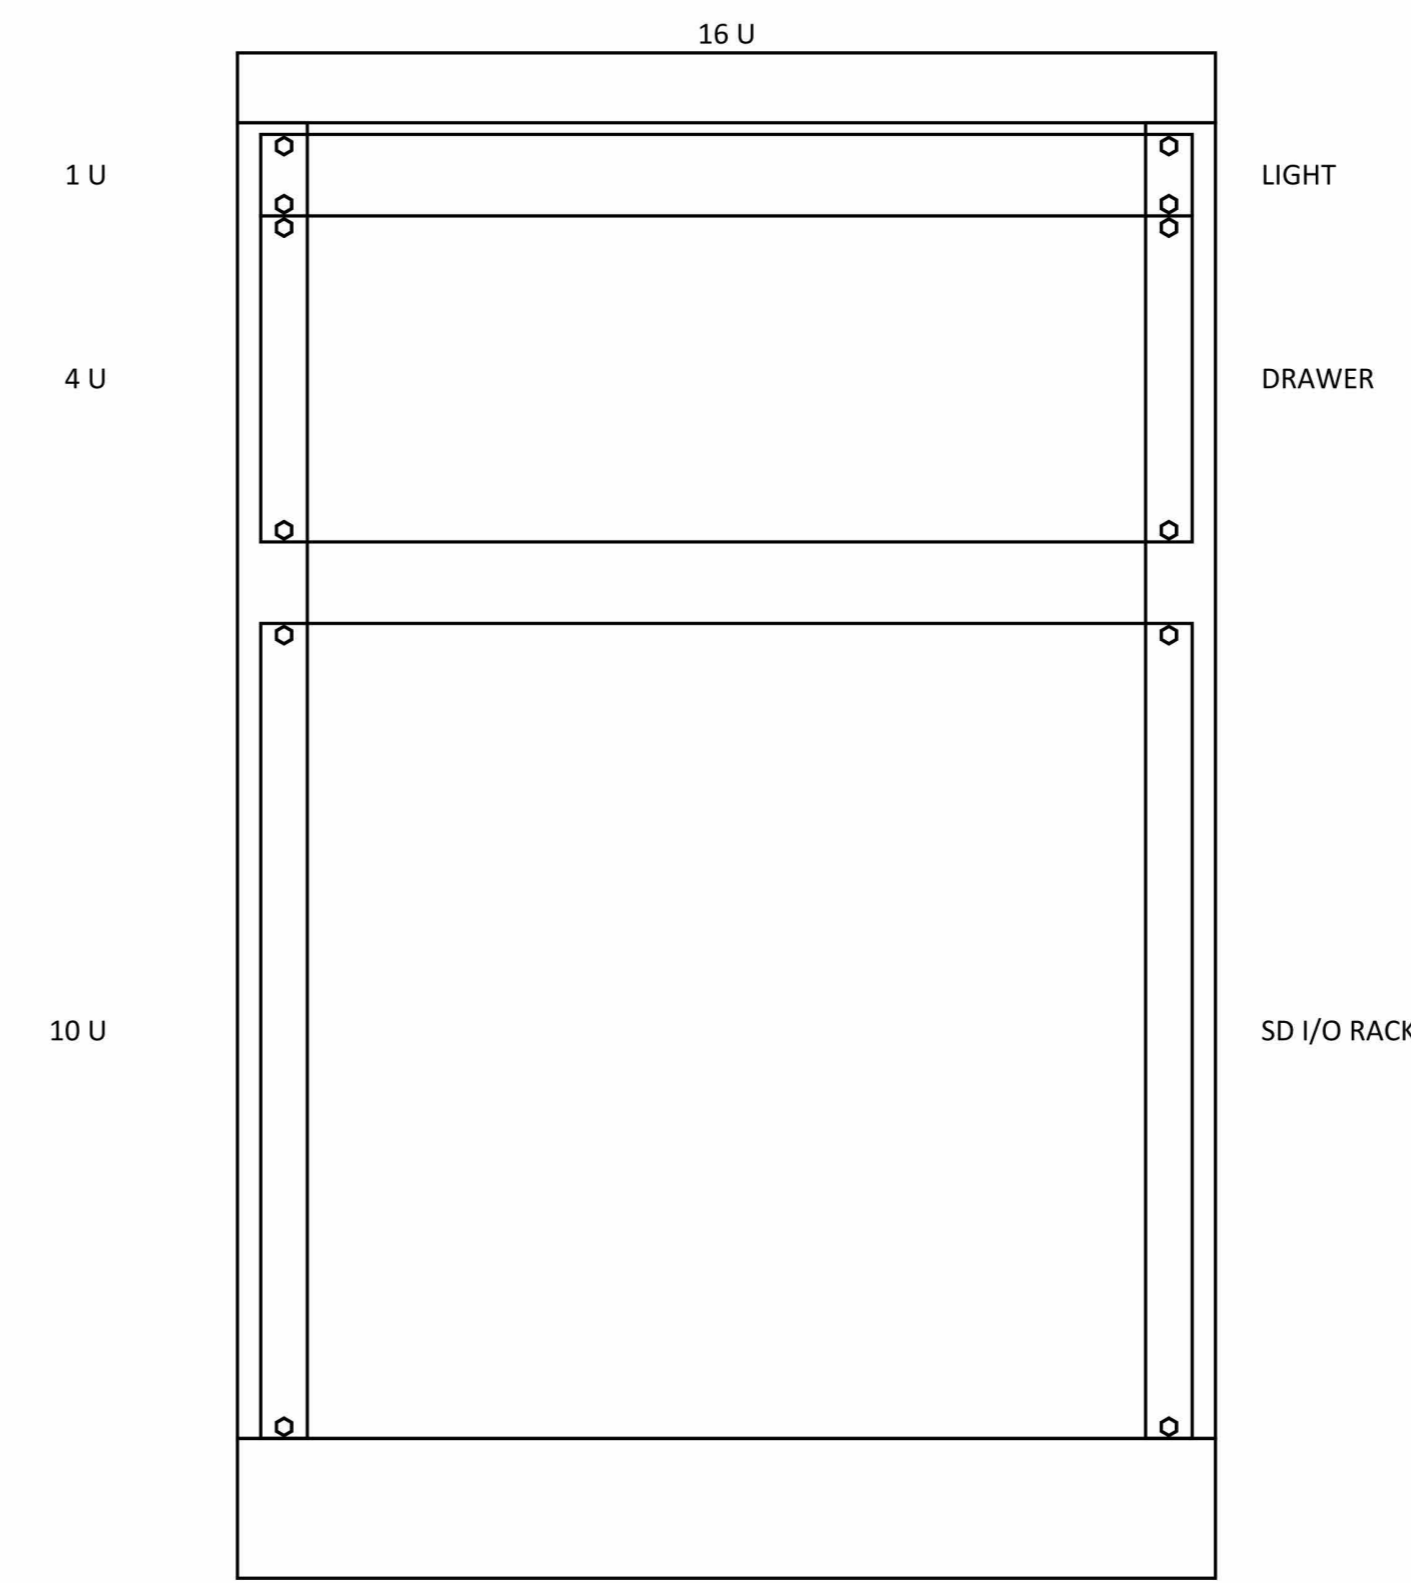


3 STAGE RACK 2 FRONT
AV573

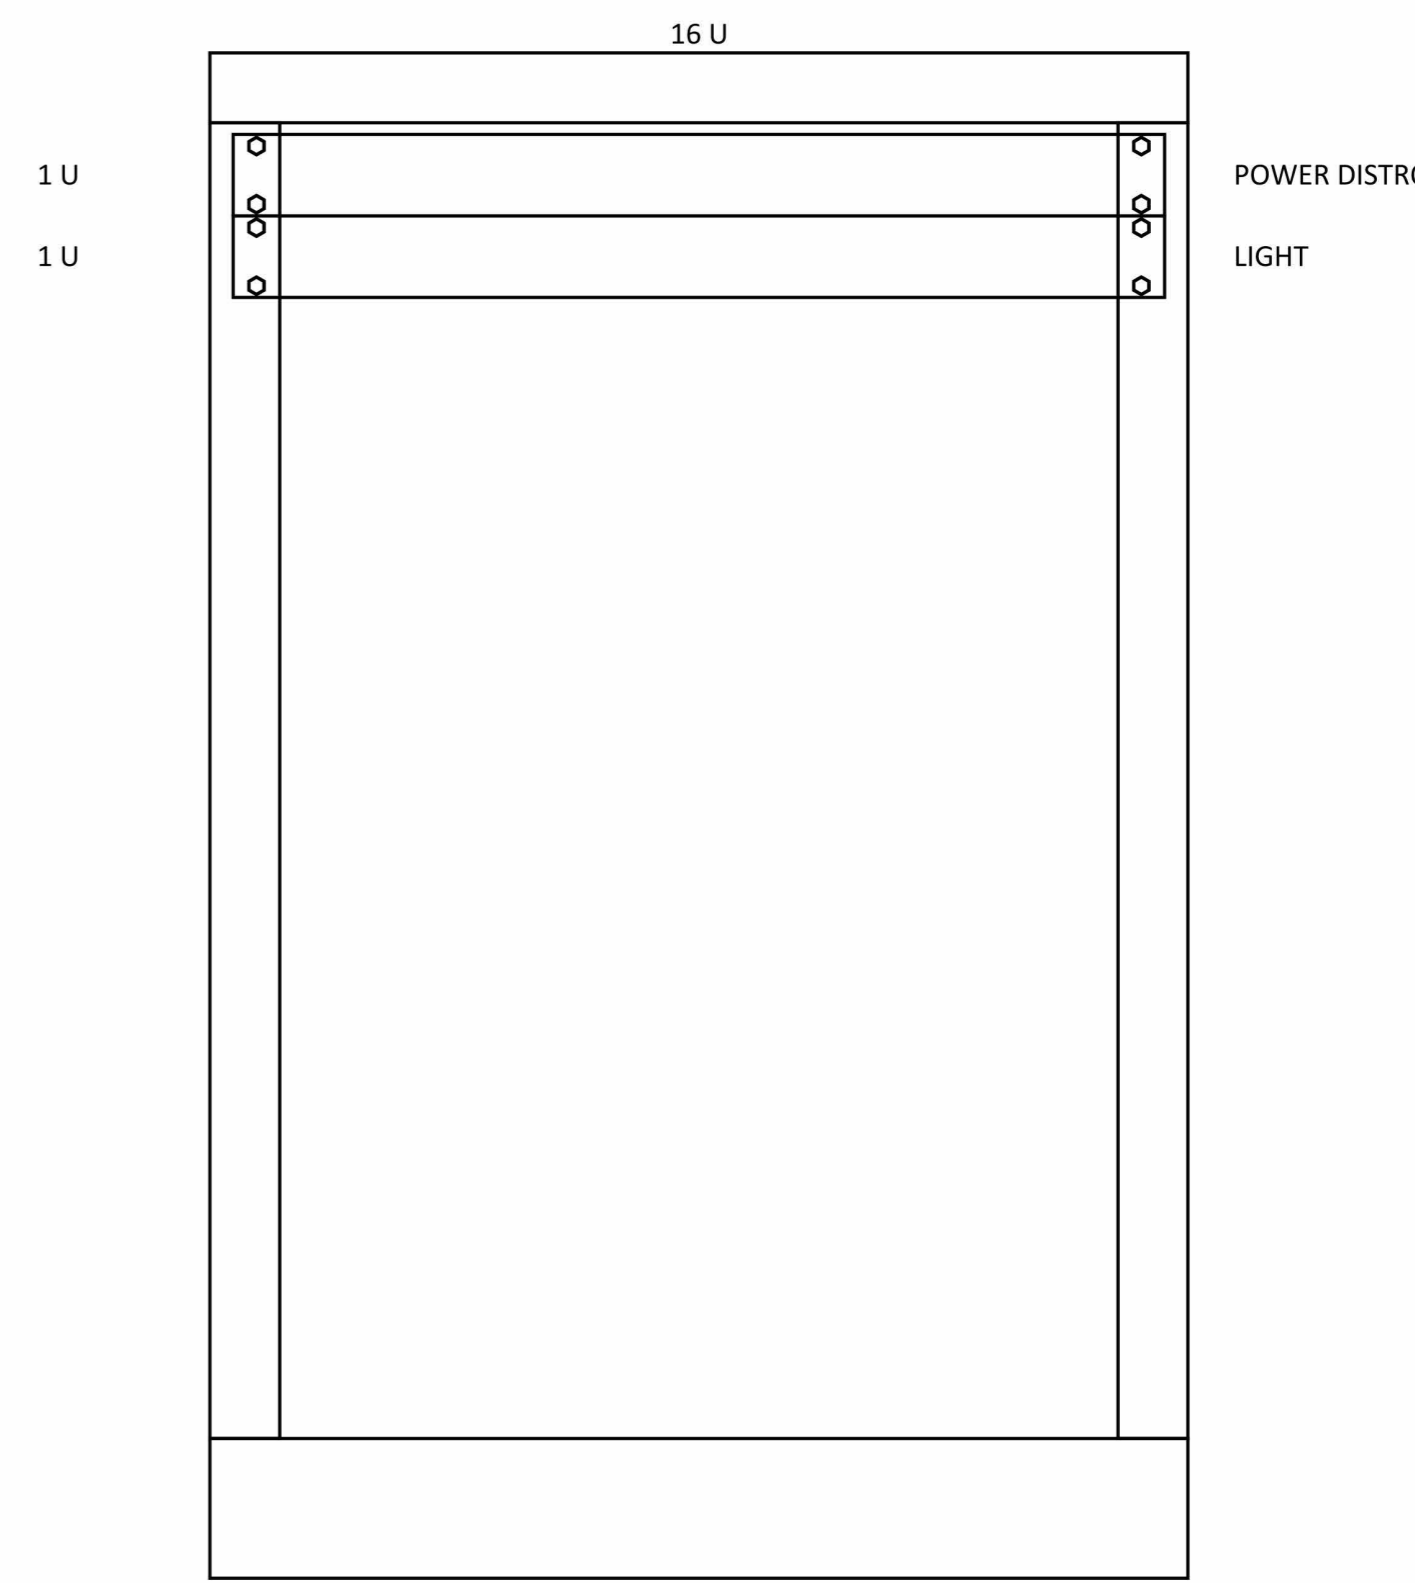

4 STAGE RACK 2 BACK
AV573

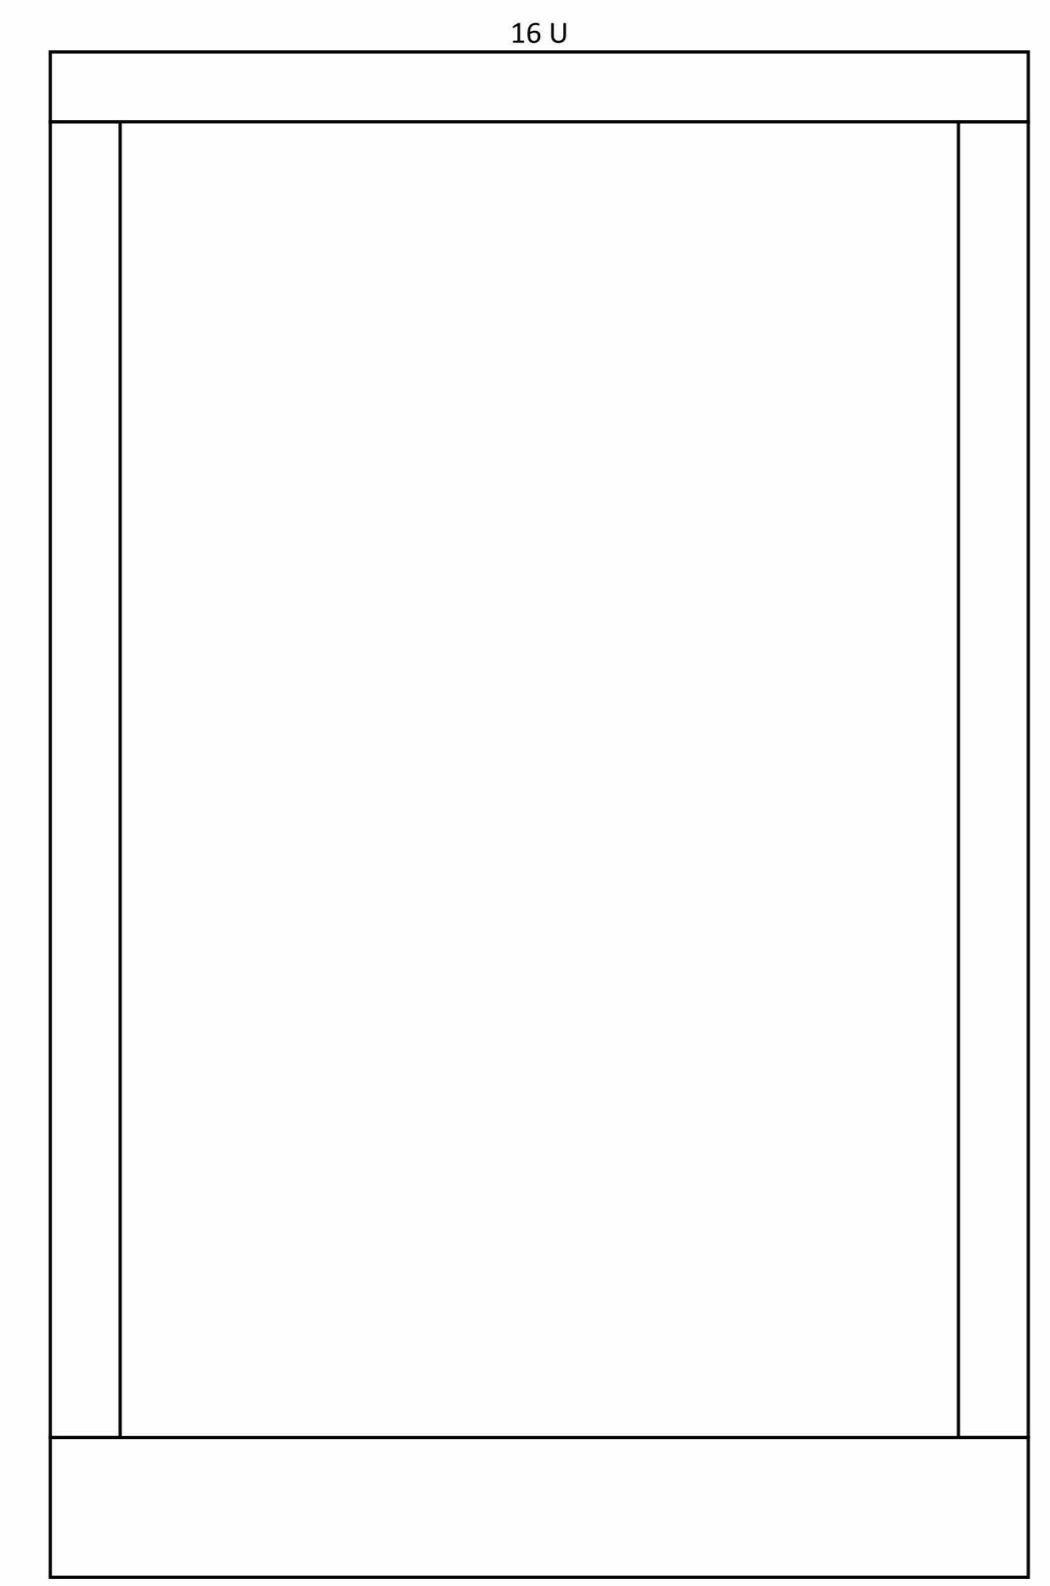

5 EXISTING WIRELESS RACK FRONT
AV573

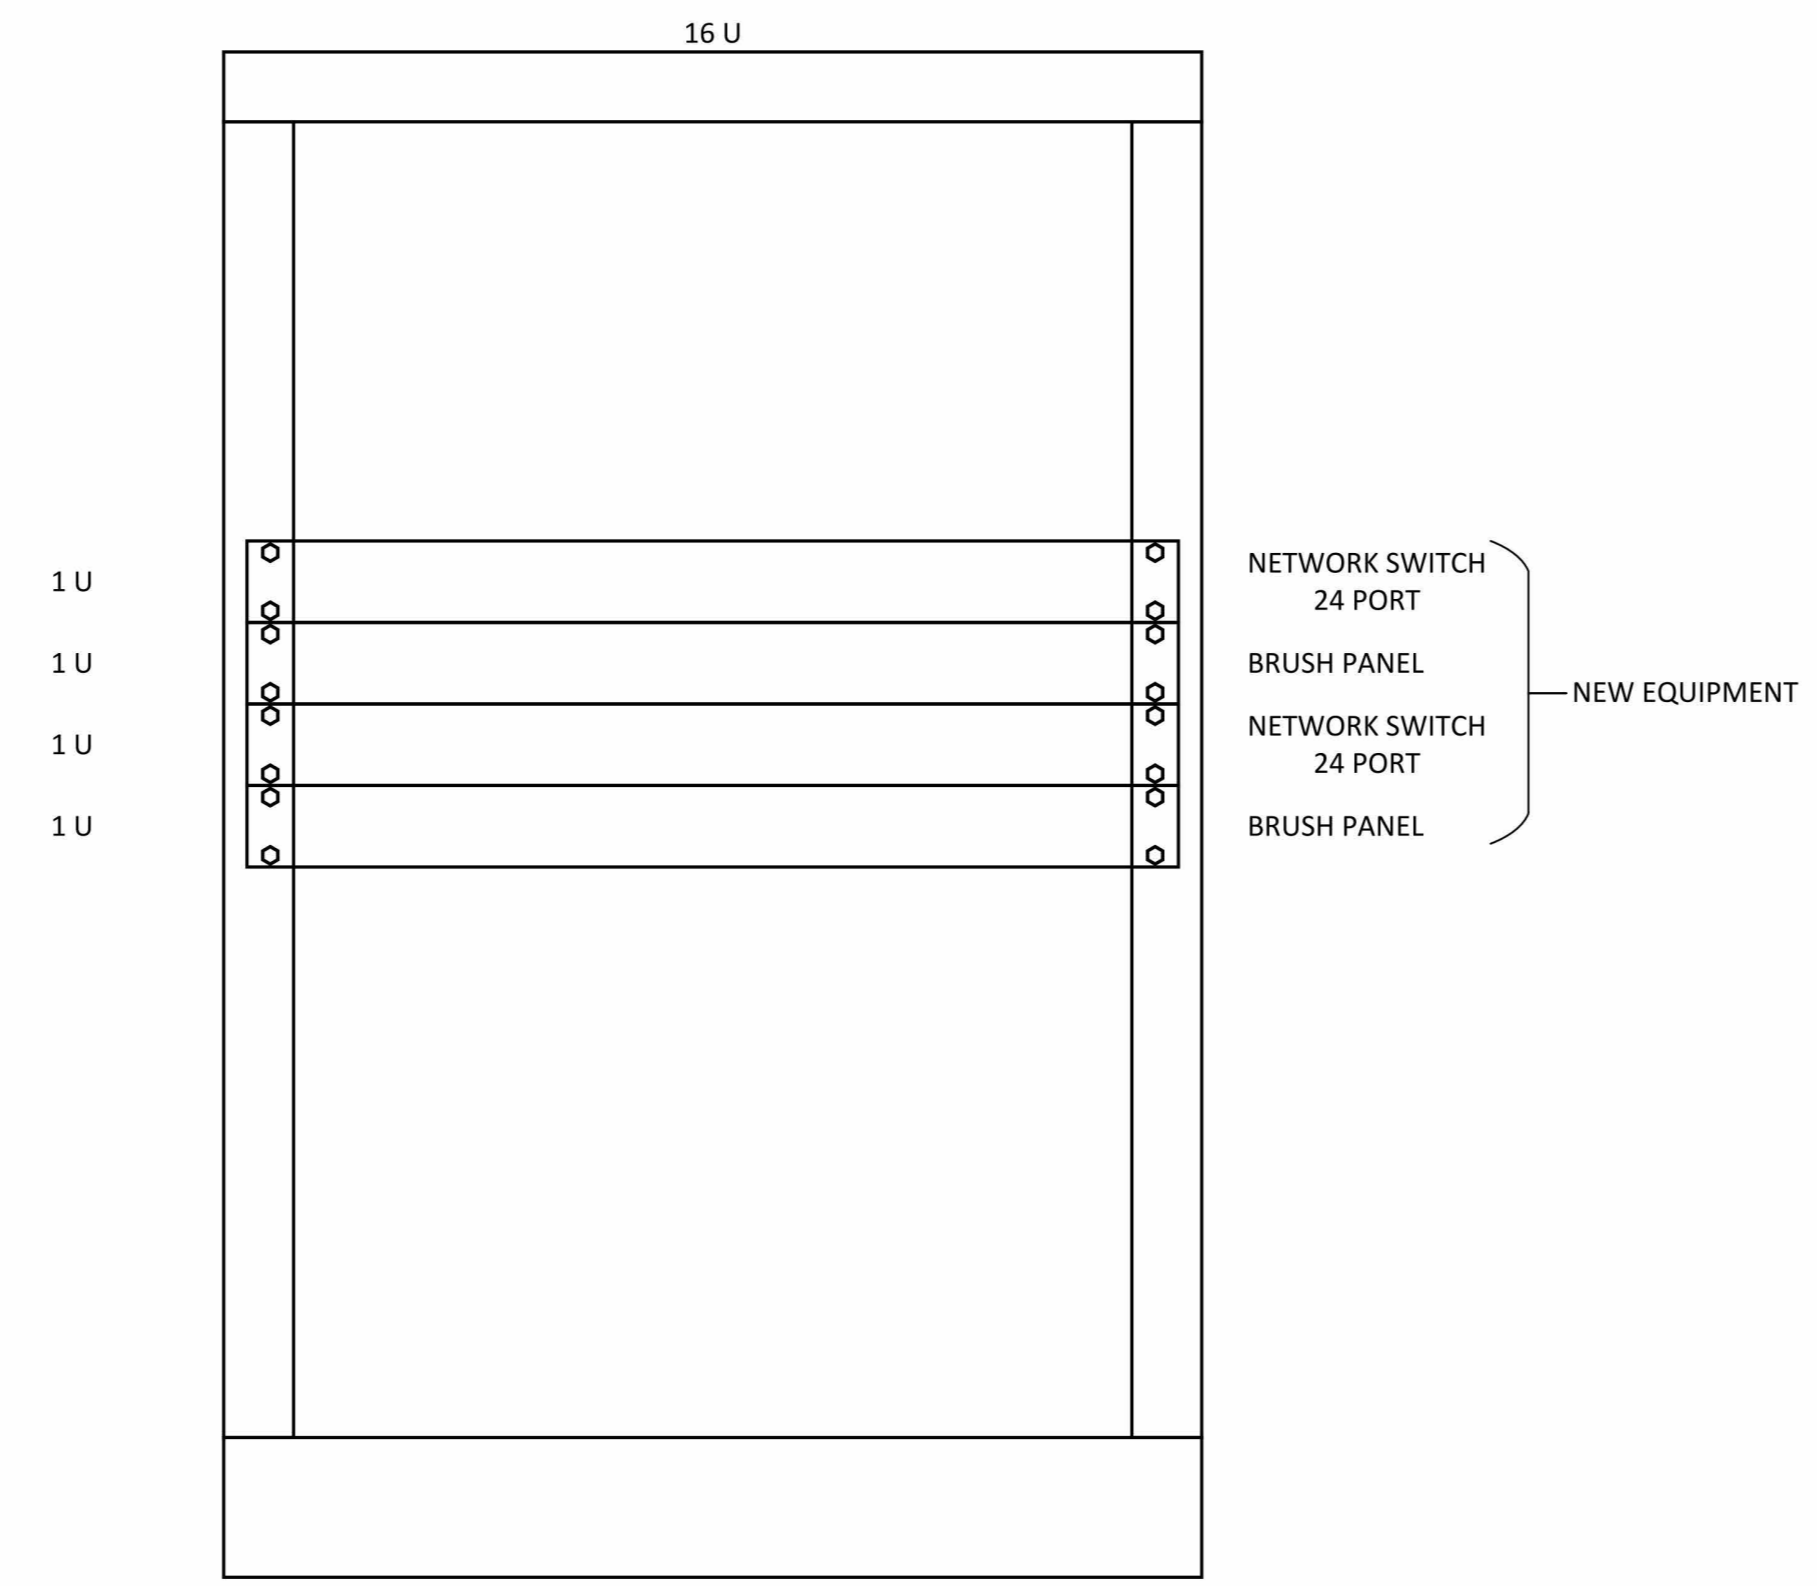

6 EXISTING WIRELESS RACK BACK
AV573



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PROJECT:
TULSA
PERFORMING
ARTS CENTER

PROJECT NUMBER:
202331.00

CONSULTANT:



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No	Description	Date

SEAL:

ISSUE DATE:
1.24.2024

SHEET NUMBER:
AV573
AV RACK ELEVATIONS
- CHAPMAN 3

PROJECT:
TULSA
PERFORMING
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PROJECT NUMBER:
202331.00

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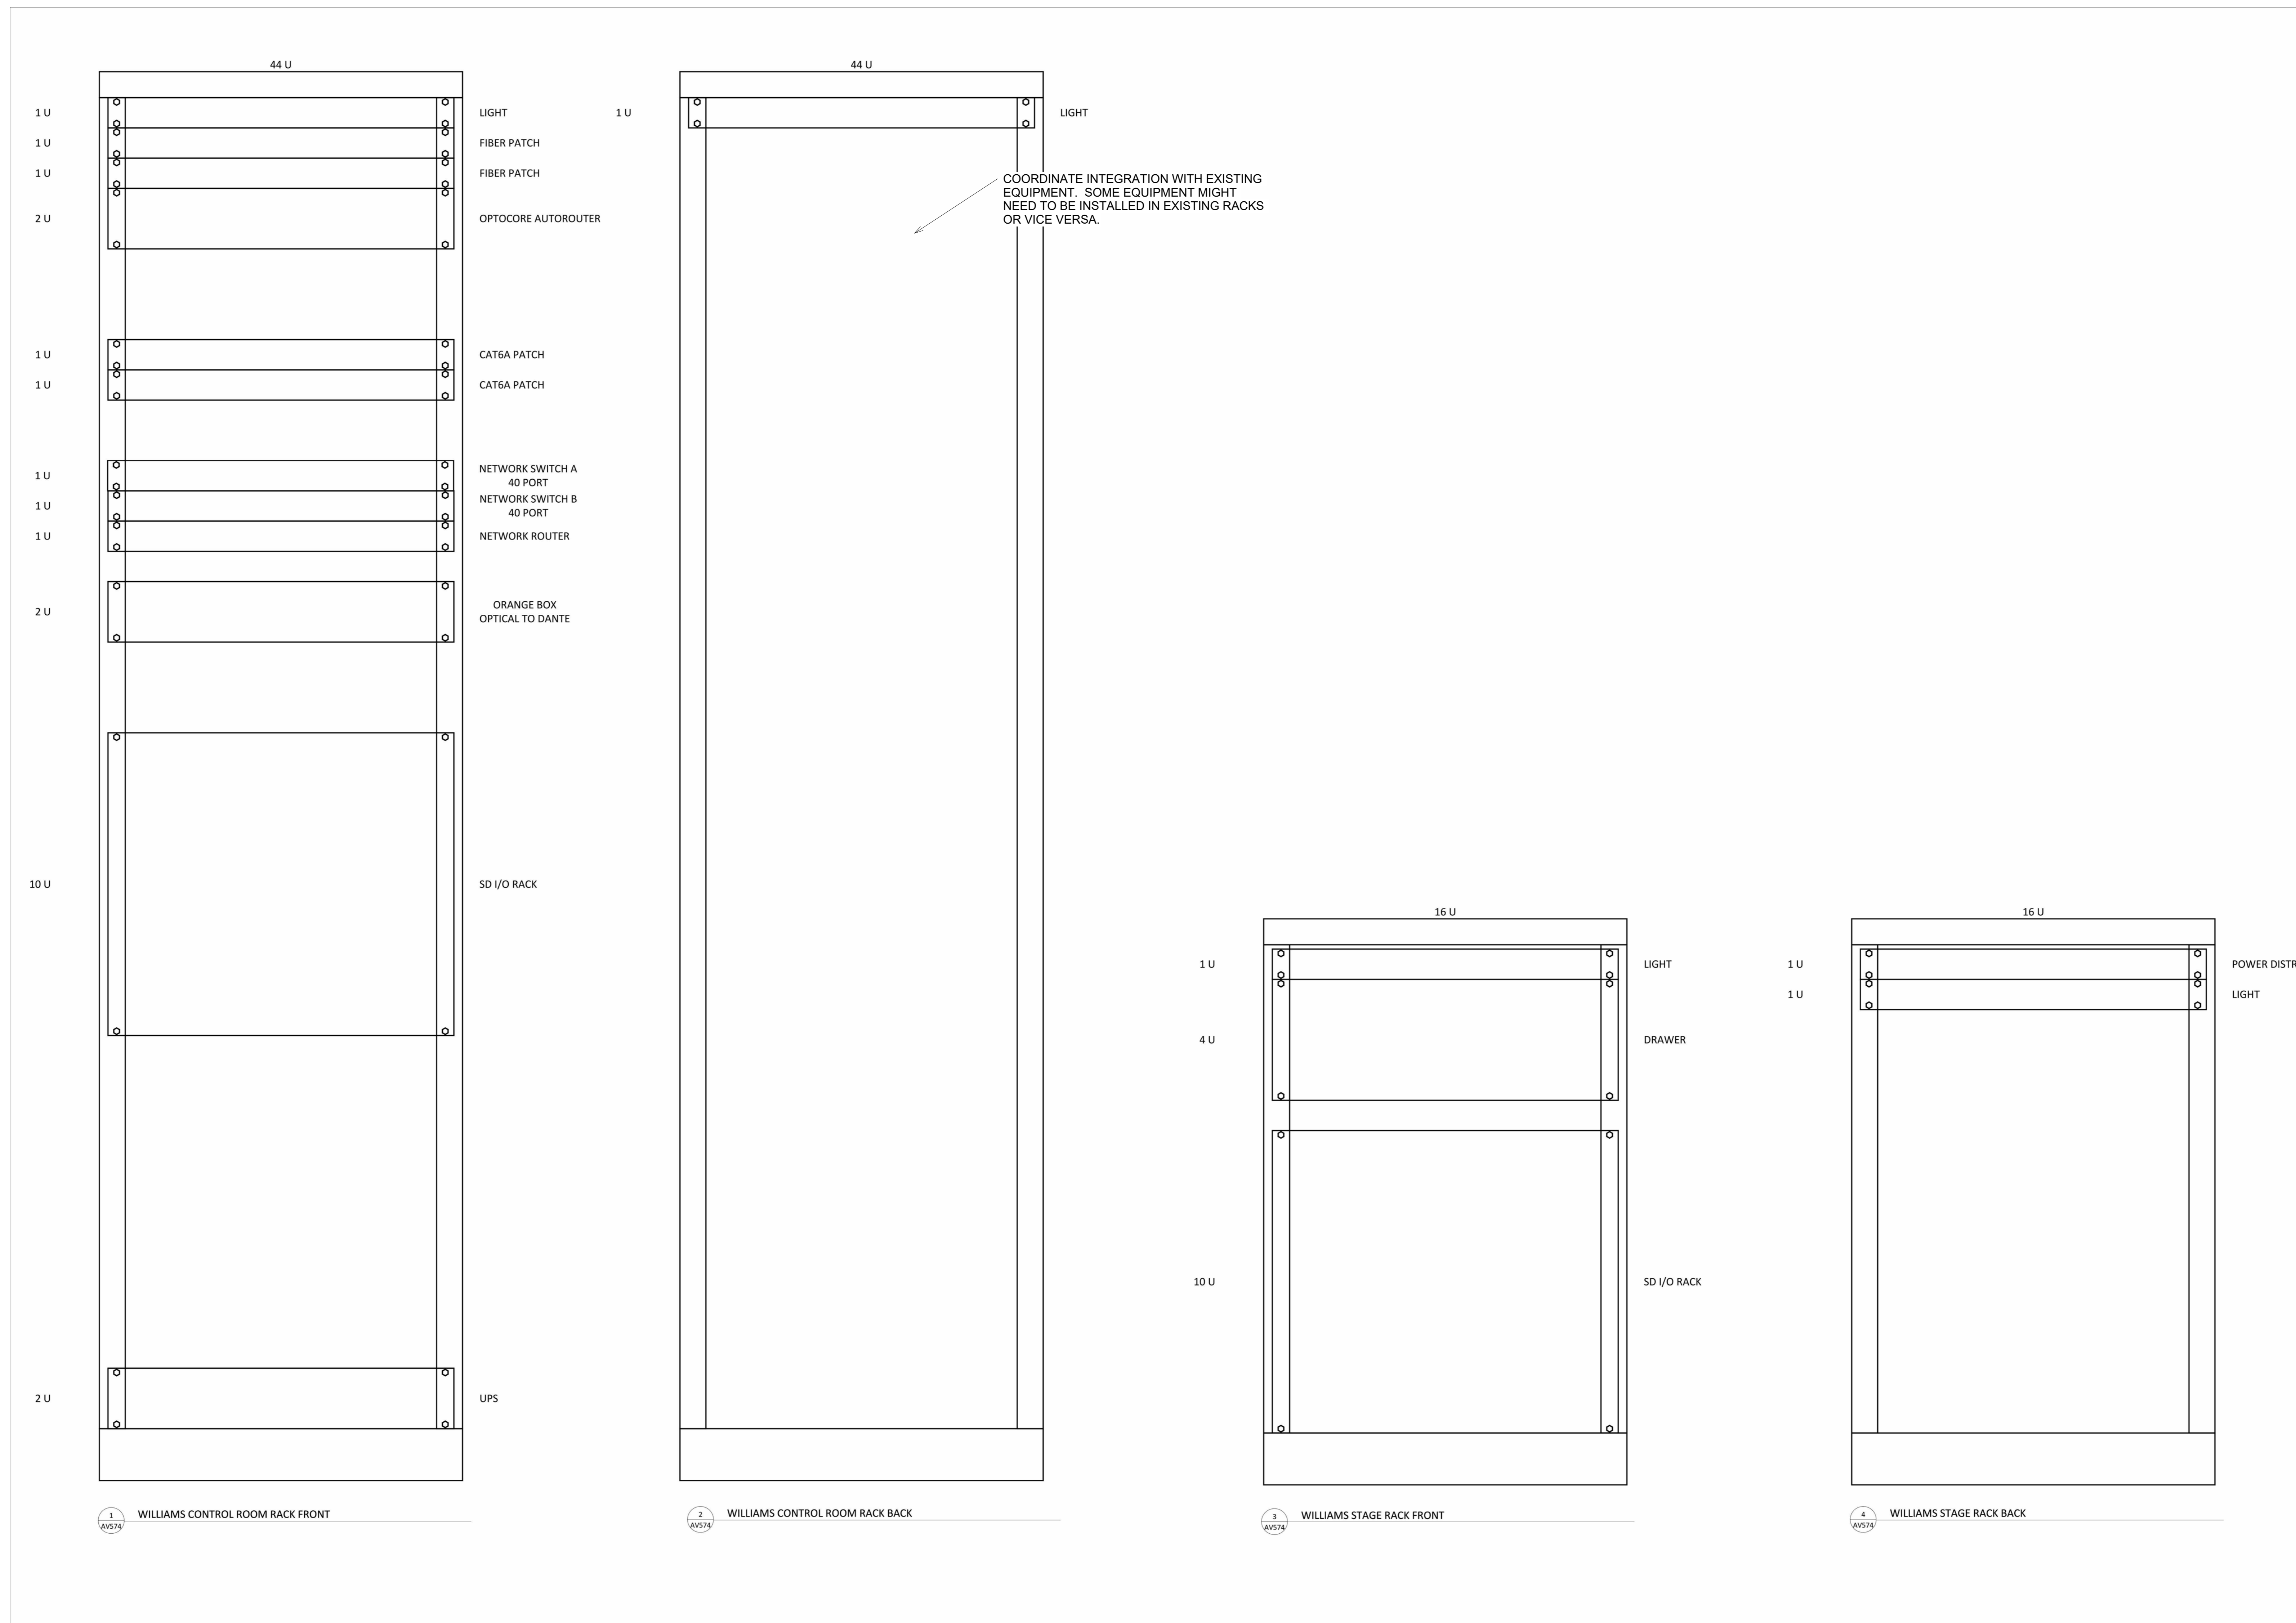
REVISIONS:

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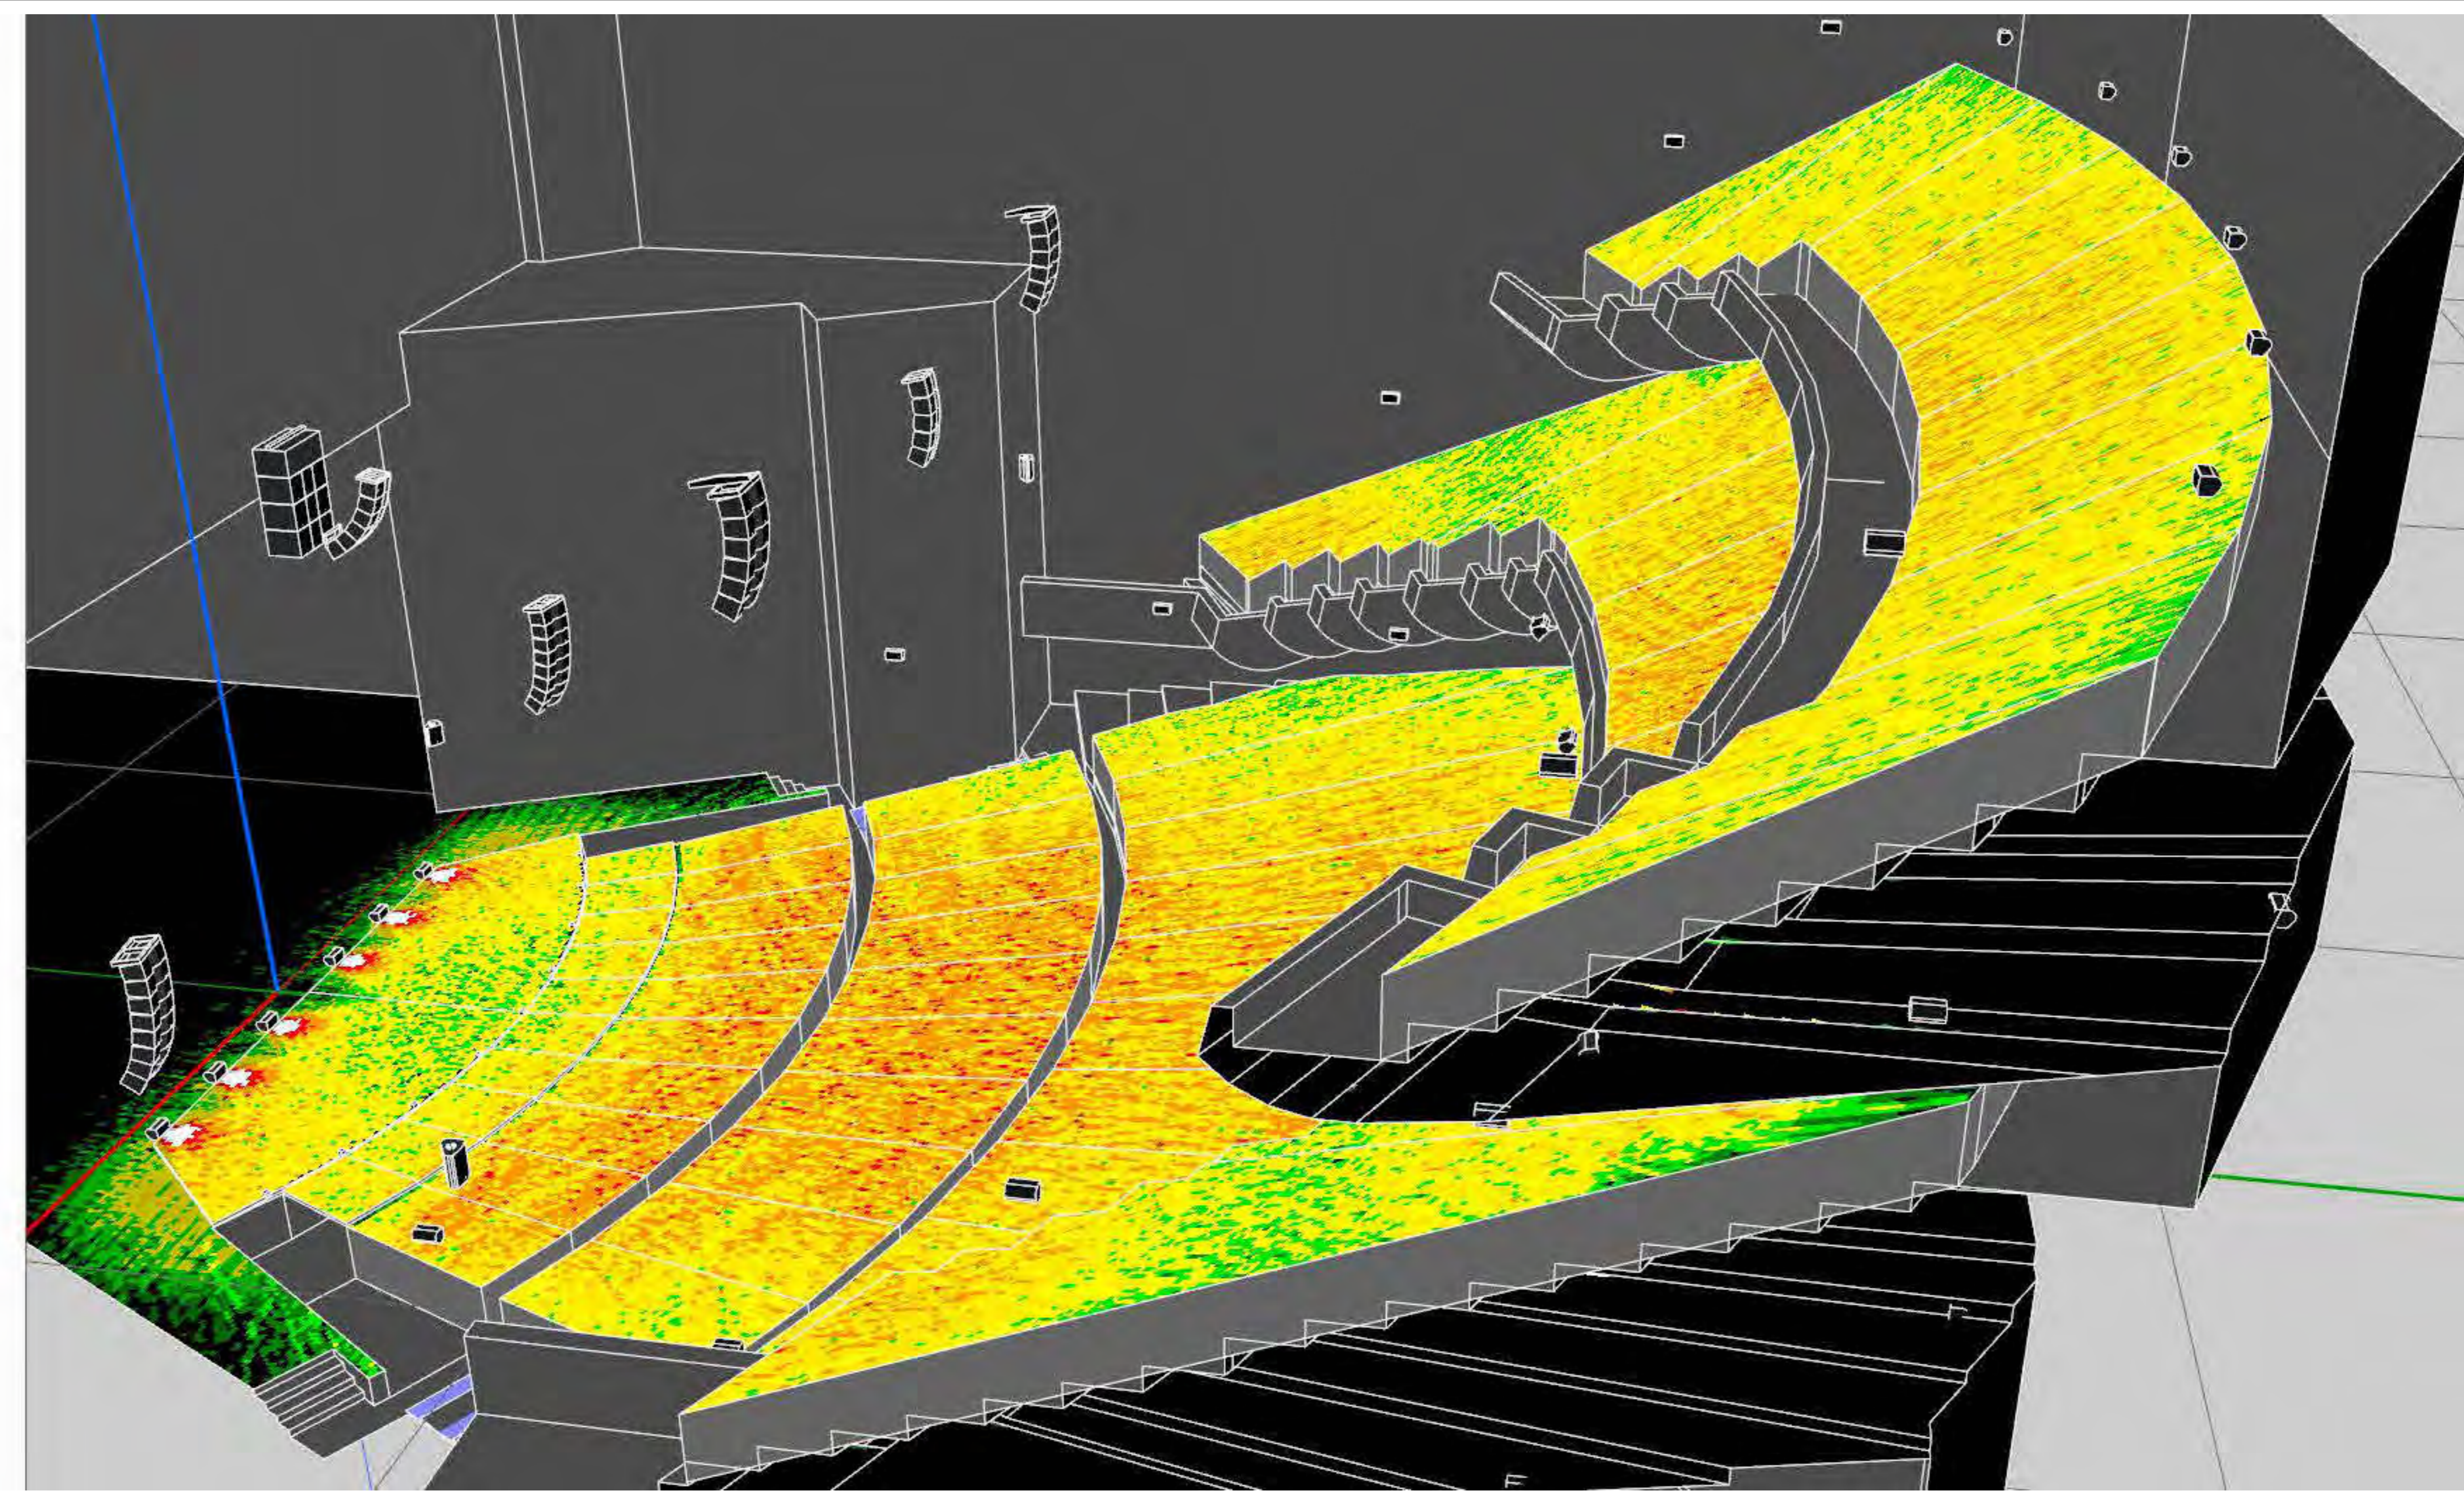
SEAL:

ISSUE DATE:
1.24.2024


SHEET NUMBER:
AV574
AV RACK ELEVATIONS
- WILLIAMS



Length: ft.in
 Weight: lb
 Delay: ms
 Scale: 1/1
 Air absorp.: ON
 1000 - 10000 Hz
 dB SPL scale
 > 110
 108
 106
 104
 102
 100
 < 98



Length: ft.in
 Weight: lb
 Delay: ms
 Scale: 1/1
 Air absorp.: ON
 1000 - 10000 Hz
 dB SPL scale
 > 110
 108
 106
 104
 102
 100
 < 98

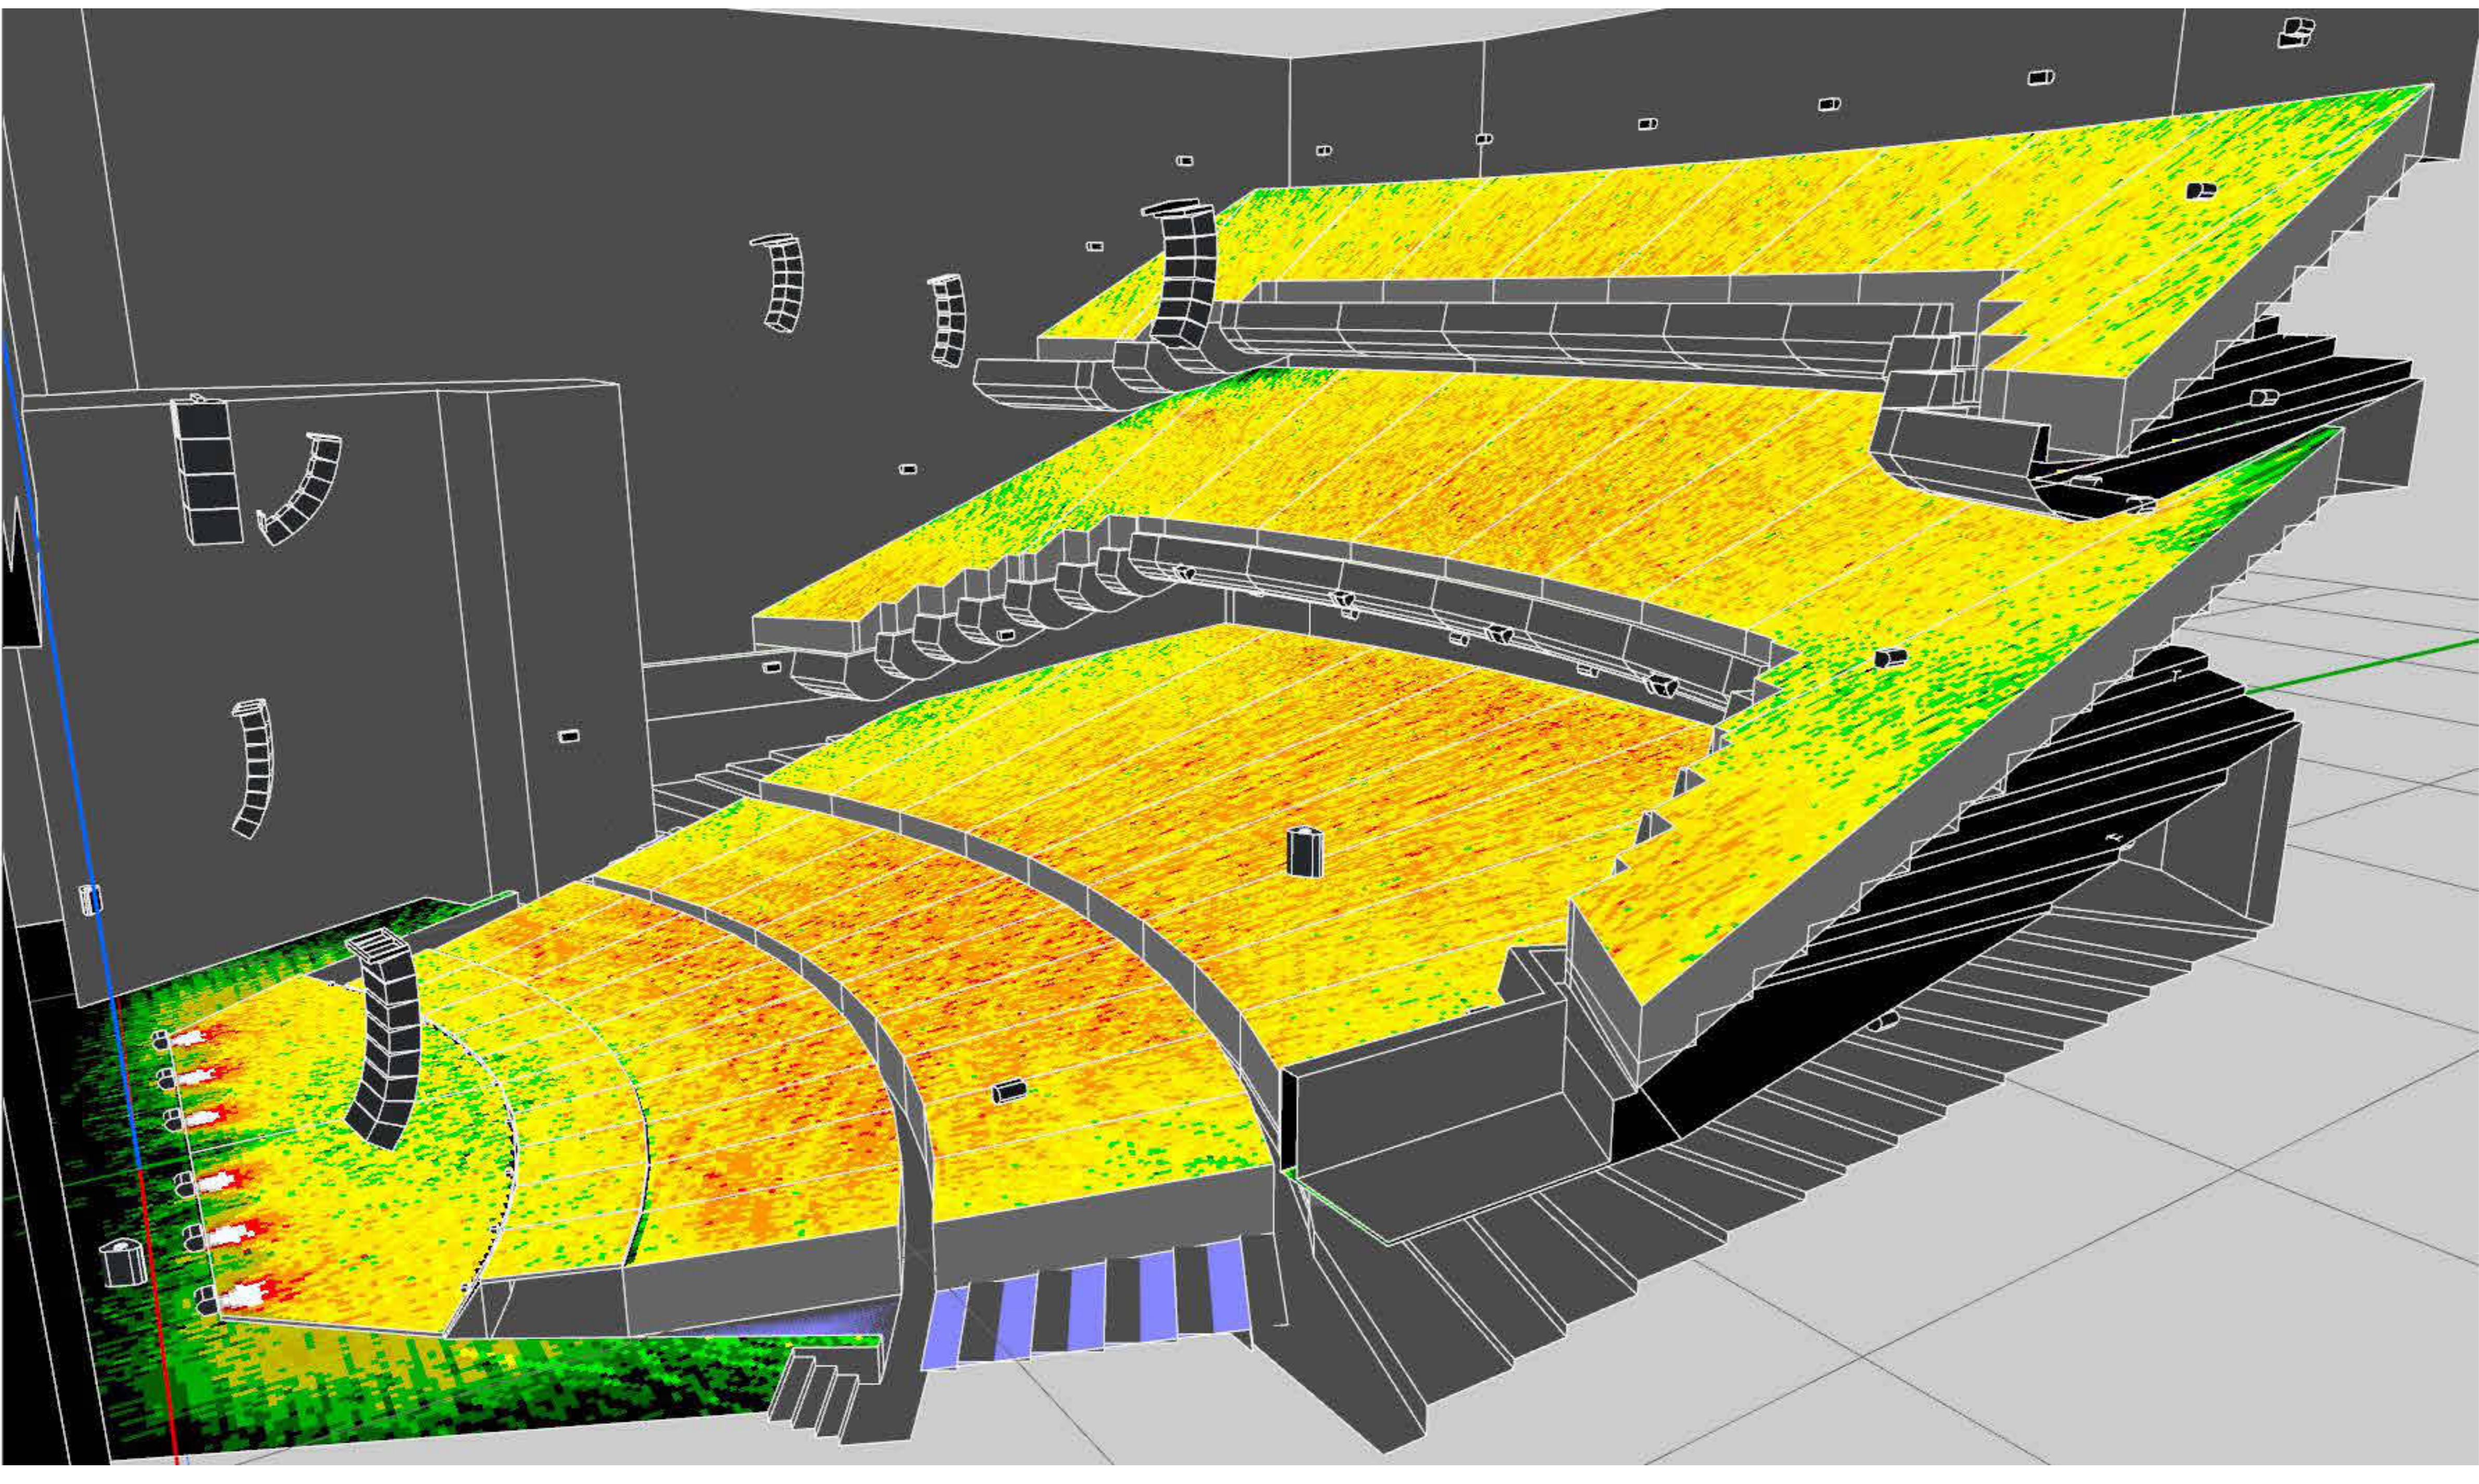

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PROJECT:
TULSA
PERFORMING
ARTS CENTER

PROJECT NUMBER:
202331.00

CONSULTANT:

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REVISIONS:

No	Description	Date


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ISSUE DATE:
1.24.2024



SHEET NUMBER:
AV901
AV SPEAKER
PREDICTIONS



④ Mounting Three View
1" = 1'-0"

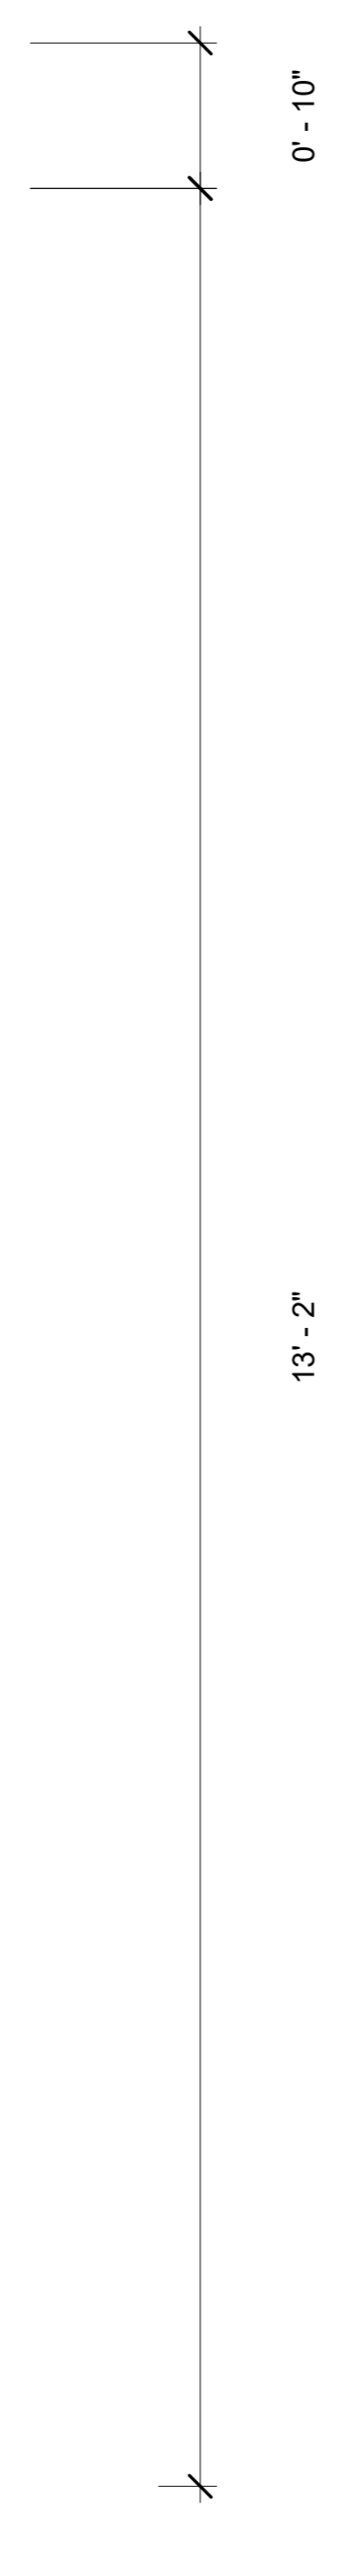


⑥ Wall Single Face
1/2" = 1'-0"

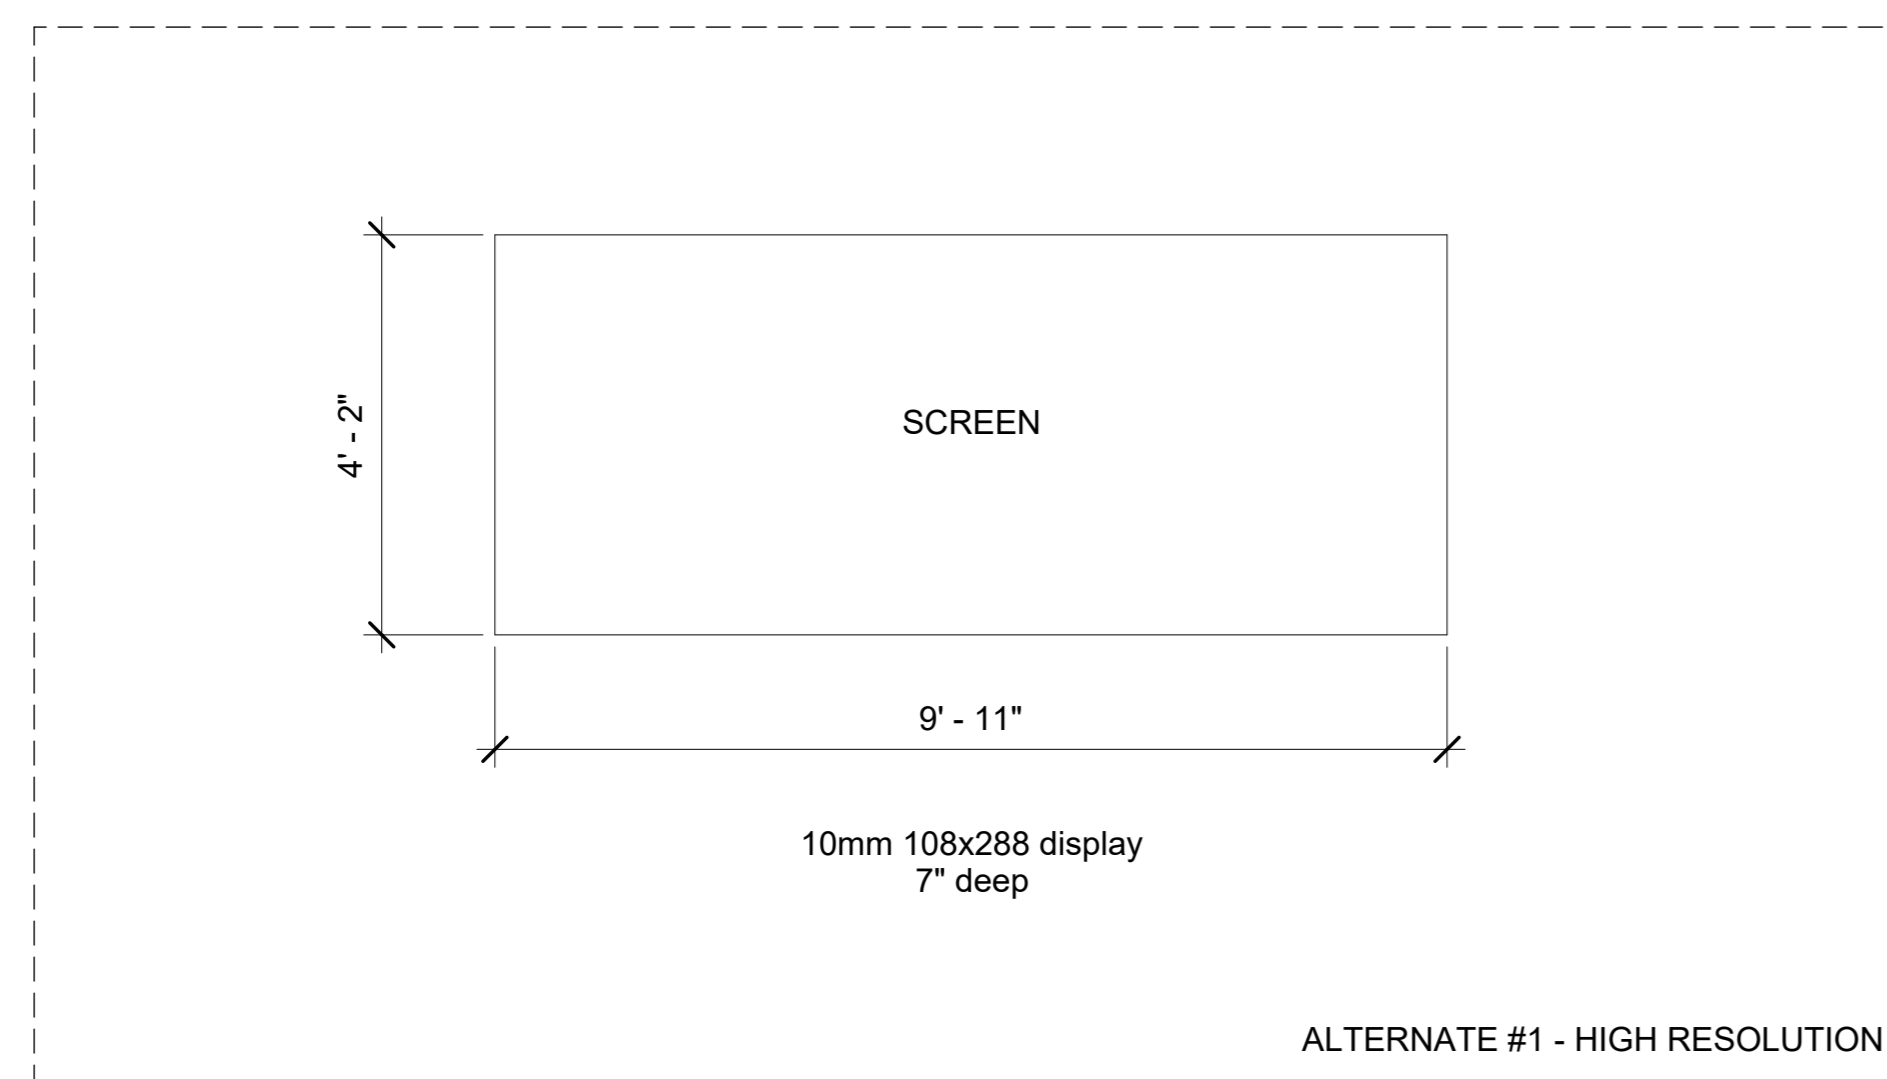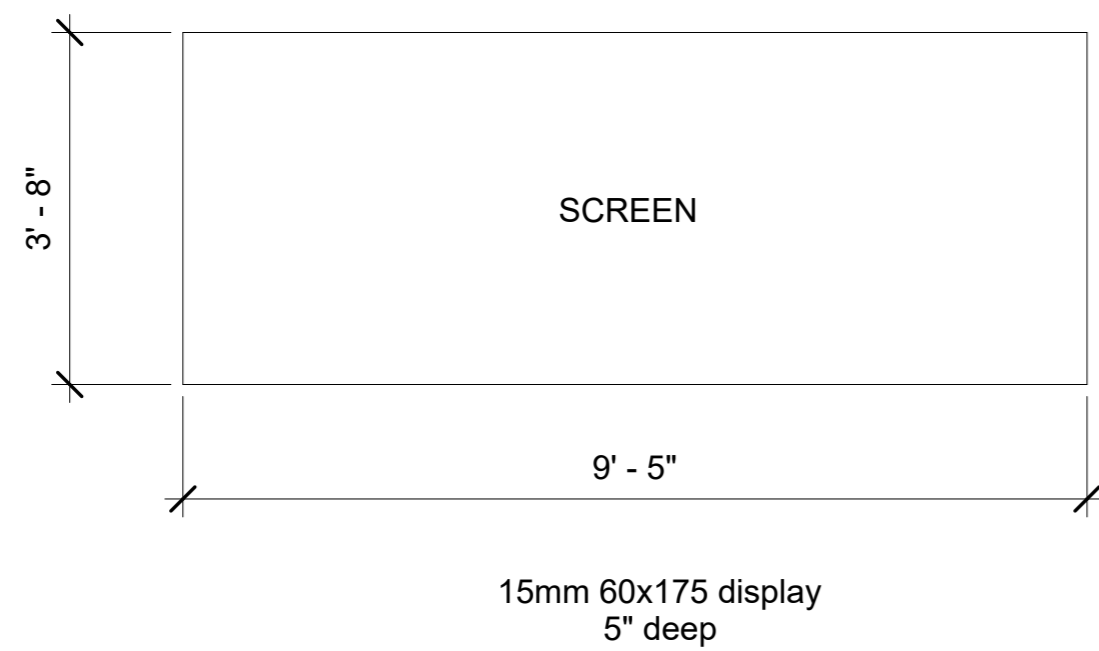


Notes:

- Bidder is responsible for establishing existing conditions and confirming that replacement display will fit in the existing architecture and existing electrical service. If not, bid must include labor and materials for adapting existing architecture for new display.
- Display shall require no network connection to the building and will rely on LTE wireless internet for programming. LTE wireless internet permanent plan to be included with bid.
- Full Color RGB LEDs
- Display must support Text, graphics, logos, basic animation, video clips, multiple font styles and sizes
- Automatic Dimming required, minimum 64 levels
- Viewing angles required to be minimum 160 degrees horizontal and 70 degrees vertical
- Front Ventilation
- Reference quote number 838660-1-0 when speaking with Kevin Kantack at Daktronics, Kevin.Kantack@daktronics.com or 405-229-4473.

① Outdoor Display Panels
1/2" = 1'-0"

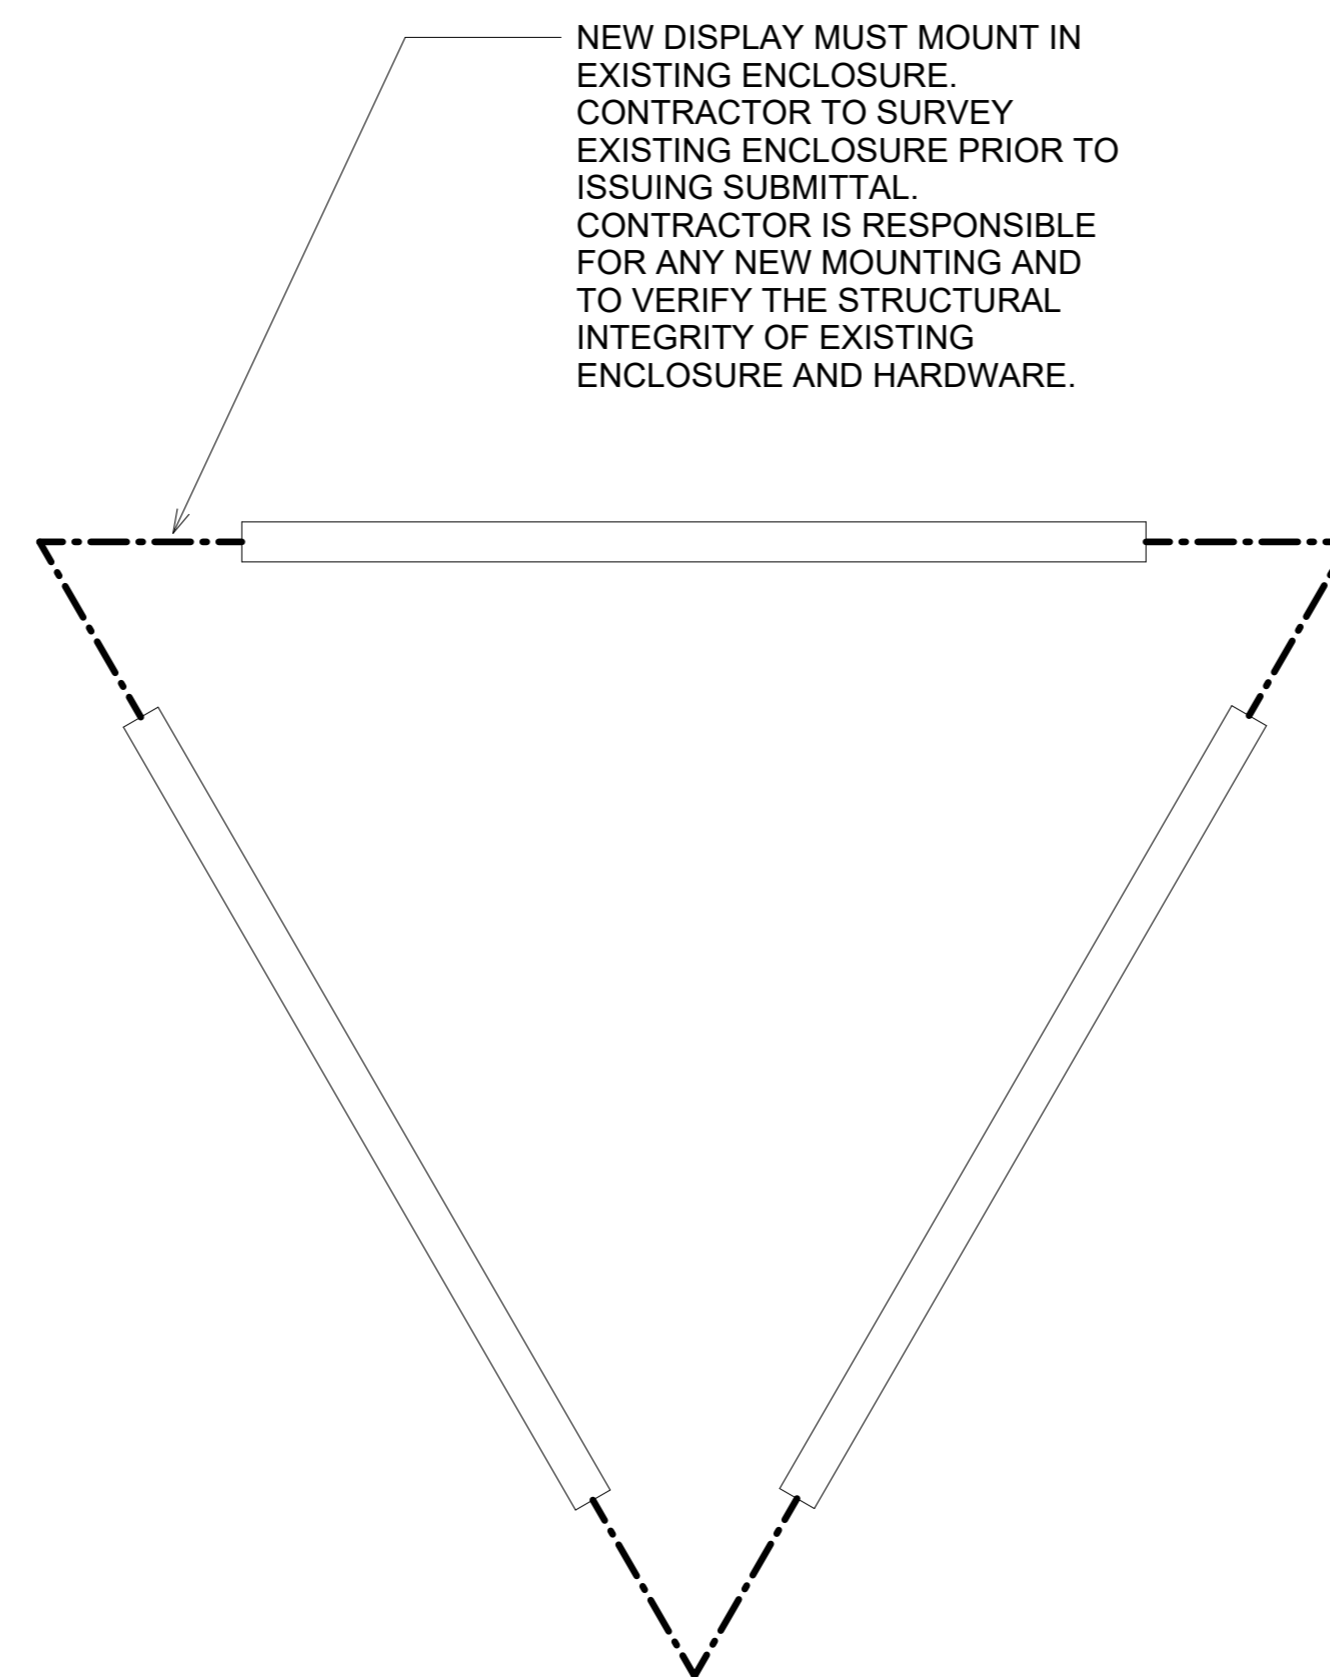

② Three-View Plan
1/2" = 1'-0"

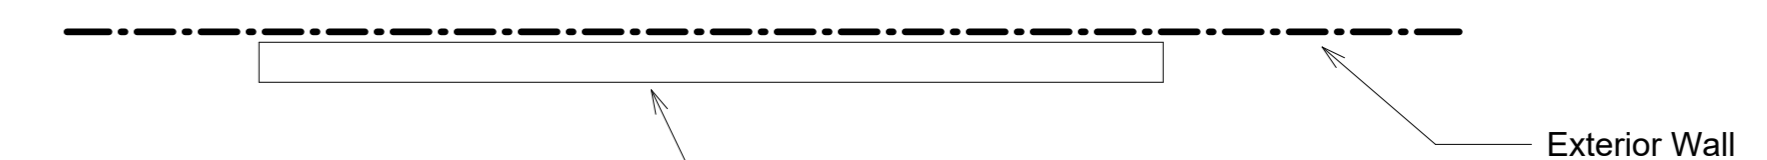

③ Single Face Plan
1/2" = 1'-0"



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T: 405.232.7007

PROJECT:
**TULSA
PERFORMING
ARTS CENTER**

PROJECT NUMBER:
202331.00

CONSULTANT:
Schuler Shook
LIGHTING DESIGN / THEATRE PLANNING / AUDIO VIDEO DESIGN
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No	Description	Date

SEAL:

ISSUE DATE:
1.24.2024

SHEET NUMBER:
OD001
OUTDOOR DISPLAY
PANELS

PROJECT:
PROJECT #
SP 23-2
TULSA
PERFORMING
ARTS CENTER -
PACKAGE No. 2
MECH., AV AND
THEATRICAL
LIGHTING
UPGRADES

PROJECT NUMBER:
202331.00

CONSULTANT:
Schuler Shook
 219 MAIN STREET SE, SUITE 200
 MINNEAPOLIS, MN 55414
 T 612.339.5958 F 612.337.5097
 schulershook.com

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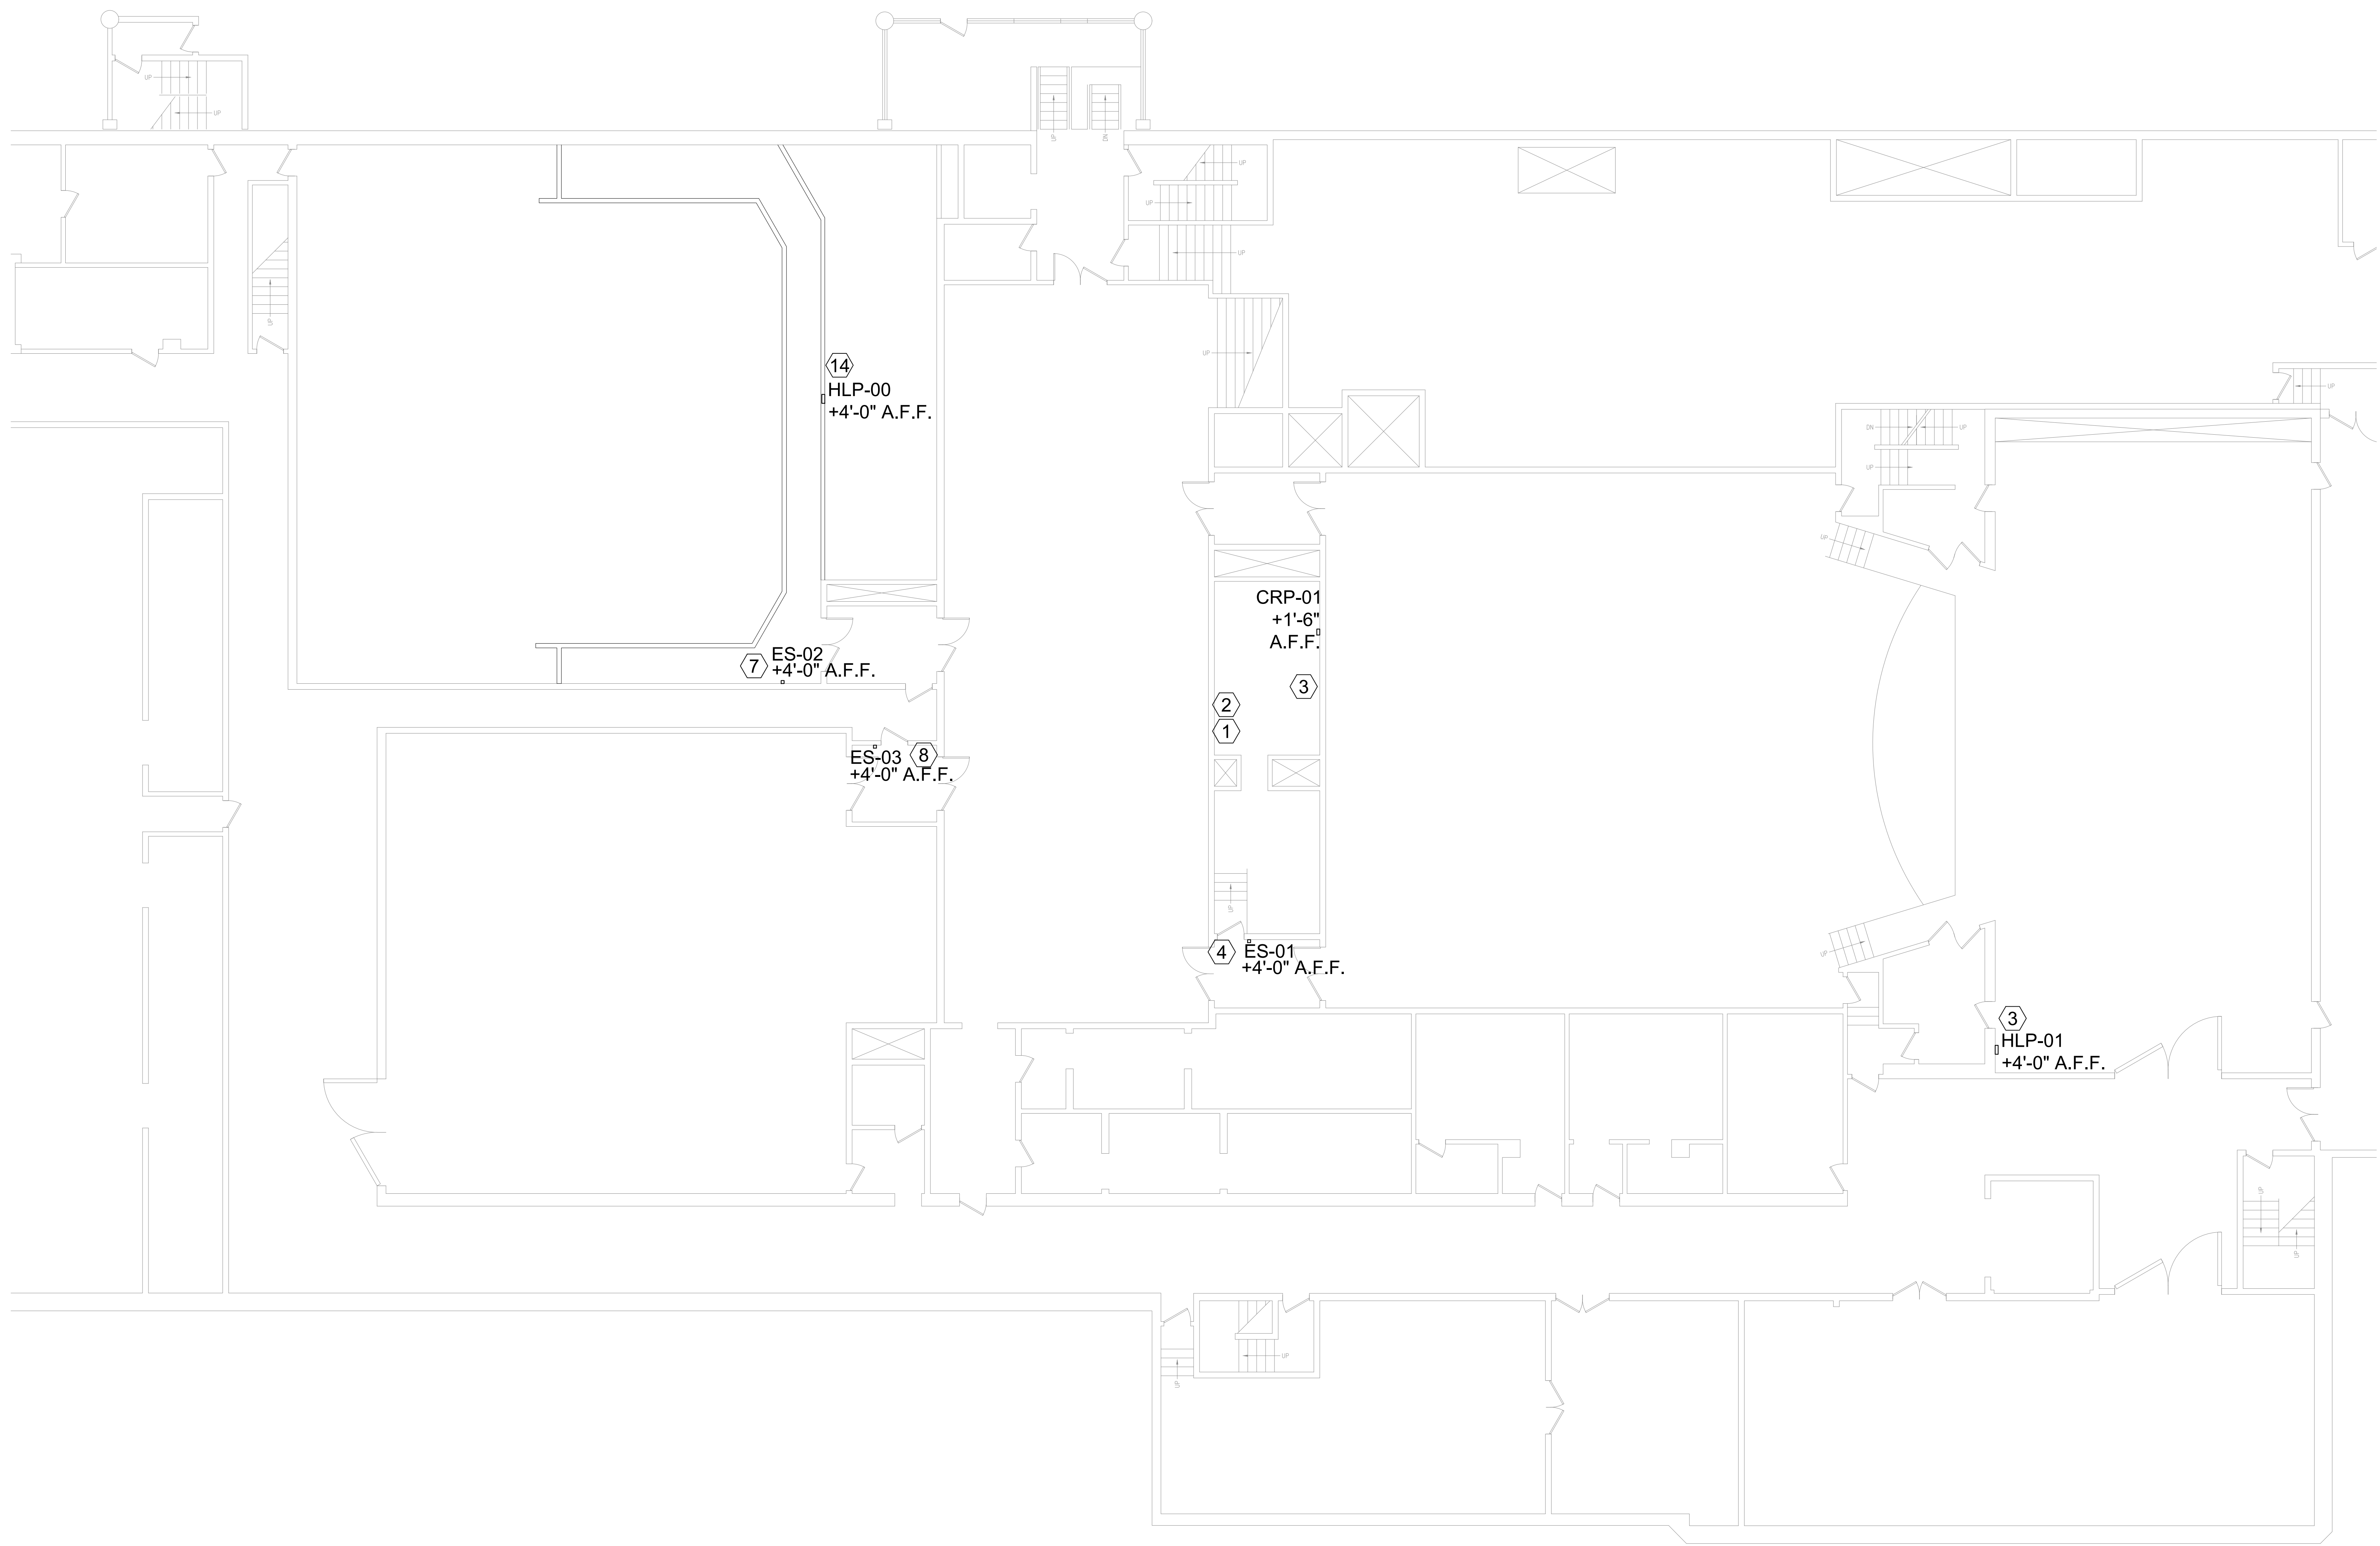
No.	Description	Date
2	95% REVIEW SET	12.19.2023
3	BID SET	01.24.2024

SEAL:


ISSUE DATE:
01.24.2024

SHEET NUMBER:

TL100
 SMALLTHEATRE
 FLOOR LEVEL



1 LEVEL 2 - 2ND STREET FLOOR LEVEL
 TL100 SCALE: 1/16" = 1'-0"

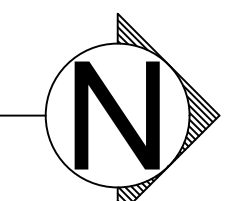

GENERAL NOTES:

- A. INSTALLATION SHALL CONFORM TO ALL APPLICABLE NEC, UL, STATE AND LOCAL CODES.
- B. ALL EMERGENCY EGRESS LIGHTING IS THE RESPONSIBILITY OF THE ELECTRICAL ENGINEER OR ELECTRICAL CONTRACTOR.
- C. ALL DIMMING CIRCUITS ARE TWO-WIRE. NO COMMON NEUTRALS SHALL BE USED.
- D. VERIFY ALL LOCATIONS OF WALL OR PANEL MOUNTED EQUIPMENT WITH OWNER AND DESIGN TEAM PRIOR TO INSTALLATION.

KEYED NOTES:

- 1. IN EXISTING CONTROL RACK REPLACE EXISTING CONTROL PROCESSOR, RACK MOUNTED KEYBOARD, RACK MOUNTED MONITOR, DMX GATEWAY, NETWORK SWITCHES, NETWORK PATCHBAY, AND UPS WITH NEW EQUIPMENT PER SPECIFICATION. MAINTAIN PATCHBAY LABELING. MAINTAIN DRY LINES AND DMX REPEATERS.
- 2. INSTALL NEW PARADIGM PROCESSOR IN EXISTING CONTROL RACK BELOW SWITCHES.
- 3. INSTALL NEW HOUSE LIGHT CONTROL PANEL (HLP) TO REPLACE EXISTING LIGHTING CONTROL PANEL. PROVIDE NEW WIRING FROM NEAREST CONTROL RACK. IF (HLP) WILL NOT FIT IN EXISTING PANEL, MOUNT IN SEPARATE SURFACE BOX ADJACENT TO PANEL AND MOUNT COVER OPENING OF EXISTING PANEL WITH COVER

- 4. INSTALL 5 BUTTON STATION IN VOM. WIRE TO RACK IN WILLIAMS CONTROL BOOTH.
- 5. IN EXISTING CONTROL RACK REPLACE EXISTING CONTROL PROCESSOR, RACK MOUNTED KEYBOARD, RACK MOUNTED MONITOR, DMX GATEWAY, NETWORK SWITCHES, NETWORK PATCHBAY, AND UPS WITH NEW EQUIPMENT PER SPECIFICATION. MAINTAIN PATCHBAY LABELING. MAINTAIN DRY LINES AND DMX REPEATERS.
- 6. INSTALL NEW PARADIGM PROCESSOR IN EXISTING CONTROL RACK BELOW SWITCHES. PROCESSOR SERVES DOENGES AND NORMAN SPACES.

- 7. PROVIDE 10 BUTTON STATION AT THIS LOCATION TO REPLACE EXISTING PANEL. CONTROL WIRE TO RUN FROM HERE TO CONTROL RACK IN DOENGES BOOTH.
- 8. PROVIDE NEW 10 BUTTON STATION AT THIS LOCATION. DAISY CHAIN STATION FROM STATION IN DOENGES.
- 9. IN CONTROL RACK REPLACE DMX NETWORK GATEWAYS, NETWORK PATCH BAY, RVI, AND UPS WITH NEW EQUIPMENT PER SPECIFICATION. MAINTAIN PATCHBAY AND DRY-LINE LABELING.
- 10. REPLACE EXISTING WALL STATION WITH ENTRY STATION.

- 11. VERIFY CONNECTION OF NEW PARADIGM PROCESSORS TO EXISTING HOUSE LIGHT AND PRODUCTION DIMMER RACKS. PROVIDE NETWORK INTERFACE OR DMX INTERFACE EQUIPMENT AS REQUIRED.
- 12. COORDINATE CONNECTION OF EXISTING EMERGENCY LIGHTING SYSTEM TO NEW PARADIGM CONTROL SYSTEM.
- 13. MOUNT NEW HLP TO WALL TO REPLACE EXISTING PANEL.
- 14. REPLACE EXISTING PANEL. VERIFY LOCATION.

THIS DRAWING INDICATES THEATRE EQUIPMENT LAYOUT AND DESIGN OF THEATRE SYSTEMS. REVIEW BY A QUALIFIED ENGINEER IS NECESSARY TO ASSURE SAFETY AND CODE COMPLIANCE.

REFER TO E-SERIES DRAWINGS FOR ELECTRICAL FEEDS, DISCONNECT SWITCHES, CONDUIT, AND WIRE FOR ALL RIGGING EQUIPMENT. DIVISION 26 CONTRACTOR SHALL PROVIDE AND INSTALL ALL ELECTRICAL EQUIPMENT AND CONTROL WIRING FOR A COMPLETE AND OPERABLE SYSTEM.

PROJECT:
PROJECT #
SP 23-2
TULSA
PERFORMING
ARTS CENTER -
PACKAGE No. 2
MECH., AV AND
THEATRICAL
LIGHTING
UPGRADES

PROJECT NUMBER:
202331.00

CONSULTANT:
 Schuler Shook
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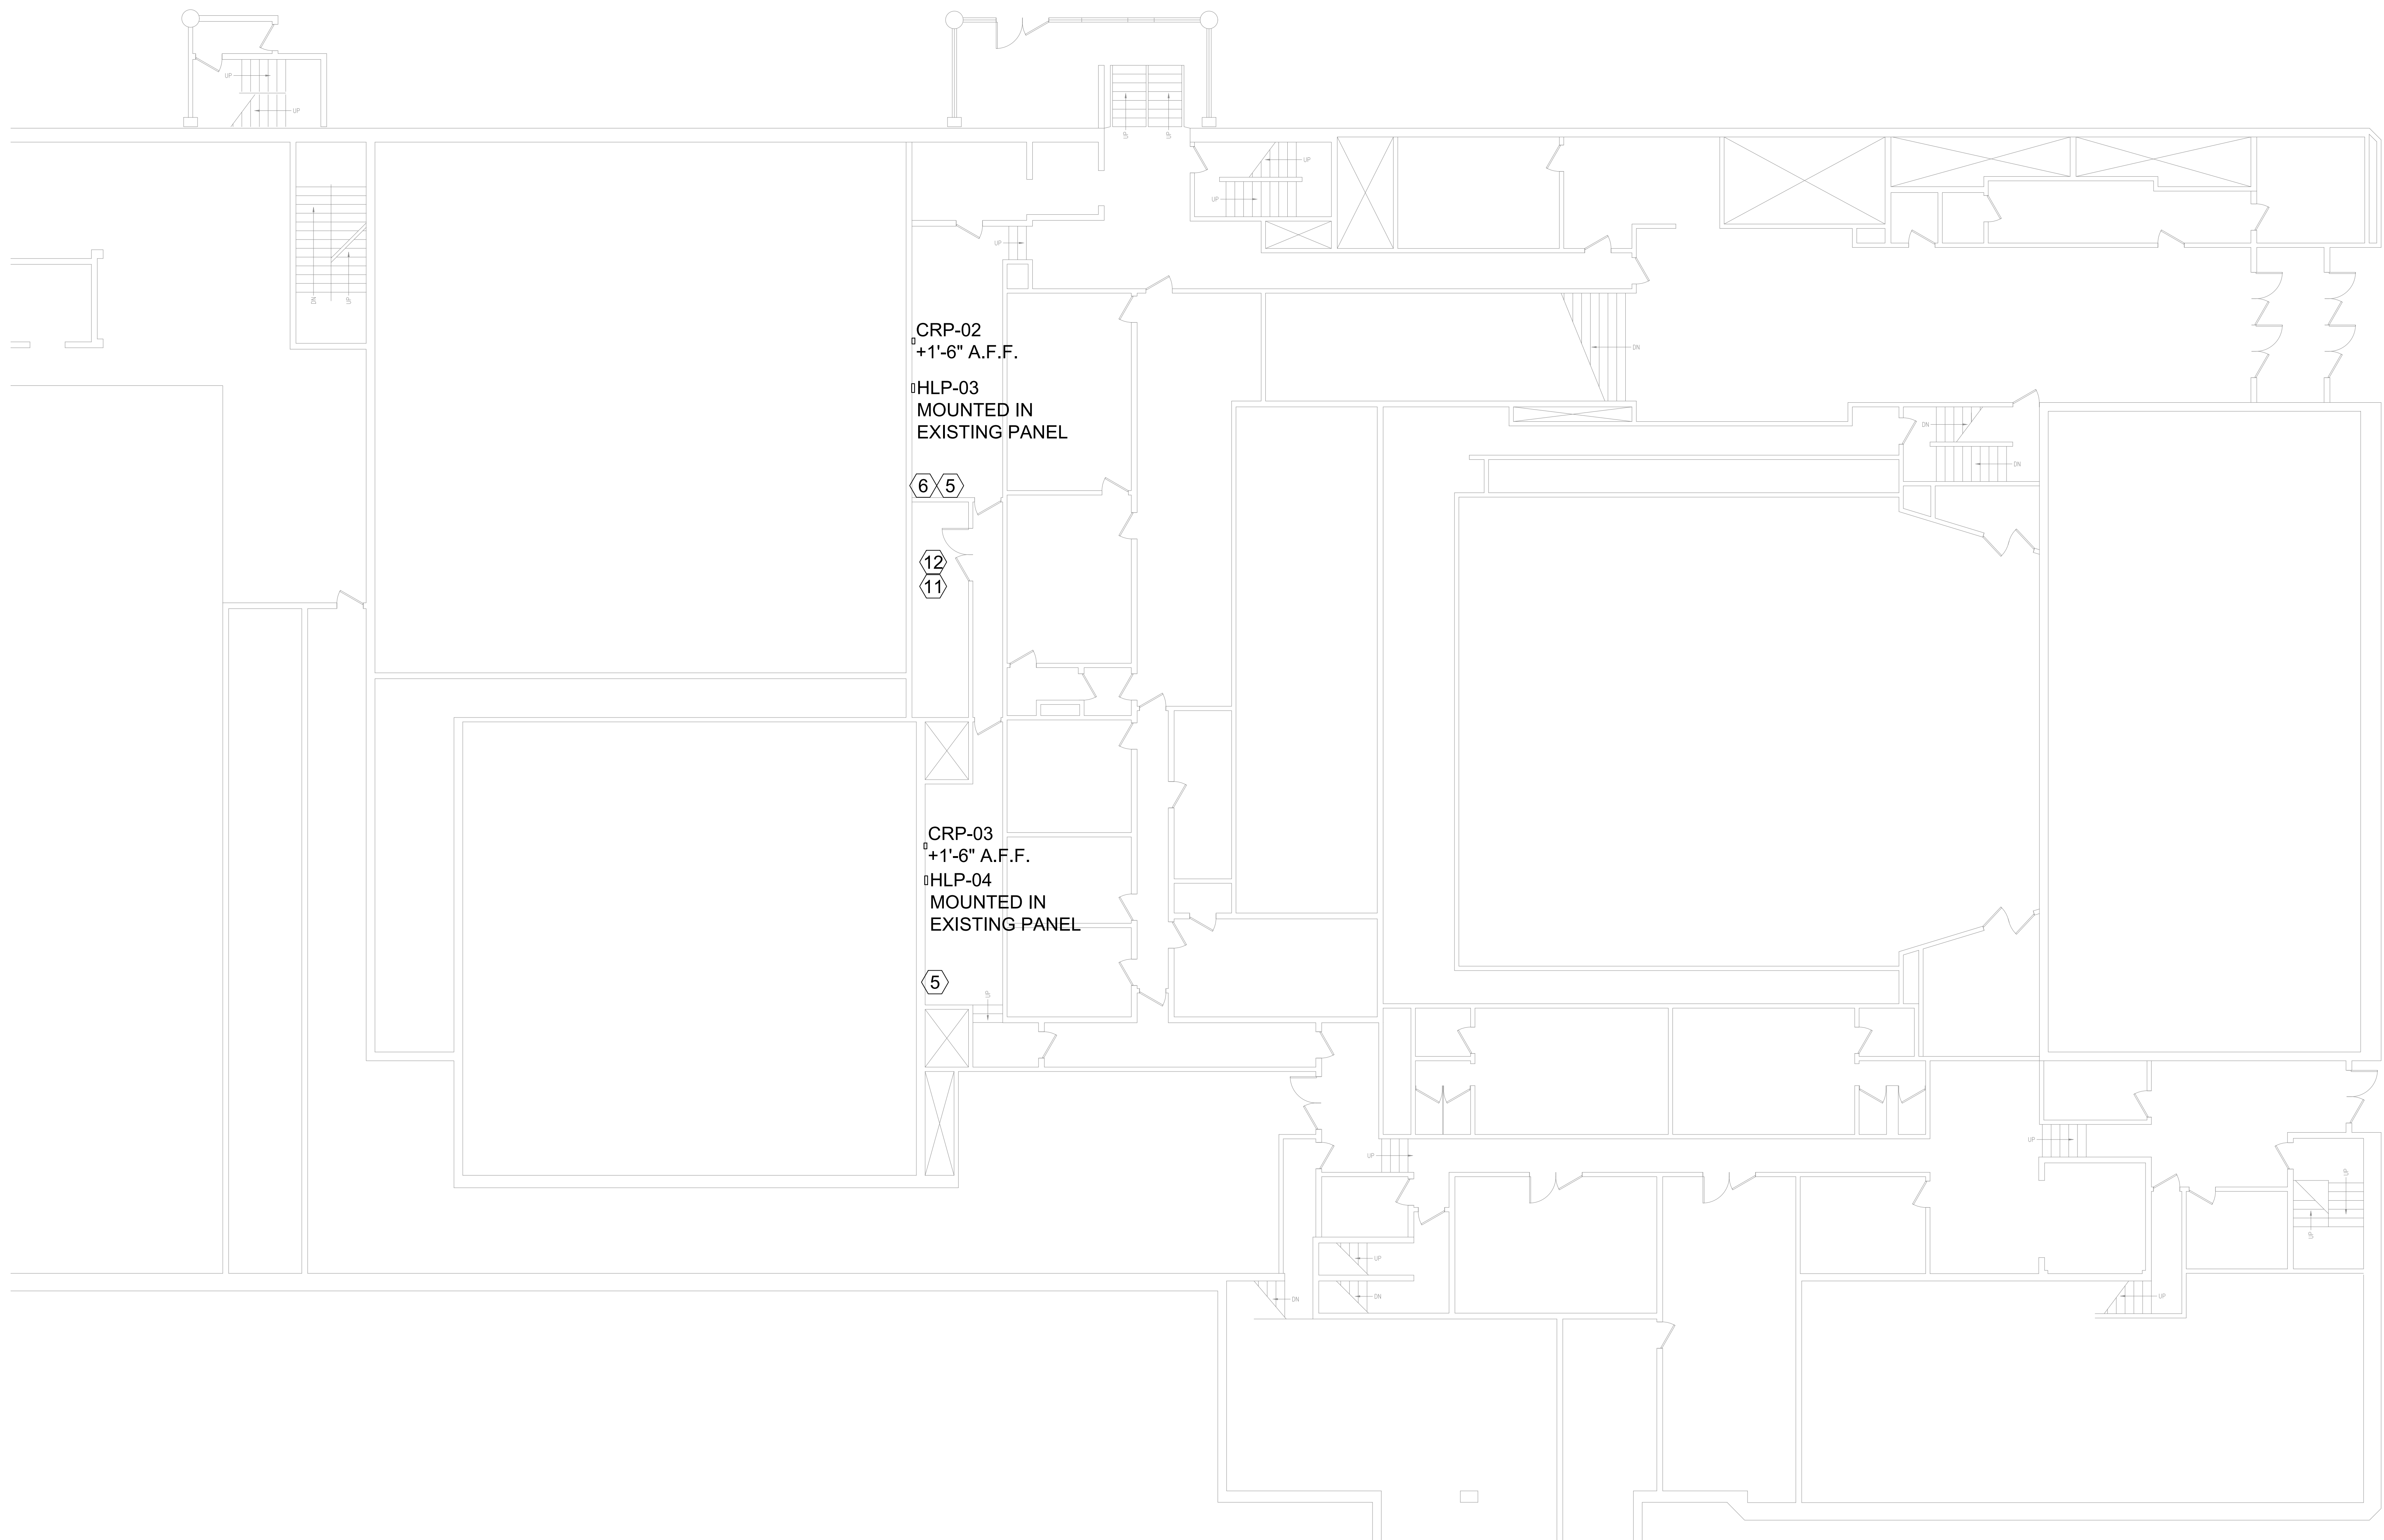
REVISIONS:

No	Description	Date
2	95% REVIEW SET	12.19.2023
3	BID SET	01.24.2024

SEAL:

ISSUE DATE:
01.24.2024

SHEET NUMBER:
TL101
SECOND STREET
FLOOR LEVEL



1 LEVEL 3 - 2ND STREET MEZZANINE LEVEL
TL101 / SCALE: 1/16" = 1'-0"

GENERAL NOTES:

- A. INSTALLATION SHALL CONFORM TO ALL APPLICABLE NEC, UL, STATE AND LOCAL CODES.
- B. ALL EMERGENCY EGRESS LIGHTING IS THE RESPONSIBILITY OF THE ELECTRICAL ENGINEER OR ELECTRICAL CONTRACTOR.
- C. ALL DIMMING CIRCUITS ARE TWO-WIRE. NO COMMON NEUTRALS SHALL BE USED.
- D. VERIFY ALL LOCATIONS OF WALL OR PANEL MOUNTED EQUIPMENT WITH OWNER AND DESIGN TEAM PRIOR TO INSTALLATION.

KEYED NOTES:

1. IN EXISTING CONTROL RACK REPLACE EXISTING CONTROL PROCESSOR, RACK MOUNTED KEYBOARD, RACK MOUNTED MONITOR, DMX GATEWAY, NETWORK SWITCHES, NETWORK PATCHBAY, AND UPS WITH NEW EQUIPMENT PER SPECIFICATION. MAINTAIN PATCHBAY LABELING. MAINTAIN DRY LINES AND DMX REPEATERS.
2. INSTALL NEW PARADIGM PROCESSOR IN EXISTING CONTROL RACK BELOW SWITCHES.
3. INSTALL NEW HOUSE LIGHT CONTROL PANEL (HLP) TO REPLACE EXISTING LIGHTING CONTROL PANEL. PROVIDE NEW WIRING FROM NEAREST CONTROL RACK. IF (HLP) WILL NOT FIT IN EXISTING PANEL, MOUNT IN SEPARATE SURFACE BOX ADJACENT TO PANEL AND MOUNT COVER OPENING OF EXISTING PANEL WITH COVER


4. INSTALL 5 BUTTON STATION IN VOM. WIRE TO RACK IN WILLIAMS CONTROL BOOTH.
5. IN EXISTING CONTROL RACK REPLACE EXISTING CONTROL PROCESSOR, RACK MOUNTED KEYBOARD, RACK MOUNTED MONITOR, DMX GATEWAY, NETWORK SWITCHES, NETWORK PATCHBAY, AND UPS WITH NEW EQUIPMENT PER SPECIFICATION. MAINTAIN PATCHBAY LABELING. MAINTAIN DRY LINES AND DMX REPEATERS.
6. INSTALL NEW PARADIGM PROCESSOR IN EXISTING CONTROL RACK BELOW SWITCHES. PROCESSOR SERVES DOENGES AND NORMAN SPACES.

7. PROVIDE 10 BUTTON STATION AT THIS LOCATION TO REPLACE EXISTING PANEL. CONTROL WIRE TO RUN FROM HERE TO CONTROL RACK IN DOENGES BOOTH.
8. PROVIDE NEW 10 BUTTON STATION AT THIS LOCATION. DAISY CHAIN STATION FROM STATION IN DOENGES.
9. IN CONTROL RACK REPLACE DMX NETWORK GATEWAYS, NETWORK PATCH BAY, RVI, AND UPS WITH NEW EQUIPMENT PER SPECIFICATION. MAINTAIN PATCHBAY AND DRY-LINE LABELING. INCLUDE NEW TOUCH SCREEN IN THIS RACK.
10. REPLACE EXISTING WALL STATION WITH ENTRY STATION.

11. VERIFY CONNECTION OF NEW PARADIGM PROCESSORS TO EXISTING HOUSE LIGHT AND PRODUCTION DIMMER RACKS. PROVIDE NETWORK INTERFACE OR DMX INTERFACE EQUIPMENT AS REQUIRED.
12. COORDINATE CONNECTION OF EXISTING EMERGENCY LIGHTING SYSTEM TO NEW PARADIGM CONTROL SYSTEM.
13. MOUNT NEW HLP TO WALL TO REPLACE EXISTING PANEL.
14. REPLACE EXISTING PANEL. VERIFY LOCATION.

THIS DRAWING INDICATES THEATRE EQUIPMENT LAYOUT AND DESIGN OF THEATRE SYSTEMS. REVIEW BY A QUALIFIED ENGINEER IS NECESSARY TO ASSURE SAFETY AND CODE COMPLIANCE.

REFER TO E-SERIES DRAWINGS FOR ELECTRICAL FEEDS, DISCONNECT SWITCHES, CONDUIT, AND WIRE FOR ALL RIGGING EQUIPMENT. DIVISION 26 CONTRACTOR SHALL PROVIDE AND INSTALL ALL ELECTRICAL EQUIPMENT AND CONTROL WIRING FOR A COMPLETE AND OPERABLE SYSTEM.

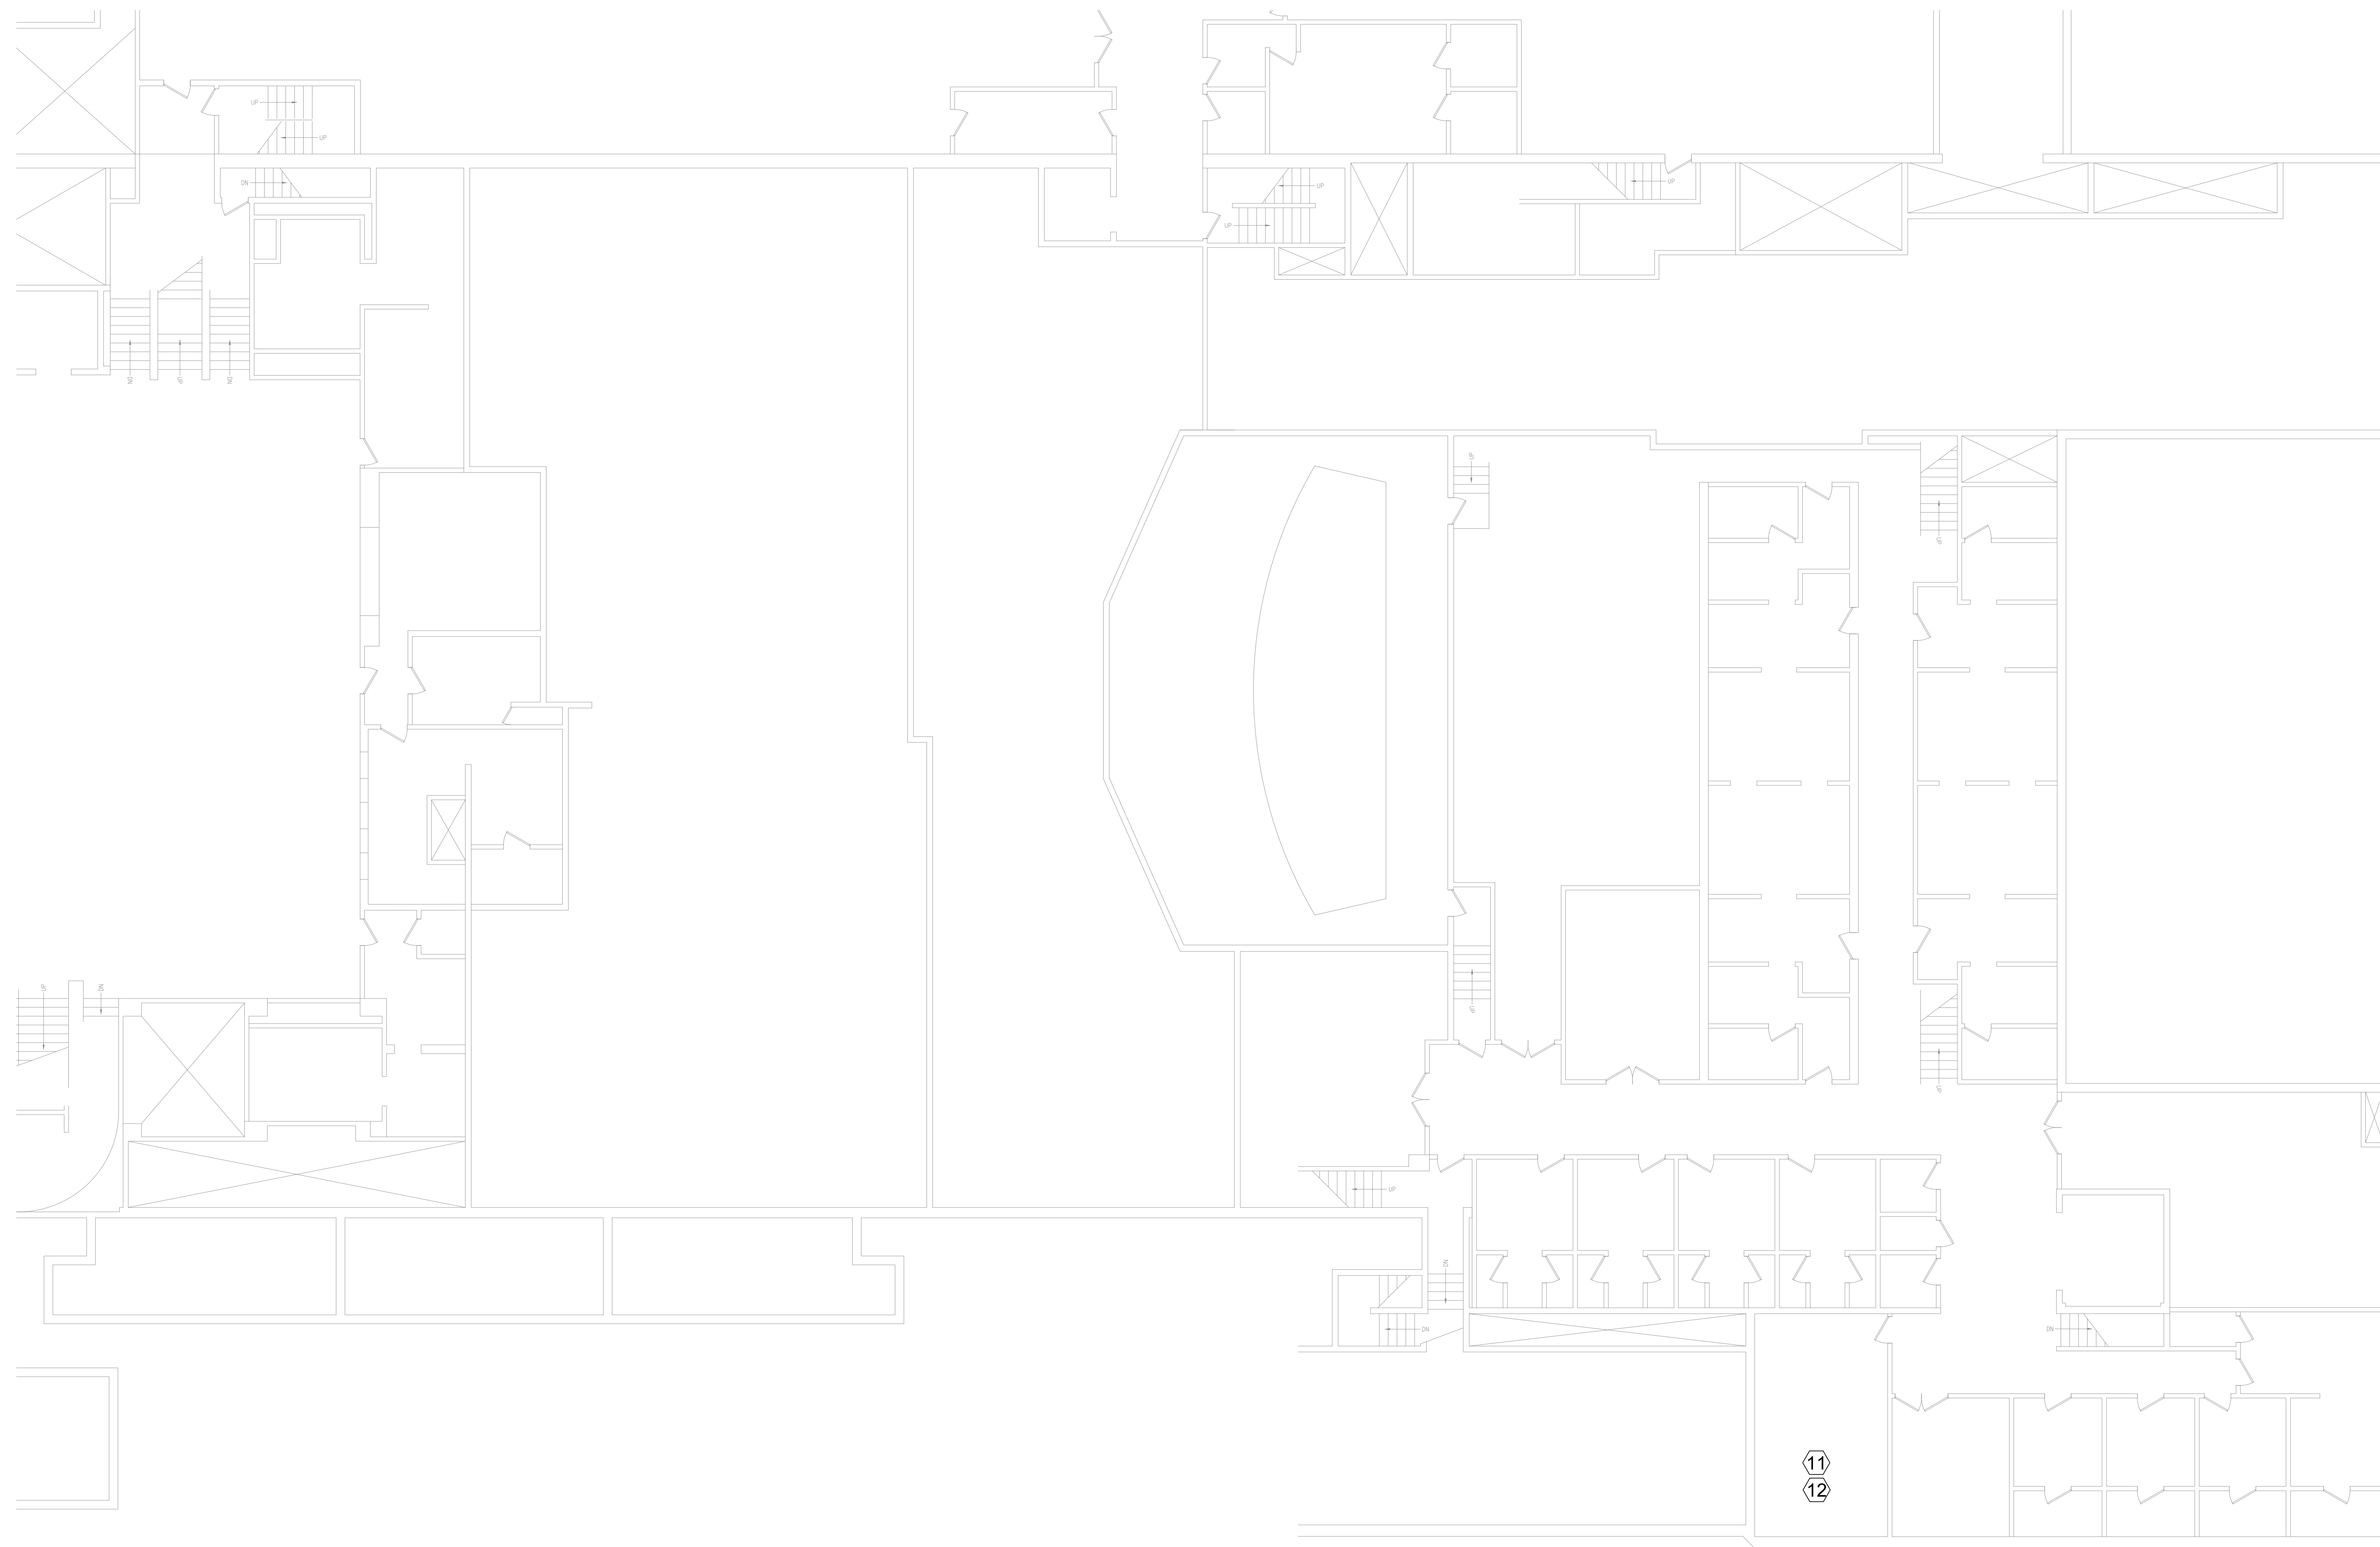

1 LEVEL 4 - THIRD STREET FLOOR LEVEL
 TL102 / SCALE: 1/16" = 1'-0"

GENERAL NOTES:

- A. INSTALLATION SHALL CONFORM TO ALL APPLICABLE NEC, UL, STATE AND LOCAL CODES.
- B. ALL EMERGENCY EGRESS LIGHTING IS THE RESPONSIBILITY OF THE ELECTRICAL ENGINEER OR ELECTRICAL CONTRACTOR.
- C. ALL DIMMING CIRCUITS ARE TWO-WIRE. NO COMMON NEUTRALS SHALL BE USED.
- D. VERIFY ALL LOCATIONS OF WALL OR PANEL MOUNTED EQUIPMENT WITH OWNER AND DESIGN TEAM PRIOR TO INSTALLATION.

KEYED NOTES:

1. IN EXISTING CONTROL RACK REPLACE EXISTING CONTROL PROCESSOR, RACK MOUNTED KEYBOARD, RACK MOUNTED MONITOR, DMX GATEWAY, NETWORK SWITCHES, NETWORK PATCHBAY, AND UPS WITH NEW EQUIPMENT PER SPECIFICATION. MAINTAIN PATCHBAY LABELING. MAINTAIN DRY LINES AND DMX REPEATERS.
2. INSTALL NEW PARADIGM PROCESSOR IN EXISTING CONTROL RACK BELOW SWITCHES.
3. INSTALL NEW HOUSE LIGHT CONTROL PANEL (HLP) TO REPLACE EXISTING LIGHTING CONTROL PANEL. PROVIDE NEW WIRING FROM NEAREST CONTROL RACK. IF (HLP) WILL NOT FIT IN EXISTING PANEL, MOUNT IN SEPARATE SURFACE BOX ADJACENT TO PANEL AND MOUNT COVER OPENING OF EXISTING PANEL WITH COVER

- PLATE. IF HLP WILL NOT FIT IN PANEL COORDINATE LOCATION WITH DESIGN TEAM
4. INSTALL 5 BUTTON STATION IN VOM. WIRE TO RACK IN WILLIAMS CONTROL BOOTH.
 5. IN EXISTING CONTROL RACK REPLACE EXISTING CONTROL PROCESSOR, RACK MOUNTED KEYBOARD, RACK MOUNTED MONITOR, DMX GATEWAY, NETWORK SWITCHES, NETWORK PATCHBAY, AND UPS WITH NEW EQUIPMENT PER SPECIFICATION. MAINTAIN PATCHBAY LABELING. MAINTAIN DRY LINES AND DMX REPEATERS.
 6. INSTALL NEW PARADIGM PROCESSOR IN EXISTING CONTROL RACK BELOW SWITCHES. PROCESSOR SERVES DOENGES AND NORMAN SPACES.

7. PROVIDE 10 BUTTON STATION AT THIS LOCATION TO REPLACE EXISTING PANEL. CONTROL WIRE TO RUN FROM HERE TO CONTROL RACK IN DOENGES BOOTH.
8. PROVIDE NEW 10 BUTTON STATION AT THIS LOCATION. DAISY CHAIN STATION FROM STATION IN DOENGES.
9. IN CONTROL RACK REPLACE DMX NETWORK GATEWAYS, NETWORK PATCH BAY, RVI, AND UPS WITH NEW EQUIPMENT PER SPECIFICATION. MAINTAIN PATCHBAY AND DRY-LINE LABELING. INCLUDE NEW TOUCH SCREEN IN THIS RACK.
10. REPLACE EXISTING WALL STATION WITH ENTRY STATION.

11. VERIFY CONNECTION OF NEW PARADIGM PROCESSORS TO EXISTING HOUSE LIGHT AND PRODUCTION DIMMER RACKS. PROVIDE NETWORK INTERFACE OR DMX INTERFACE EQUIPMENT AS REQUIRED.
12. COORDINATE CONNECTION OF EXISTING EMERGENCY LIGHTING SYSTEM TO NEW PARADIGM CONTROL SYSTEM.
13. MOUNT NEW HLP TO WALL TO REPLACE EXISTING PANEL.
14. REPLACE EXISTING PANEL. VERIFY LOCATION.

THIS DRAWING INDICATES THEATRE EQUIPMENT LAYOUT AND DESIGN OF THEATRE SYSTEMS. REVIEW BY A QUALIFIED ENGINEER IS NECESSARY TO ASSURE SAFETY AND CODE COMPLIANCE.

REFER TO E-SERIES DRAWINGS FOR ELECTRICAL FEEDS, DISCONNECT SWITCHES, CONDUIT, AND WIRE FOR ALL RIGGING EQUIPMENT. DIVISION 26 CONTRACTOR SHALL PROVIDE AND INSTALL ALL ELECTRICAL EQUIPMENT AND CONTROL WIRING FOR A COMPLETE AND OPERABLE SYSTEM.



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PROJECT:
PROJECT #
SP 23-2
TULSA
PERFORMING
ARTS CENTER -
PACKAGE No. 2
MECH., AV AND
THEATRICAL
LIGHTING
UPGRADES

PROJECT NUMBER:
202331.00

CONSULTANT:
 THEATRE PLANNERS / LIGHTING DESIGNERS
Schuler Shook
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 schulershook.com

REVISIONS:

No	Description	Date
2	95% REVIEW SET	12.19.2023
3	BID SET	01.24.2024

SEAL:

ISSUE DATE:
01.24.2024

SHEET NUMBER:
TL102
THIRD STREET
FLOOR LEVEL

PROJECT:
PROJECT #
SP 23-2
TULSA
PERFORMING
ARTS CENTER -
PACKAGE No. 2
MECH., AV AND
THEATRICAL
LIGHTING
UPGRADES


PROJECT NUMBER:
202331.00

CONSULTANT:
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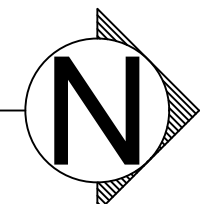
REVISIONS:

No	Description	Date
2	95% REVIEW SET	12.19.2023
3	BID SET	01.24.2024

SEAL:

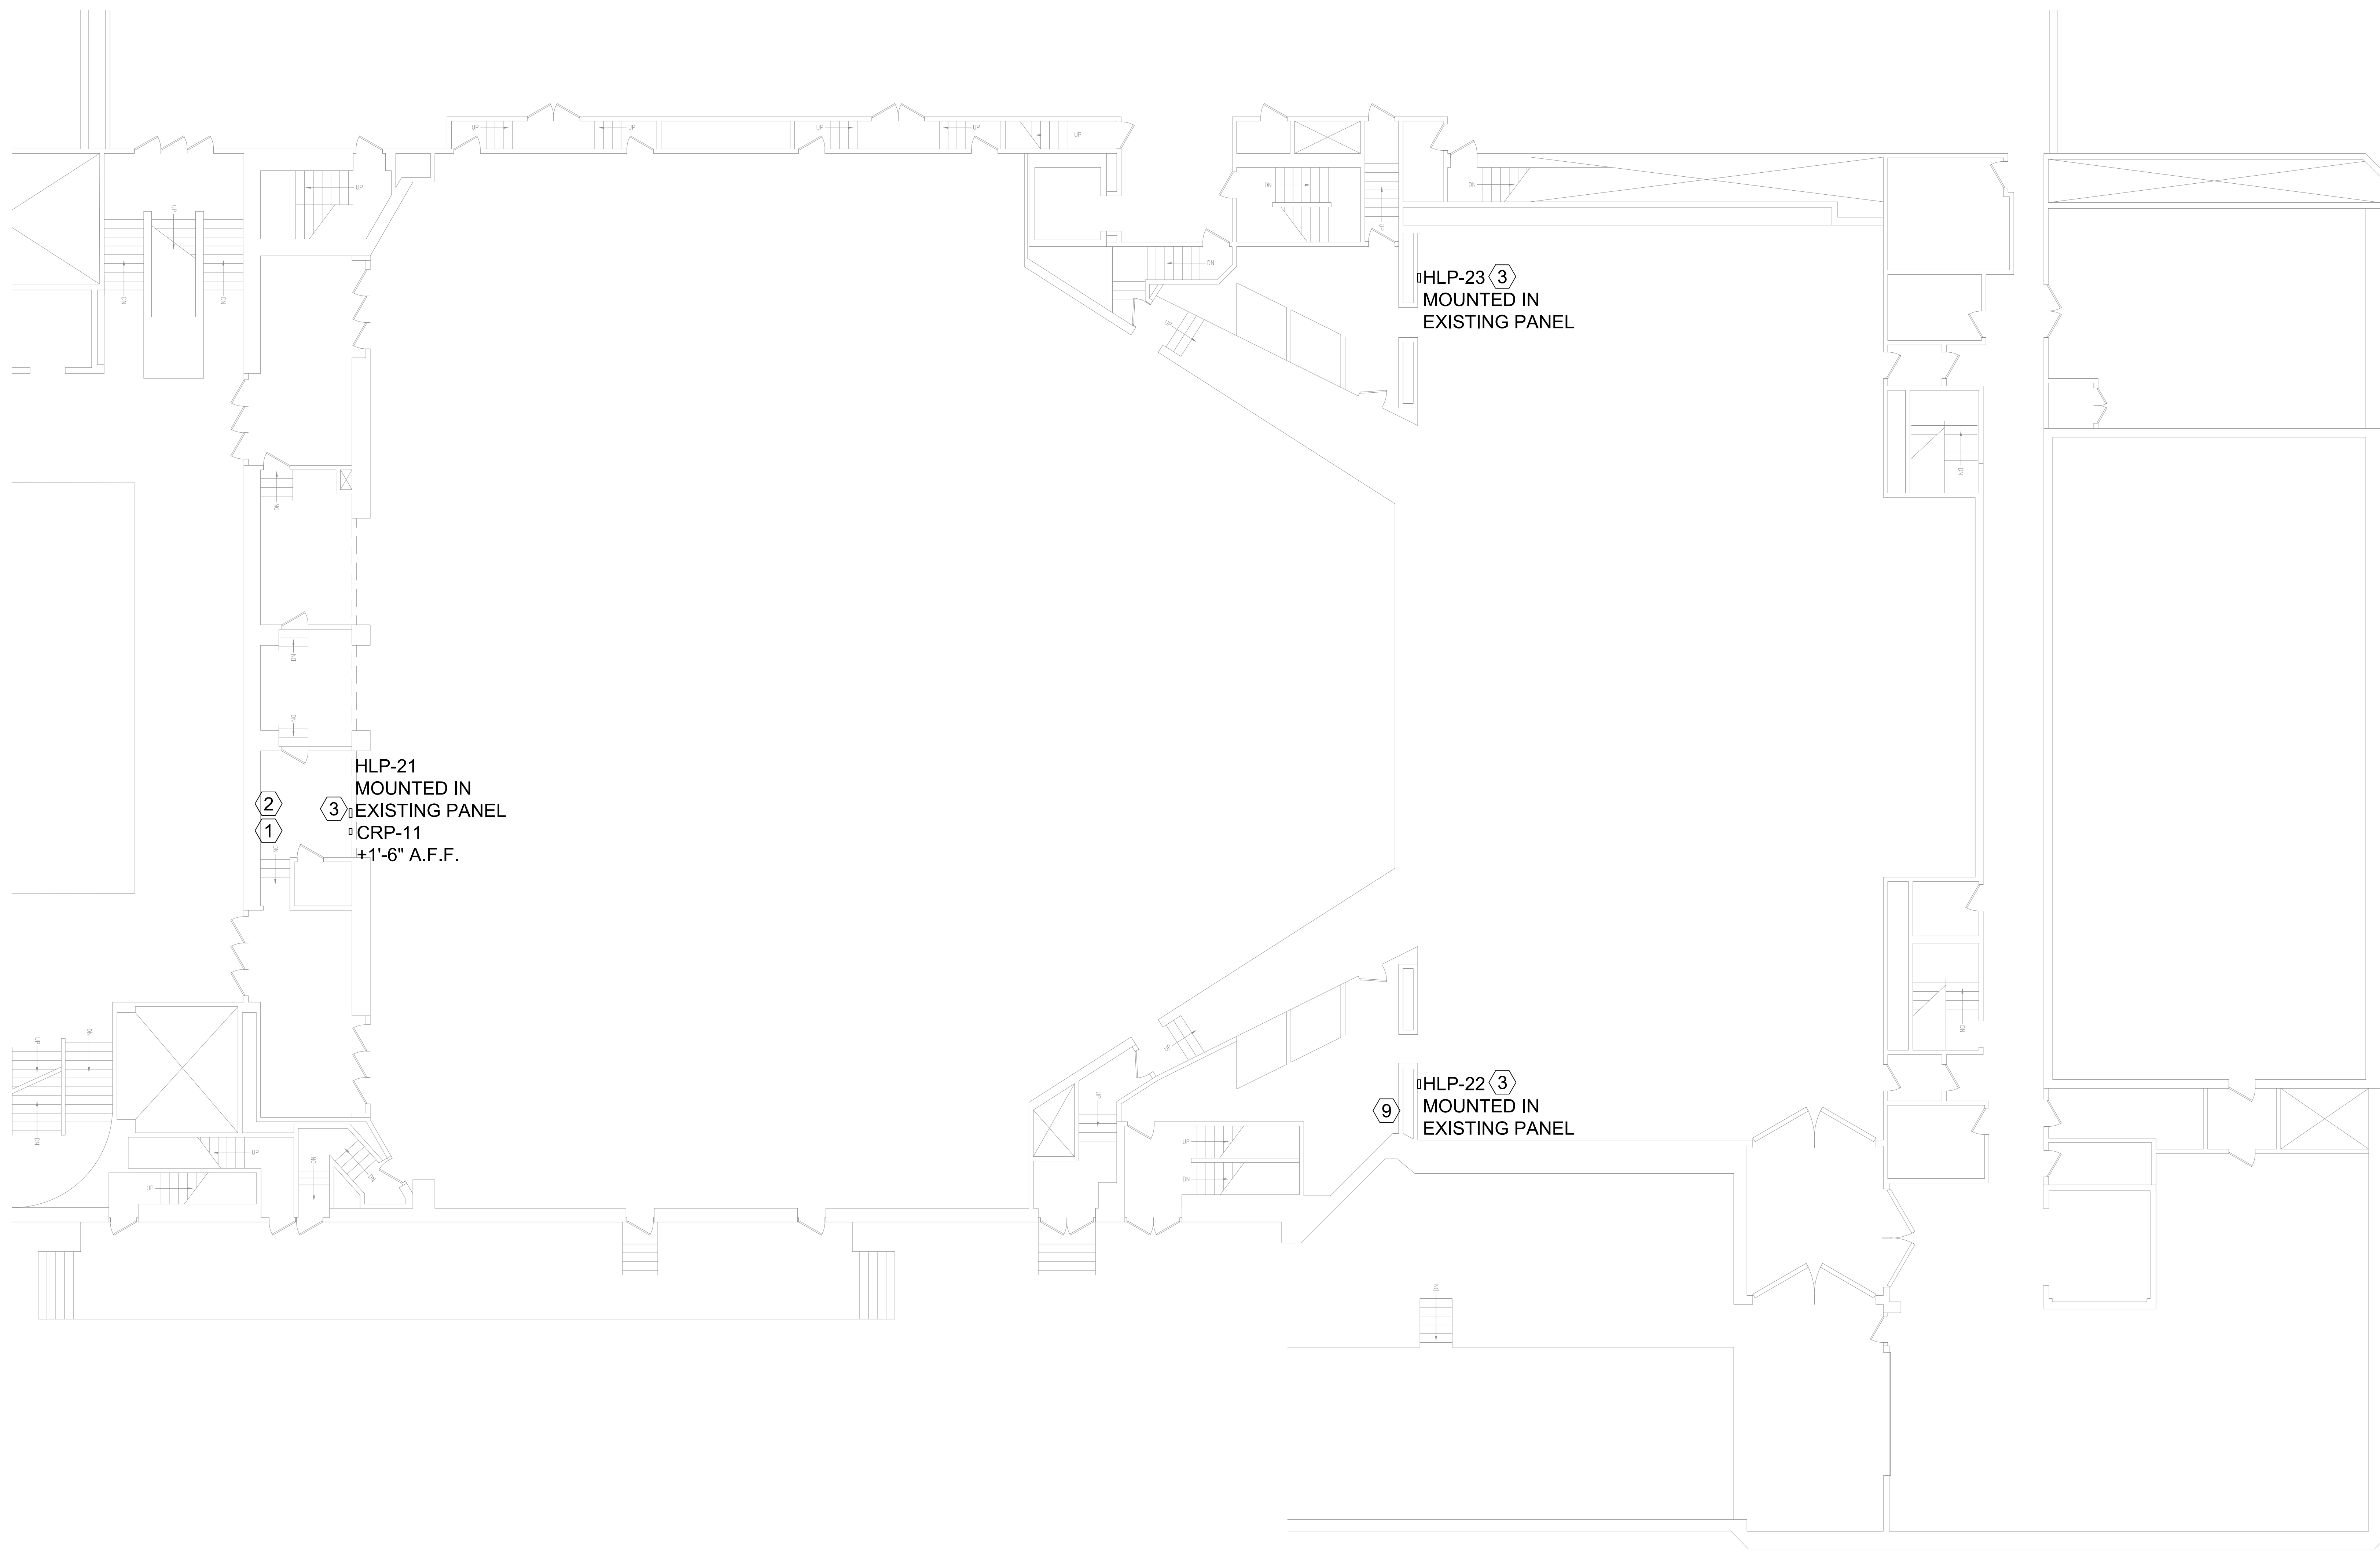

1 LEVEL 5 - ORCHESTRA FLOOR LEVEL
TL103A SCALE: 1/16" = 1'-0"



GENERAL NOTES:

- A. INSTALLATION SHALL CONFORM TO ALL APPLICABLE NEC, UL, STATE AND LOCAL CODES.
- B. ALL EMERGENCY EGRESS LIGHTING IS THE RESPONSIBILITY OF THE ELECTRICAL ENGINEER OR ELECTRICAL CONTRACTOR.
- C. ALL DIMMING CIRCUITS ARE TWO-WIRE. NO COMMON NEUTRALS SHALL BE USED.
- D. VERIFY ALL LOCATIONS OF WALL OR PANEL MOUNTED EQUIPMENT WITH OWNER AND DESIGN TEAM PRIOR TO INSTALLATION.

KEYED NOTES:

- 1. IN EXISTING CONTROL RACK REPLACE EXISTING CONTROL PROCESSOR, RACK MOUNTED KEYBOARD, RACK MOUNTED MONITOR, DMX GATEWAY, NETWORK SWITCHES, NETWORK PATCHBAY, AND UPS WITH NEW EQUIPMENT PER SPECIFICATION. MAINTAIN PATCHBAY LABELING. MAINTAIN DRY LINES AND DMX REPEATERS.
- 2. INSTALL NEW PARADIGM PROCESSOR IN EXISTING CONTROL RACK BELOW SWITCHES.
- 3. INSTALL NEW HOUSE LIGHT CONTROL PANEL (HLP) TO REPLACE EXISTING LIGHTING CONTROL PANEL. PROVIDE NEW WIRING FROM NEAREST CONTROL RACK. IF (HLP) WILL NOT FIT IN EXISTING PANEL, MOUNT IN SEPARATE SURFACE BOX ADJACENT TO PANEL AND MOUNT COVER OPENING OF EXISTING PANEL WITH COVER

- 4. INSTALL 5 BUTTON STATION IN VOM. WIRE TO RACK IN WILLIAMS CONTROL BOOTH.
- 5. IN EXISTING CONTROL RACK REPLACE EXISTING CONTROL PROCESSOR, RACK MOUNTED KEYBOARD, RACK MOUNTED MONITOR, DMX GATEWAY, NETWORK SWITCHES, NETWORK PATCHBAY, AND UPS WITH NEW EQUIPMENT PER SPECIFICATION. MAINTAIN PATCHBAY LABELING. MAINTAIN DRY LINES AND DMX REPEATERS.
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- 7. PROVIDE 10 BUTTON STATION AT THIS LOCATION TO REPLACE EXISTING PANEL. CONTROL WIRE TO RUN FROM HERE TO CONTROL RACK IN DOENGES BOOTH.
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- 11. VERIFY CONNECTION OF NEW PARADIGM PROCESSORS TO EXISTING HOUSE LIGHT AND PRODUCTION DIMMER RACKS. PROVIDE NETWORK INTERFACE OR DMX INTERFACE EQUIPMENT AS REQUIRED.
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ISSUE DATE:
01.24.2024

SHEET NUMBER:

TL103A
ORCHESTRA
FLOOR LEVEL
CHAPMAN

PROJECT:
PROJECT #
SP 23-2
TULSA
PERFORMING
ARTS CENTER -
PACKAGE No. 2
MECH., AV AND
THEATRICAL
LIGHTING
UPGRADES

PROJECT NUMBER:
202331.00

CONSULTANT:
 Schuler Shook

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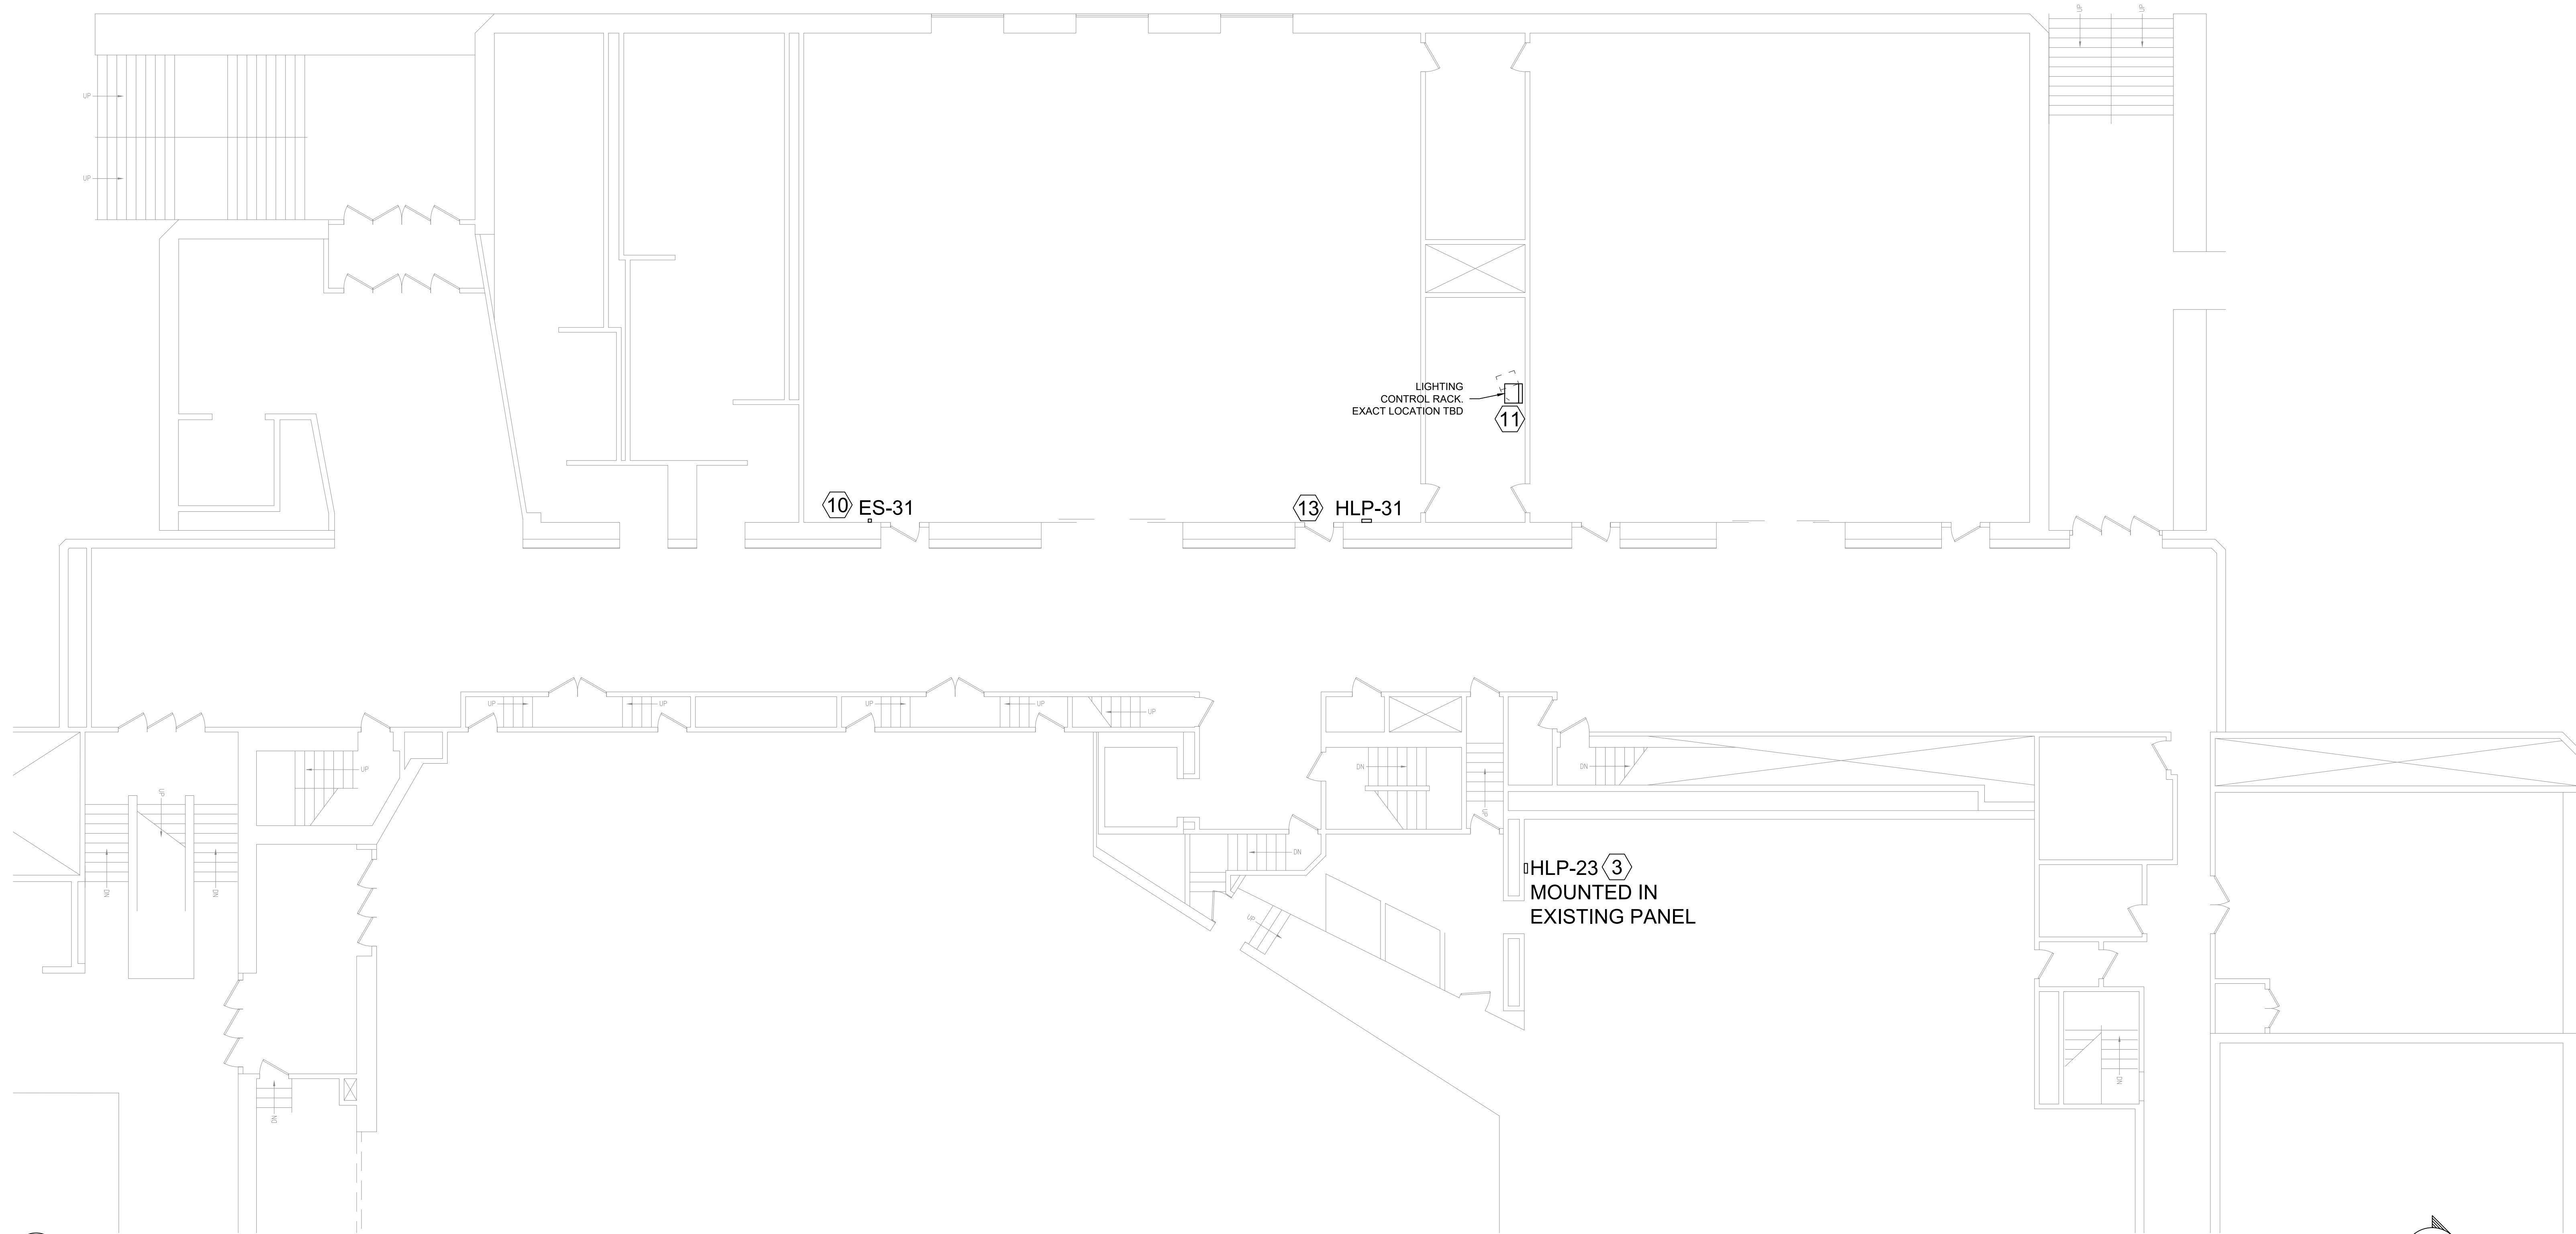
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2	95% REVIEW SET	12.19.2023
3	BID SET	01.24.2024

SEAL:

ISSUE DATE:
01.24.2024

SHEET NUMBER:
TL103B
ORCHESTRA
FLOOR LEVEL
PROMENADE



1 LEVEL 5 - PAVILION FLOOR LEVEL
TL103B / SCALE: 1/16" = 1'-0"

GENERAL NOTES:

- A. INSTALLATION SHALL CONFORM TO ALL APPLICABLE NEC, UL, STATE AND LOCAL CODES.
- B. ALL EMERGENCY EGRESS LIGHTING IS THE RESPONSIBILITY OF THE ELECTRICAL ENGINEER OR ELECTRICAL CONTRACTOR.
- C. ALL DIMMING CIRCUITS ARE TWO-WIRE. NO COMMON NEUTRALS SHALL BE USED.
- D. VERIFY ALL LOCATIONS OF WALL OR PANEL MOUNTED EQUIPMENT WITH OWNER AND DESIGN TEAM PRIOR TO INSTALLATION.

KEYED NOTES:

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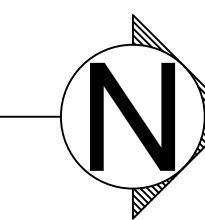
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1 LEVEL 8 - FOLLOWSPOT LEVEL
 TL105 SCALE: 1/16" = 1'-0"



GENERAL NOTES:

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PROJECT:
PROJECT #
SP 23-2
TULSA
PERFORMING
ARTS CENTER -
PACKAGE No. 2
MECH., AV AND
THEATRICAL
LIGHTING
UPGRADES

PROJECT NUMBER:
202331.00

CONSULTANT:
 THEATRE PLANNERS / LIGHTING DESIGNERS
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REVISIONS:

No	Description	Date
2	95% REVIEW SET	12.19.2023
3	BID SET	01.24.2024

SEAL:

ISSUE DATE:
01.24.2024

SHEET NUMBER:
TL105
FOLLOW SPOT
FLOOR LEVEL

THIS DRAWING INDICATES THEATRE EQUIPMENT LAYOUT AND DESIGN OF THEATRE SYSTEMS. REVIEW BY A QUALIFIED ENGINEER IS NECESSARY TO ASSURE SAFETY AND CODE COMPLIANCE.

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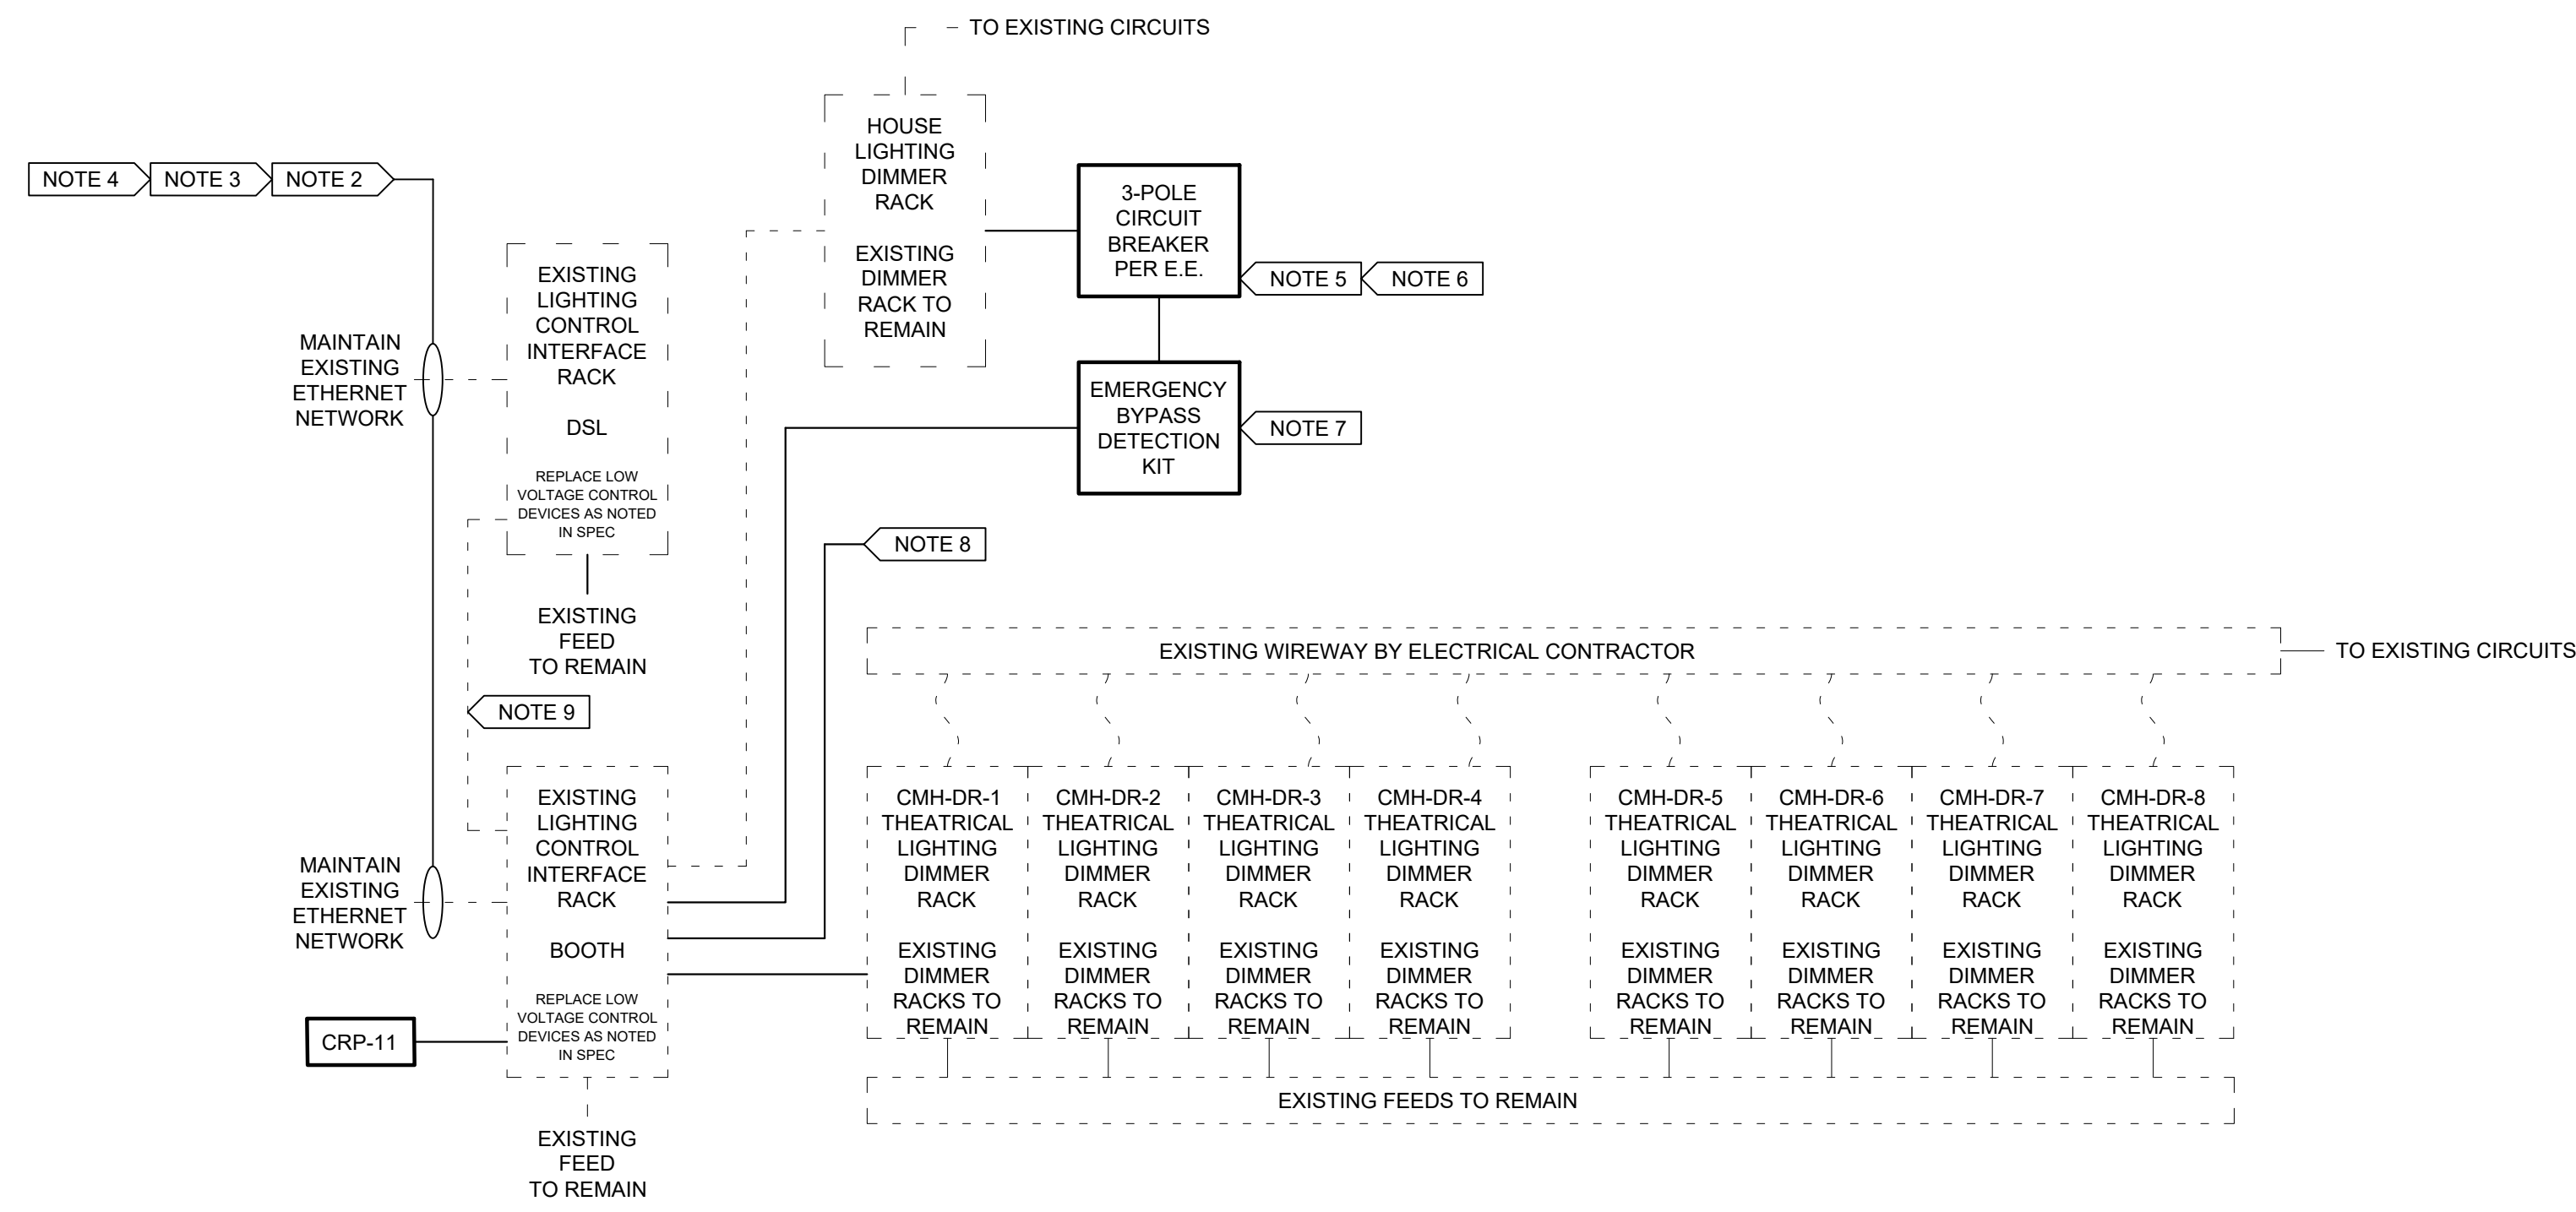


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THEATRICAL LIGHTING SYSTEM NOTES:


1. ALL DEVICES SHALL BE PROVIDED BY THEATRICAL LIGHTING MANUFACTURER UNLESS OTHERWISE NOTED.
2. ELECTRICAL CONTRACTOR SHALL PROVIDE AND INSTALL ALL CONTROL WIRING. CONTROL WIRING REQUIREMENTS VARY GREATLY AMONG MANUFACTURERS. ELECTRICAL CONTRACTOR SHALL OBTAIN CONTROL WIRING REQUIREMENTS FROM THEATRICAL LIGHTING MANUFACTURER PRIOR TO BID. ELECTRICAL CONTRACTOR SHALL OBTAIN SHOP DRAWINGS FROM THEATRICAL LIGHTING MANUFACTURER PRIOR TO SIZING OR ROUTING ANY CONTROL SYSTEM CONDUITS.
3. ALL NETWORK AND / OR DMX WIRING RUNS SHALL BE CONTINUOUS AND WITHOUT BREAKS OR SPLICES.
4. ALL NETWORK WIRING RUNS SHALL BE CATEGORY 5E, 100 BASE T AND CONFORM TO THE PLASA (PROFESSIONAL LIGHTING AND SOUND ASSOCIATION) RECOMMENDED PRACTICE FOR ETHERNET CABLING IN ENTERTAINMENT LIGHTING APPLICATIONS.
5. ELECTRICAL CONTRACTOR SHALL PROVIDE CONTACT CLOSURE FROM FIRE ALARM SYSTEM. FIRE ALARM ACTIVATION MAY BE USED TO BRING SELECTED ARCHITECTURAL LIGHTING CIRCUITS TO FULL INTENSITY ONLY WHEN THE NORMAL POWER SOURCE HAS NOT BEEN INTERRUPTED.
6. ELECTRICAL CONTRACTOR SHALL PROVIDE CONTACT CLOSURE FROM EMERGENCY POWER SYSTEM. EMERGENCY POWER SYSTEM ACTIVATION MAY BE USED TO BRING SELECTED ARCHITECTURAL LIGHTING CIRCUITS TO FULL INTENSITY ONLY WHEN THE EMERGENCY POWER SOURCE IS PRESENT.
7. ELECTRICAL CONTRACTOR SHALL PROVIDE 3-PHASE, 4-WIRE 20AMP MAXIMUM SENSE FEED FROM NORMAL POWER SOURCE IDENTIFIED BY ELECTRICAL ENGINEER. LOSS OF ANY PHASE OF SENSE FEED SHALL CAUSE EMERGENCY LIGHTING TRANSFER SWITCH (ELTS) TO ACTIVATE EMERGENCY OPERATION. EMERGENCY POWER SOURCE MUST ALSO BE PRESENT AT ELTS FOR EMERGENCY OPERATION.
8. ELECTRICAL CONTRACTOR SHALL PROVIDE ONE (1) DMX CONTROL WIRING OUTPUT TO EACH ARCHITECTURAL LIGHTING FIXTURE TYPE REQUIRING DMX CONTROL. THEATRICAL LIGHTING MANUFACTURER SHALL PROVIDE DMX OUTPUT DEVICE(S) AT CONTROL INTERFACE RACK. ARCHITECTURAL LIGHTING MANUFACTURER SHALL PROVIDE DMX CONTROL INPUT INTERFACE(S) AS REQUIRED FOR ALL FIXTURES. COORDINATE EXACT REQUIREMENTS WITH ALL MANUFACTURERS TO ASSURE A COMPLETE AND OPERABLE SYSTEM.
9. MAINTAIN EXISTING DMX DRYLINES BETWEEN CONTROL RACKS.



1 CHAPMAN MUSIC HALL LIGHTING CONTROL RISER DIAGRAM
TL500 / SCALE: NO SCALE

THEATRICAL LIGHTING SYSTEM NOTES:


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6. ELECTRICAL CONTRACTOR SHALL PROVIDE CONTACT CLOSURE FROM EMERGENCY POWER SYSTEM. EMERGENCY POWER SYSTEM ACTIVATION MAY BE USED TO BRING SELECTED ARCHITECTURAL LIGHTING CIRCUITS TO FULL INTENSITY ONLY WHEN THE EMERGENCY POWER SOURCE IS PRESENT.
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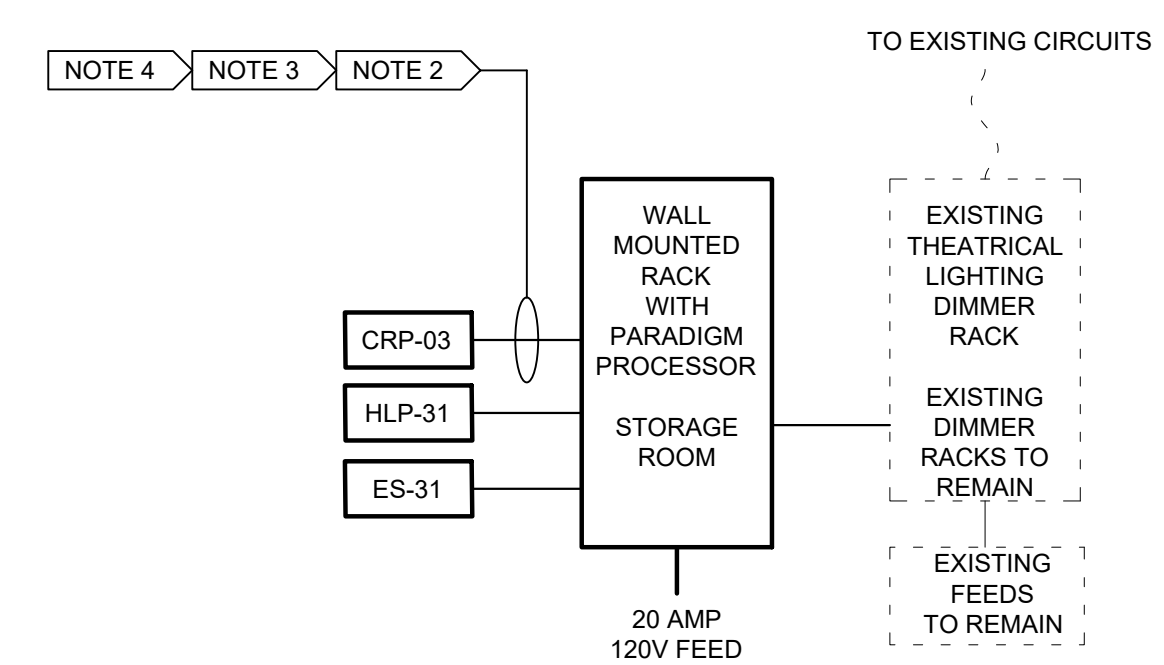
2 WILLIAMS THEATER LIGHTING CONTROL RISER DIAGRAM
TL500 / SCALE: NO SCALE

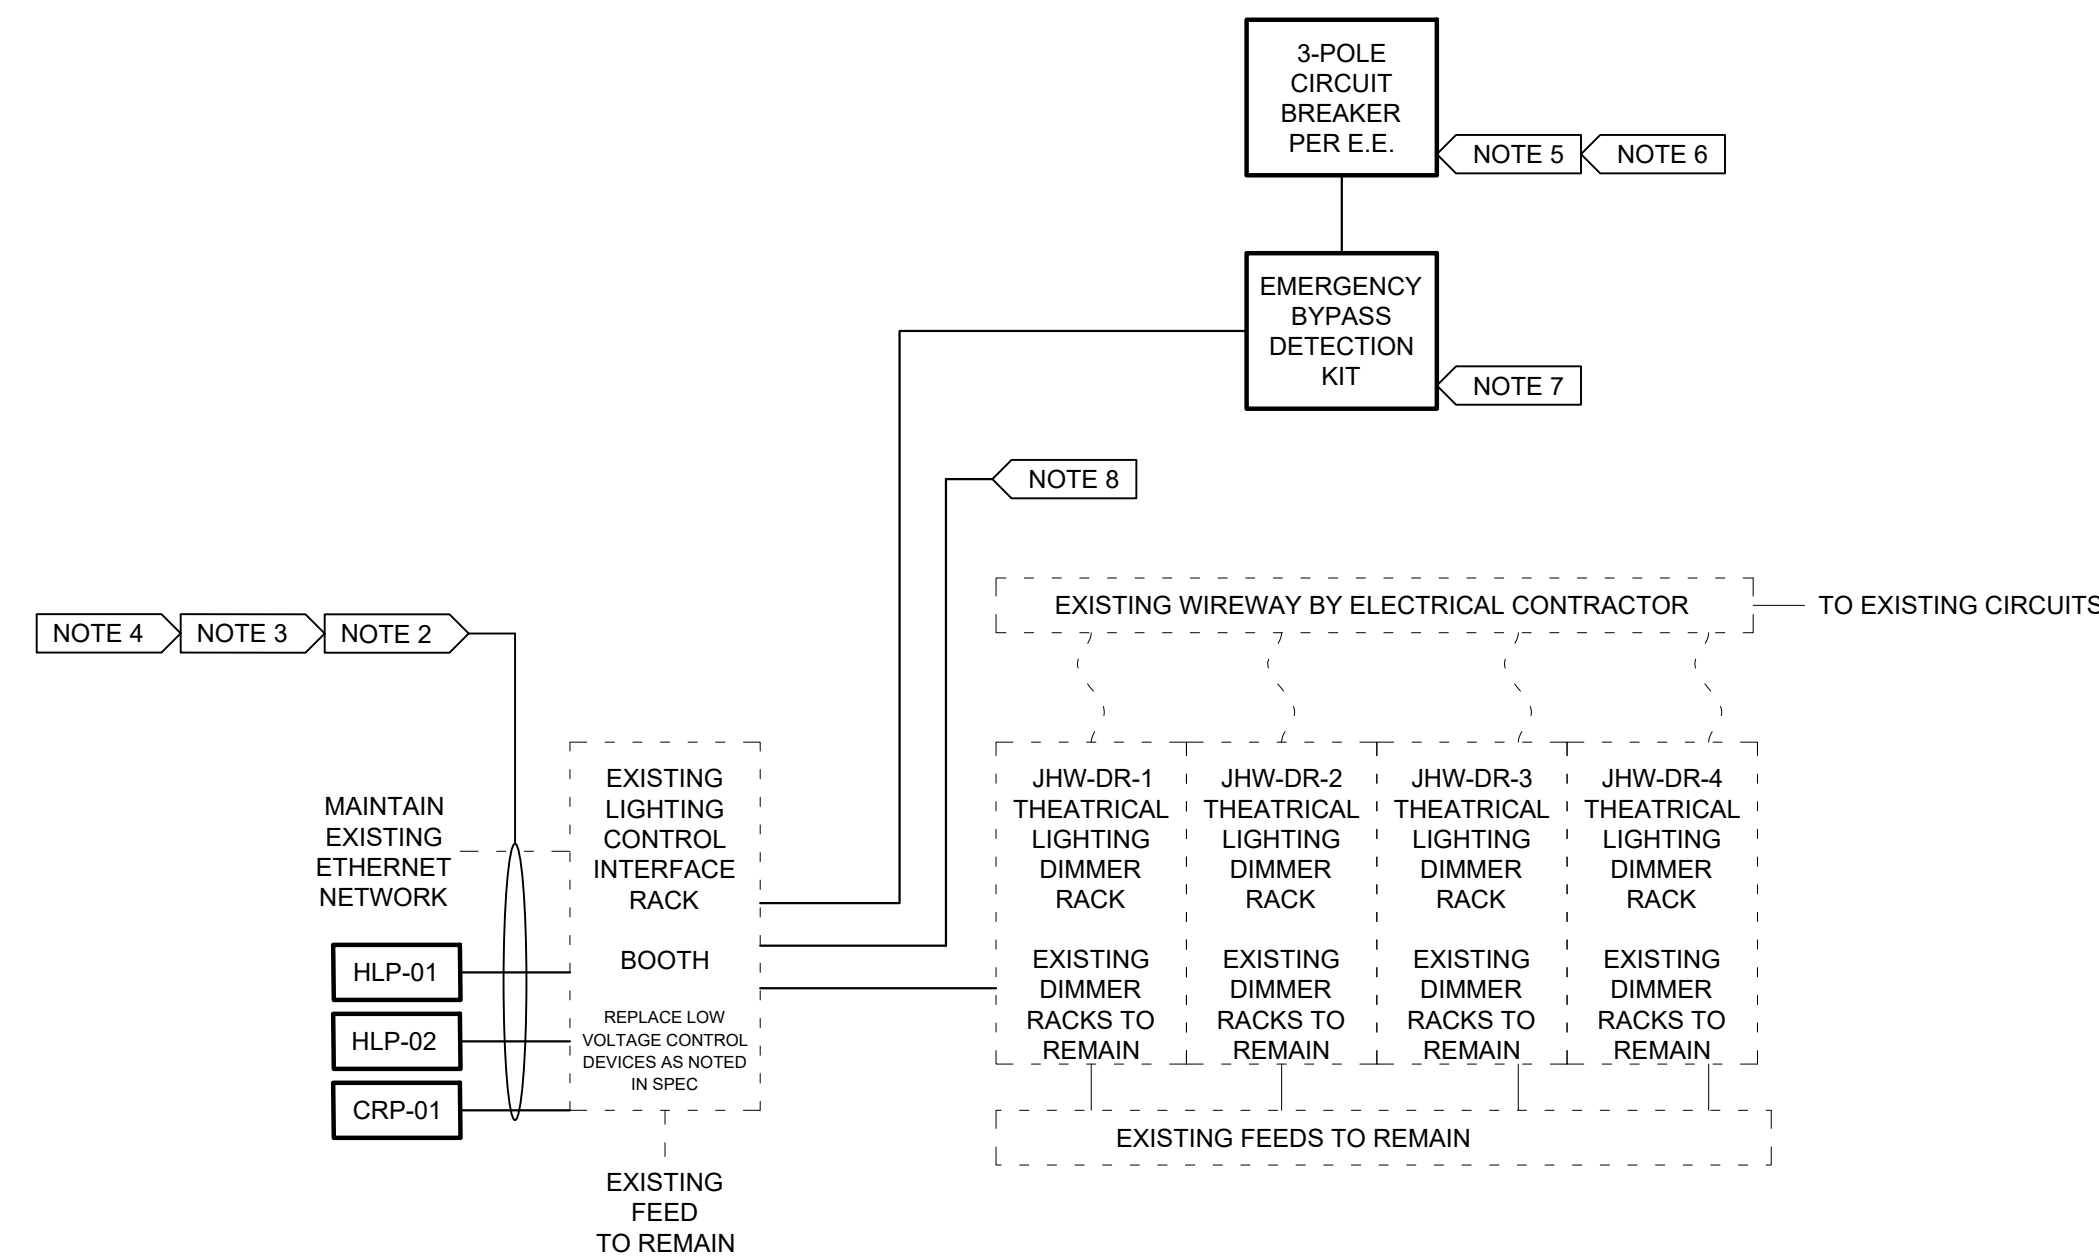THEATRICAL LIGHTING SYSTEM NOTES:

1. ALL DEVICES SHALL BE PROVIDED BY THEATRICAL LIGHTING MANUFACTURER UNLESS OTHERWISE NOTED.
2. ELECTRICAL CONTRACTOR SHALL PROVIDE AND INSTALL ALL CONTROL WIRING. CONTROL WIRING REQUIREMENTS VARY GREATLY AMONG MANUFACTURERS. ELECTRICAL CONTRACTOR SHALL OBTAIN CONTROL WIRING REQUIREMENTS FROM THEATRICAL LIGHTING MANUFACTURER PRIOR TO BID. ELECTRICAL CONTRACTOR SHALL OBTAIN SHOP DRAWINGS FROM THEATRICAL LIGHTING MANUFACTURER PRIOR TO SIZING OR ROUTING ANY CONTROL SYSTEM CONDUITS.
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9. LOCATE PARADIGM PROCESSOR IN DOENGES THEATRE CONTROL RACK. PROCESSOR WILL CONTROL BOTH DOENGES AND NORMAN HOUSE LIGHT SYSTEMS.



3 DOENGES AND NORMAN LIGHTING CONTROL RISER DIAGRAM
TL500 / SCALE: NO SCALE

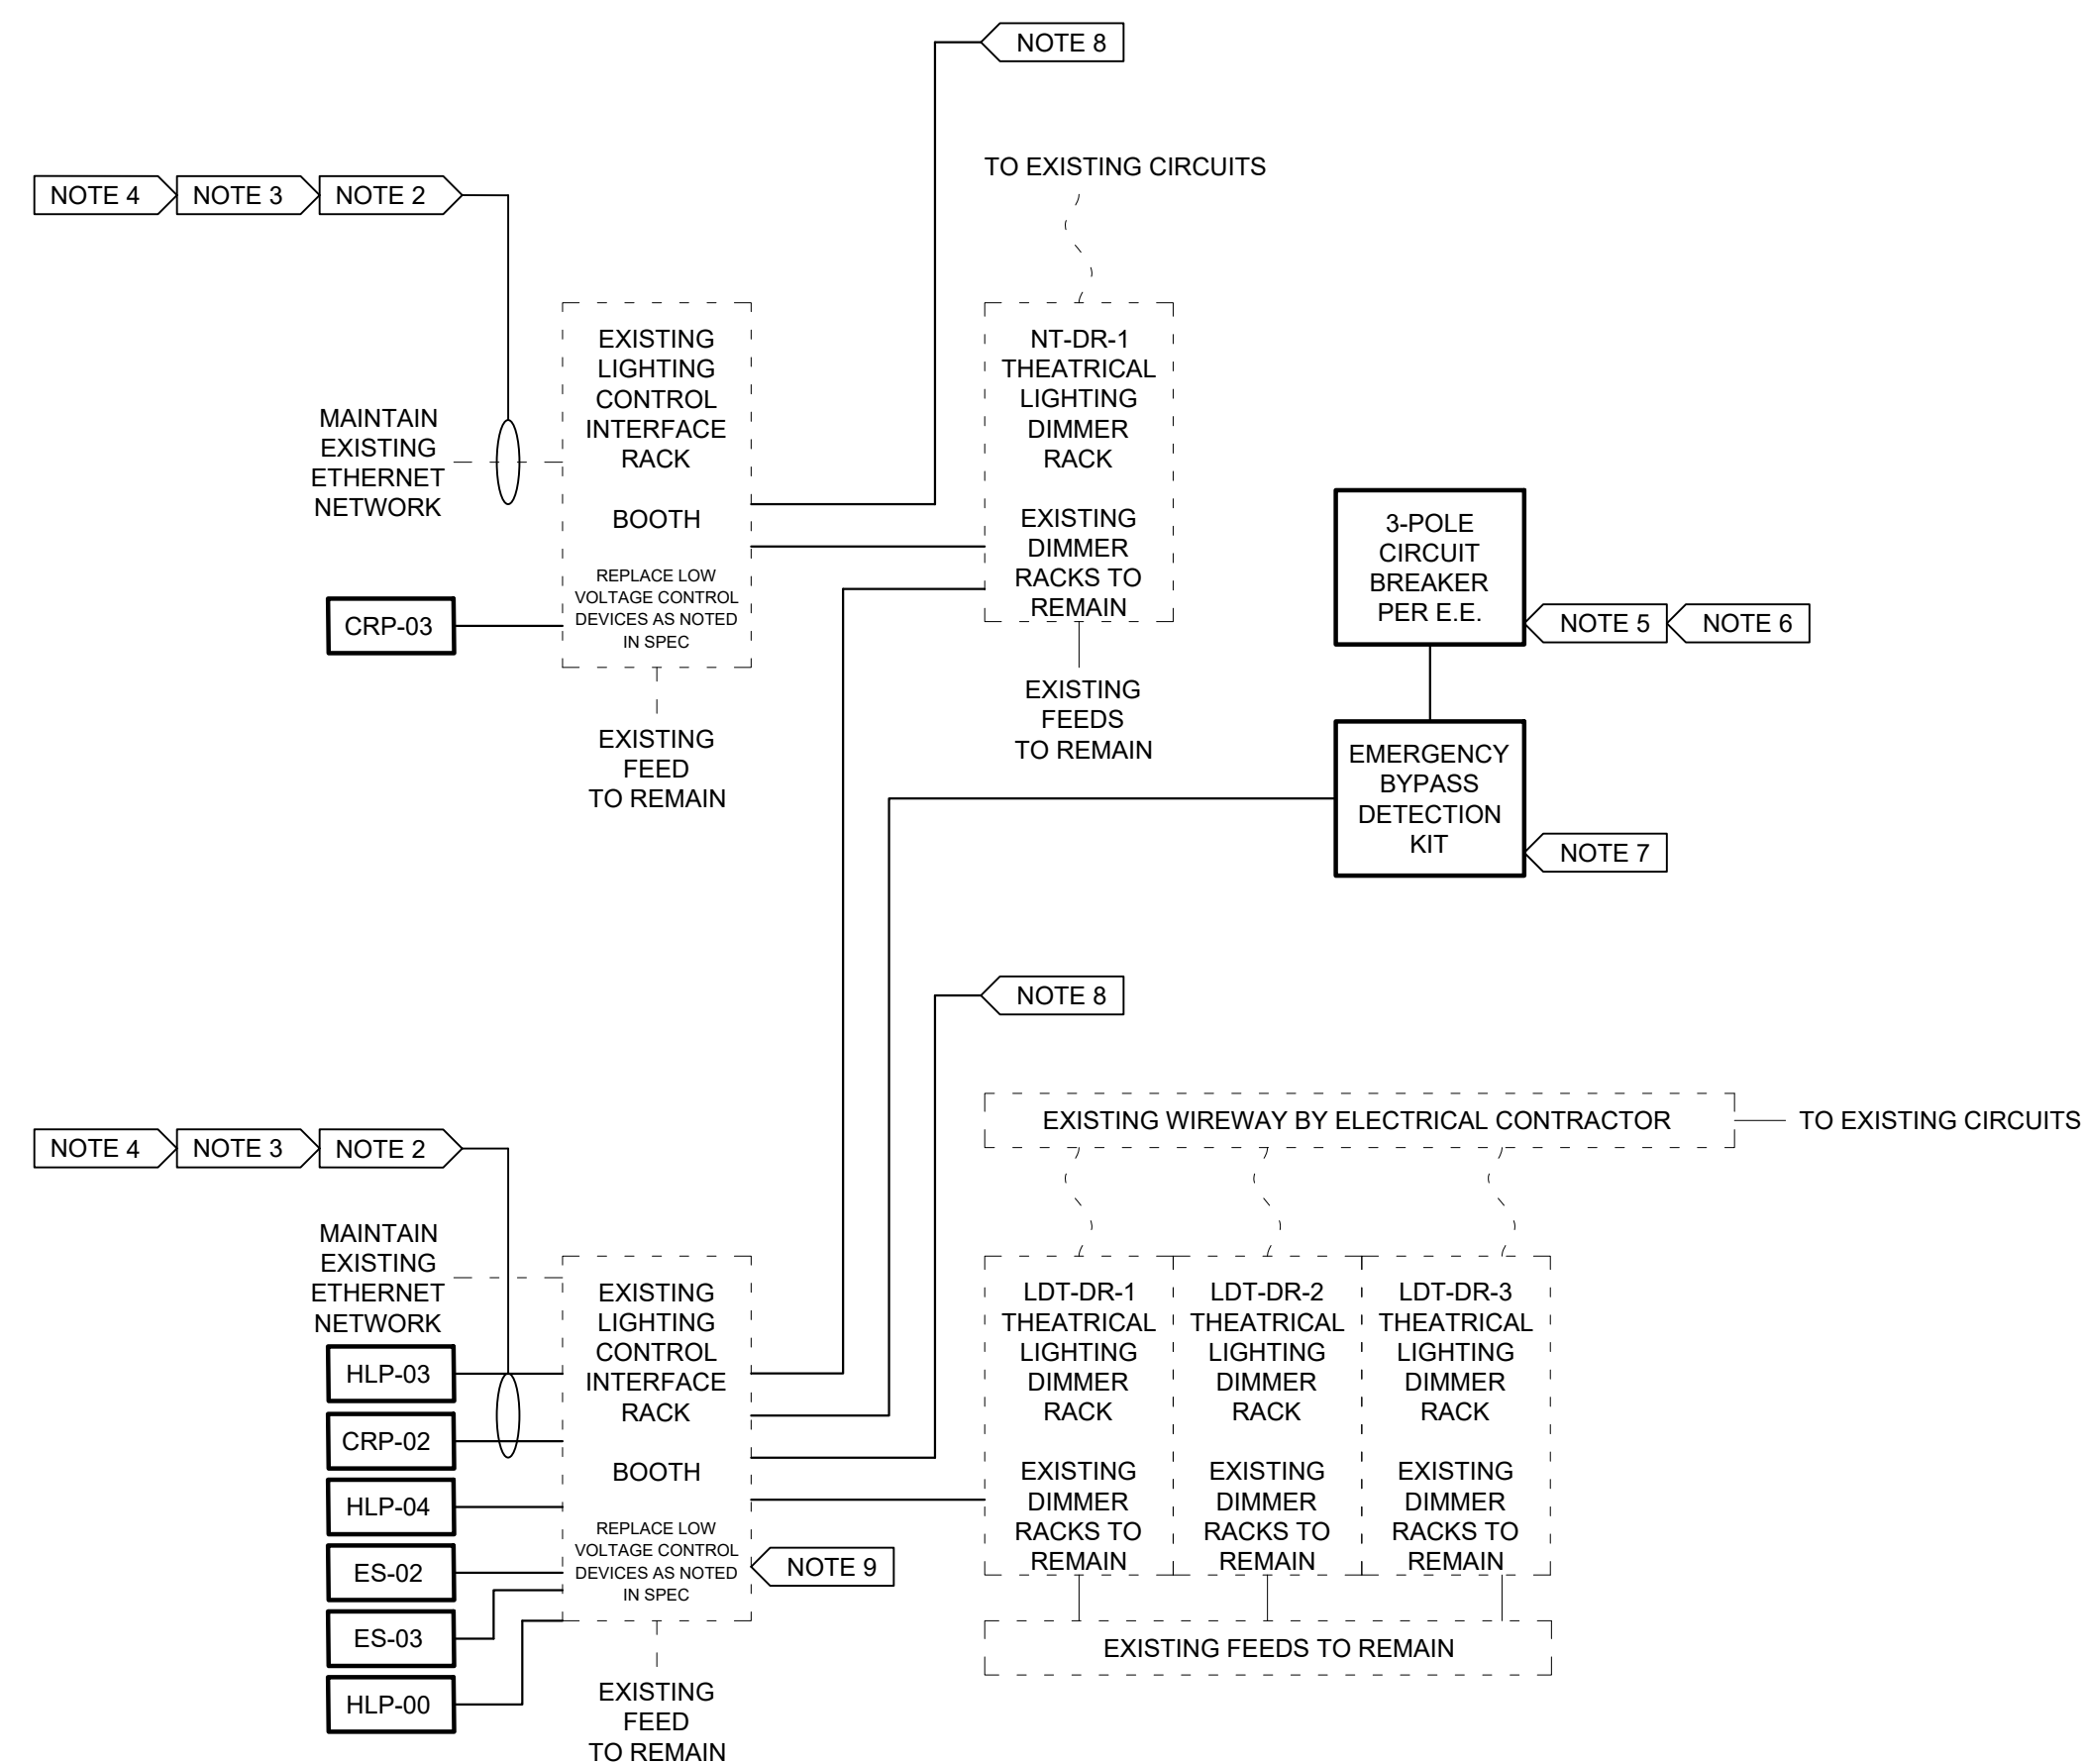

THEATRICAL LIGHTING SYSTEM NOTES:

1. ALL DEVICES SHALL BE PROVIDED BY THEATRICAL LIGHTING MANUFACTURER UNLESS OTHERWISE NOTED.
2. ELECTRICAL CONTRACTOR SHALL PROVIDE AND INSTALL ALL CONTROL WIRING. CONTROL WIRING REQUIREMENTS VARY GREATLY AMONG MANUFACTURERS. ELECTRICAL CONTRACTOR SHALL OBTAIN CONTROL WIRING REQUIREMENTS FROM THEATRICAL LIGHTING MANUFACTURER PRIOR TO BID. ELECTRICAL CONTRACTOR SHALL OBTAIN SHOP DRAWINGS FROM THEATRICAL LIGHTING MANUFACTURER PRIOR TO SIZING OR ROUTING ANY CONTROL SYSTEM CONDUITS.
3. ALL NETWORK AND / OR DMX WIRING RUNS SHALL BE CONTINUOUS AND WITHOUT BREAKS OR SPLICES.
4. ALL NETWORK WIRING RUNS SHALL BE CATEGORY 5E, 100 BASE T AND CONFORM TO THE PLASA (PROFESSIONAL LIGHTING AND SOUND ASSOCIATION) RECOMMENDED PRACTICE FOR ETHERNET CABLING IN ENTERTAINMENT LIGHTING APPLICATIONS.

4 WESTBY THEATER LIGHTING CONTROL RISER DIAGRAM
TL500 / SCALE: NO SCALE

PROJECT:
PROJECT #
SP 23-2
TULSA
PERFORMING
ARTS CENTER -
PACKAGE No. 2
MECH., AV AND
THEATRICAL
LIGHTING
UPGRADES

PROJECT NUMBER:
202331.00

CONSULTANT:
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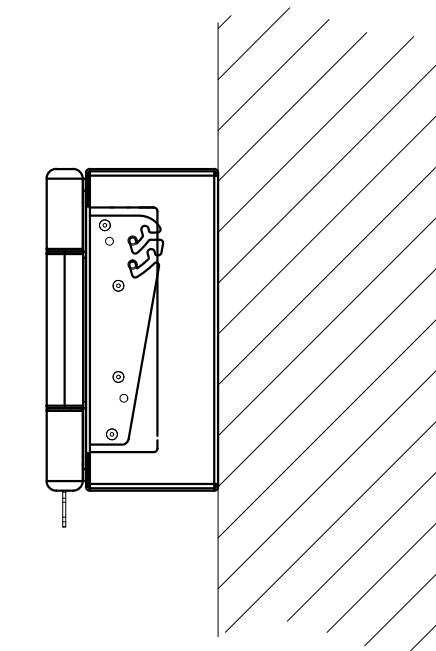
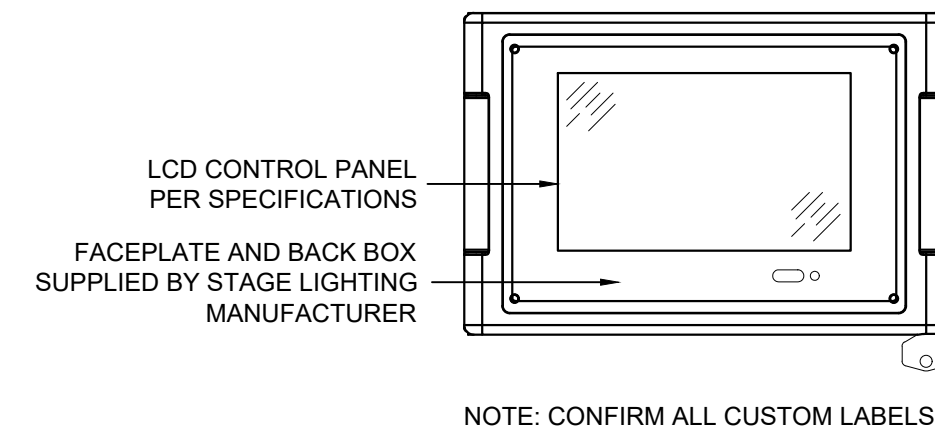
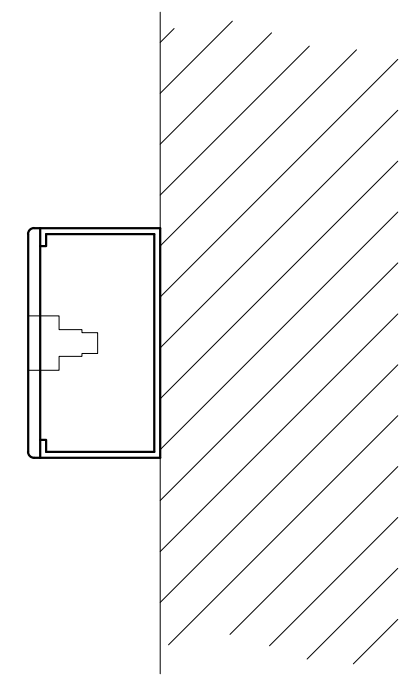
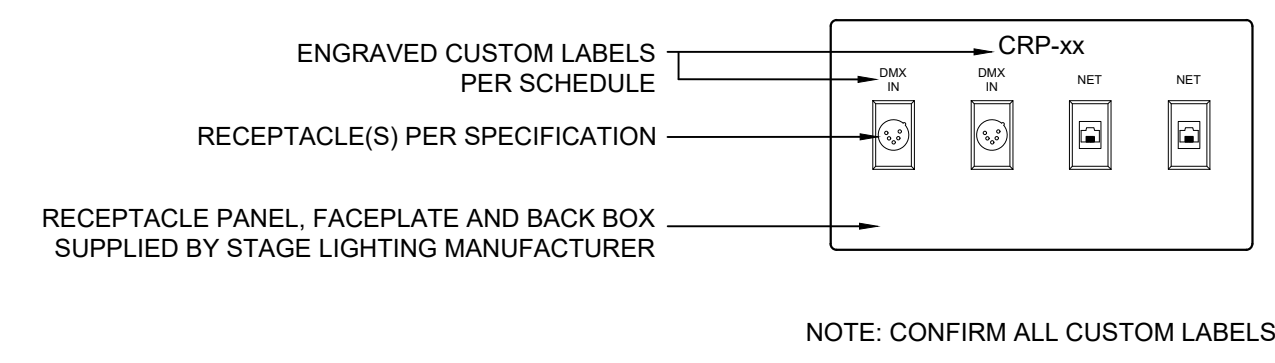
REVISIONS:

No	Description	Date
2	95% REVIEW SET	12.19.2023
3	BID SET	01.24.2024

SEAL:

ISSUE DATE:
01.24.2024

SHEET NUMBER:
TL500
RISER DIAGRAMS



DEVICE NUMBER AND DESCRIPTION	DMX NODE INPUT	DMX NODE OUTPUT	ETHERNET	FINISH COLOR	MOUNTING	NUMBER OF BACK BOXES	REMARKS
CRP-01 WILLIAMS BOOTH	2		2	BLACK	SURFACE	1	WALL MOUNT - EXACT LOCATION TBD
CRP-02 DOENGES BOOTH	2		2	BLACK	SURFACE	1	WALL MOUNT - EXACT LOCATION TBD
CRP-03 NORMAN BOOTH	2		2	BLACK	SURFACE	1	WALL MOUNT - EXACT LOCATION TBD
CRP - 11 CHAPMAN BOOTH	2		2	BLACK	SURFACE	1	WALL MOUNT - EXACT LOCATION TBD
CRP - 12 CHAPMAN SL	2		2	BLACK	RACK	3	REPLACE SINGLE GANG UNLABELED ETHERNET PORT WITH LABELED CRP





THIS DRAWING INDICATES THEATRE EQUIPMENT LAYOUT AND DESIGN OF THEATRE SYSTEMS. REVIEW BY A QUALIFIED ENGINEER IS NECESSARY TO ASSURE SAFETY AND CODE COMPLIANCE.

REFER TO E-SERIES DRAWINGS FOR ELECTRICAL FEEDS, DISCONNECT SWITCHES, CONDUIT, AND WIRE FOR ALL RIGGING EQUIPMENT. DIVISION 26 CONTRACTOR SHALL PROVIDE AND INSTALL ALL ELECTRICAL EQUIPMENT AND CONTROL WIRING FOR A COMPLETE AND OPERABLE SYSTEM.

1 TYPICAL CONTROL RECEPTACLE PANEL - (CRP)
TL501 SCALE: NO SCALE

4 TYPICAL SURFACE MOUNTED HOUSE LIGHT PANEL - (HLP)
TL501 SCALE: NO SCALE

7 CONTROL RECEPTACLE PANEL SCHEDULE
TL501 SCALE: NO SCALE

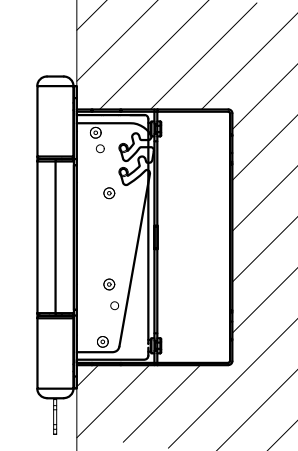
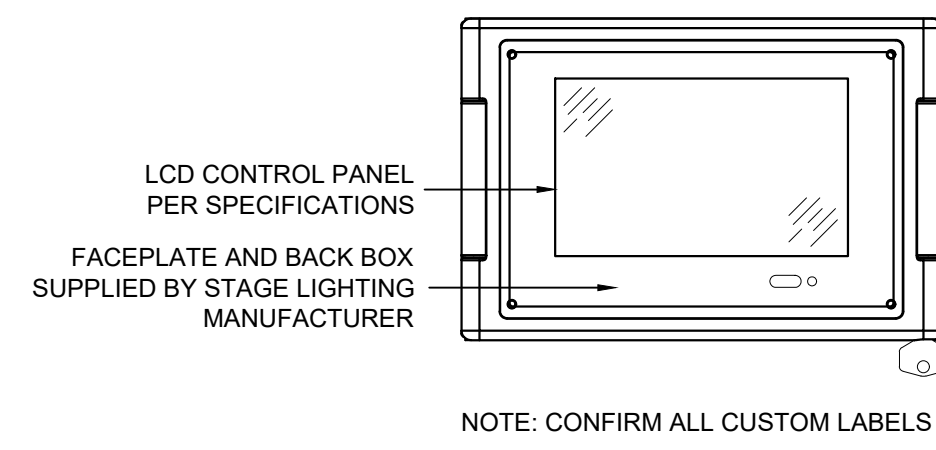
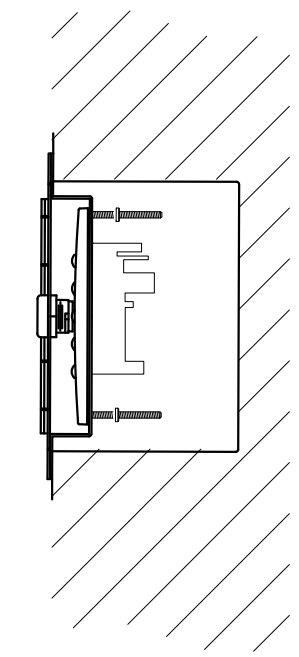
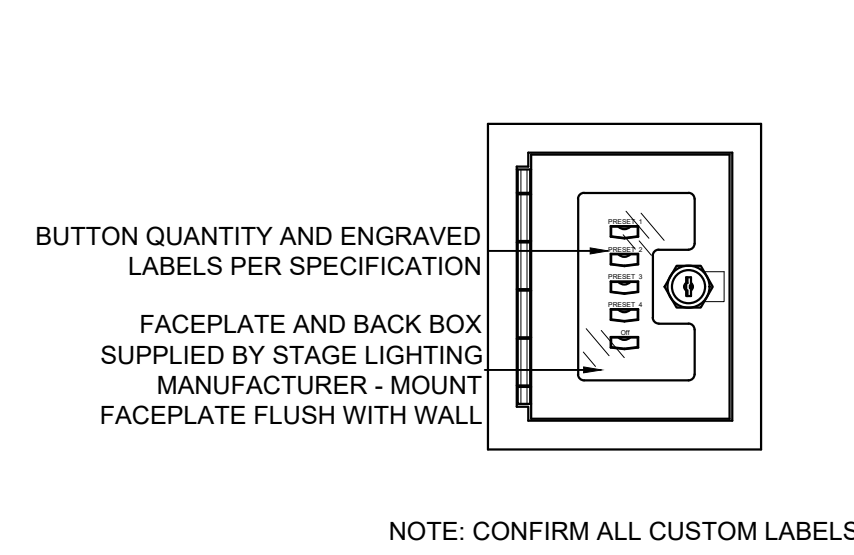


DEVICE NUMBER AND DESCRIPTION	NUMBER OF PRESETS	PRESET LABELS	OPERATION	FINISH COLOR	LOCKING COVER	MOUNTING	REMARKS
ES-01 WILLIAMS VESTIBULE	5	1. TBD 2. TBD 3. TBD 4. TBD 5. OFF		BLACK	YES	SURFACE	
ES-02 DOENGES VESTIBULE	10	1. TBD 2. TBD 3. TBD 4. TBD 5. TBD 6. TBD 7. TBD 8. TBD 9. TBD 10. OFF		PER ARCHITECT	YES	SURFACE	REPLACE EXISTING PANEL
ES-03 NORMAN VESTIBULE	5	1. TBD 2. TBD 3. TBD 4. TBD 5. TBD 6. TBD 7. TBD 8. TBD 9. TBD 10. OFF		PER ARCHITECT	YES	SURFACE	NEW CONTROL STATION - WIRE FROM ES-02
ES-31 WESTBY	5	1. TBD 2. TBD 3. TBD 4. TBD 5. OFF		PER ARCHITECT	YES	RECESSED	REPLACE EXISTING BUTTON STATION
HLP-00 WILLIAMS		LCD CONTROL PANEL PER SPECIFICATION		BLACK		WALL	REPLACE EXISTING CONTROL PANEL
HLP-01 DOENGES CORRIDOR		LCD CONTROL PANEL PER SPECIFICATION		BLACK		WALL	REPLACE EXISTING CONTROL PANEL
HLP-02 PORTABLE WILLIAMS		LCD CONTROL PANEL PER SPECIFICATION		BLACK		PORTABLE	REPLACE EXISTING CONTROL PANEL
HLP-03 DOENGES BOOTH		LCD CONTROL PANEL PER SPECIFICATION		BLACK		PANEL MOUNT	REPLACE EXISTING CONTROL PANEL
HLP-04 NORMAN BOOTH		LCD CONTROL PANEL PER SPECIFICATION		BLACK		PANEL MOUNT	REPLACE EXISTING CONTROL PANEL
HLP-21 CHAPMAN BOOTH		LCD CONTROL PANEL PER SPECIFICATION		BLACK		PANEL MOUNT	REPLACE EXISTING CONTROL PANEL
HLP-22 CHAPMAN SL		LCD CONTROL PANEL PER SPECIFICATION		BLACK		PANEL MOUNT	REPLACE EXISTING CONTROL PANEL
HLP-23 CHAPMAN SR		LCD CONTROL PANEL PER SPECIFICATION		BLACK		PANEL MOUNT	REPLACE EXISTING CONTROL PANEL
HLP-24 PORTABLE CHAPMAN		LCD CONTROL PANEL PER SPECIFICATION		BLACK		PORTABLE	DELIVER TO OWNER
HLP-31 WESTBY		LCD CONTROL PANEL PER SPECIFICATION		PER ARCHITECT		WALL MOUNT	REPLACE EXISTING CONTROL PANEL

2 TYPICAL 5-BUTTON ENTRY STATION - (ES)
TL501 SCALE: NO SCALE

5 TYPICAL RECESSED OR PANEL MOUNTED HOUSE LIGHT PANEL - (HLP)
TL501 SCALE: NO SCALE

8 ENTRY STATION AND HOUSELIGHT PANEL SCHEDULE
TL501 SCALE: NO SCALE

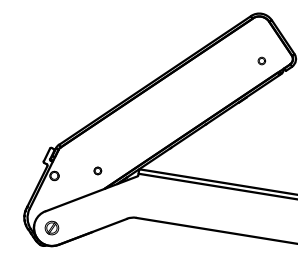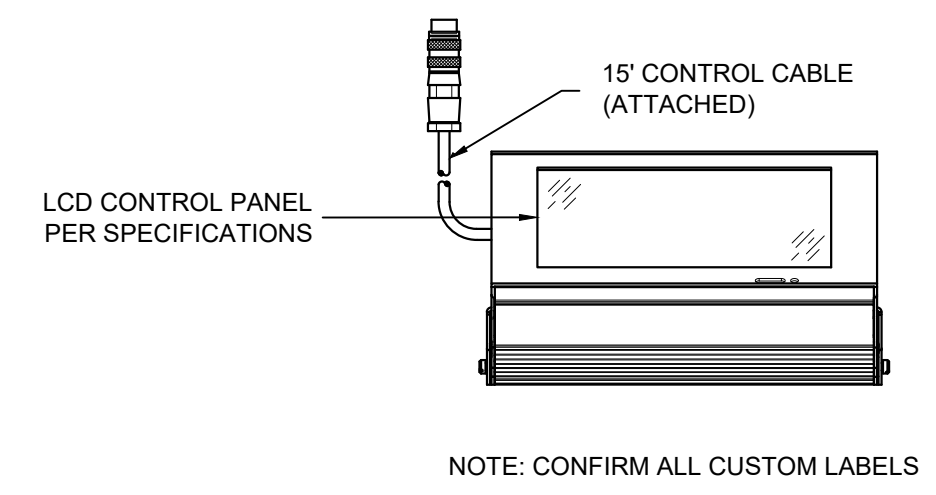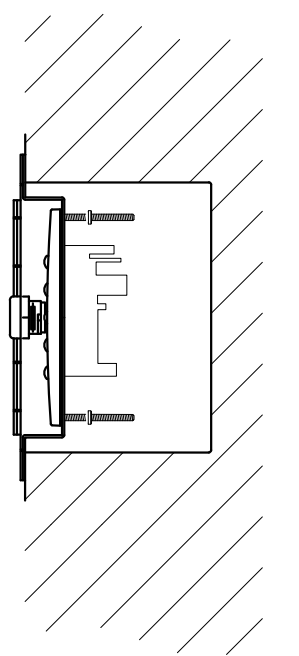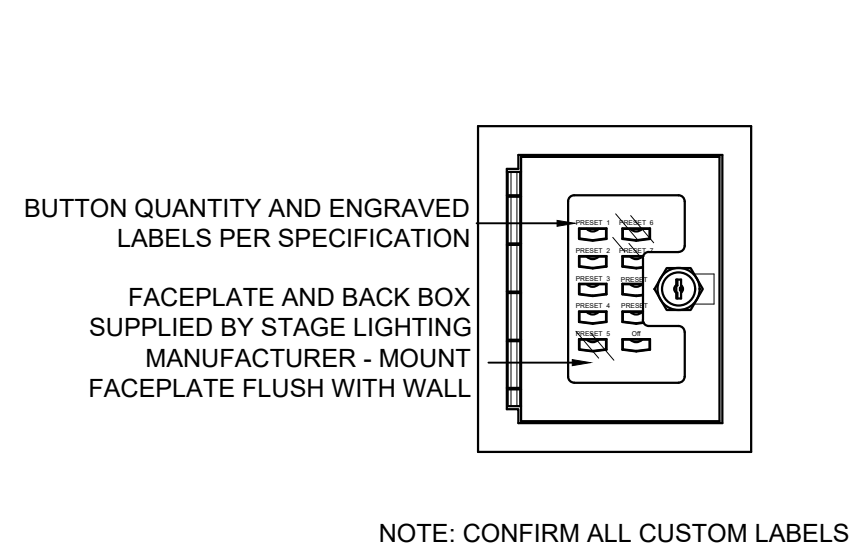

3 TYPICAL 10-BUTTON ENTRY STATION - (ES)
TL501 SCALE: NO SCALE

6 TYPICAL PORTABLE HOUSE LIGHT PANEL - (HLP)
TL501 SCALE: NO SCALE



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DETAILS


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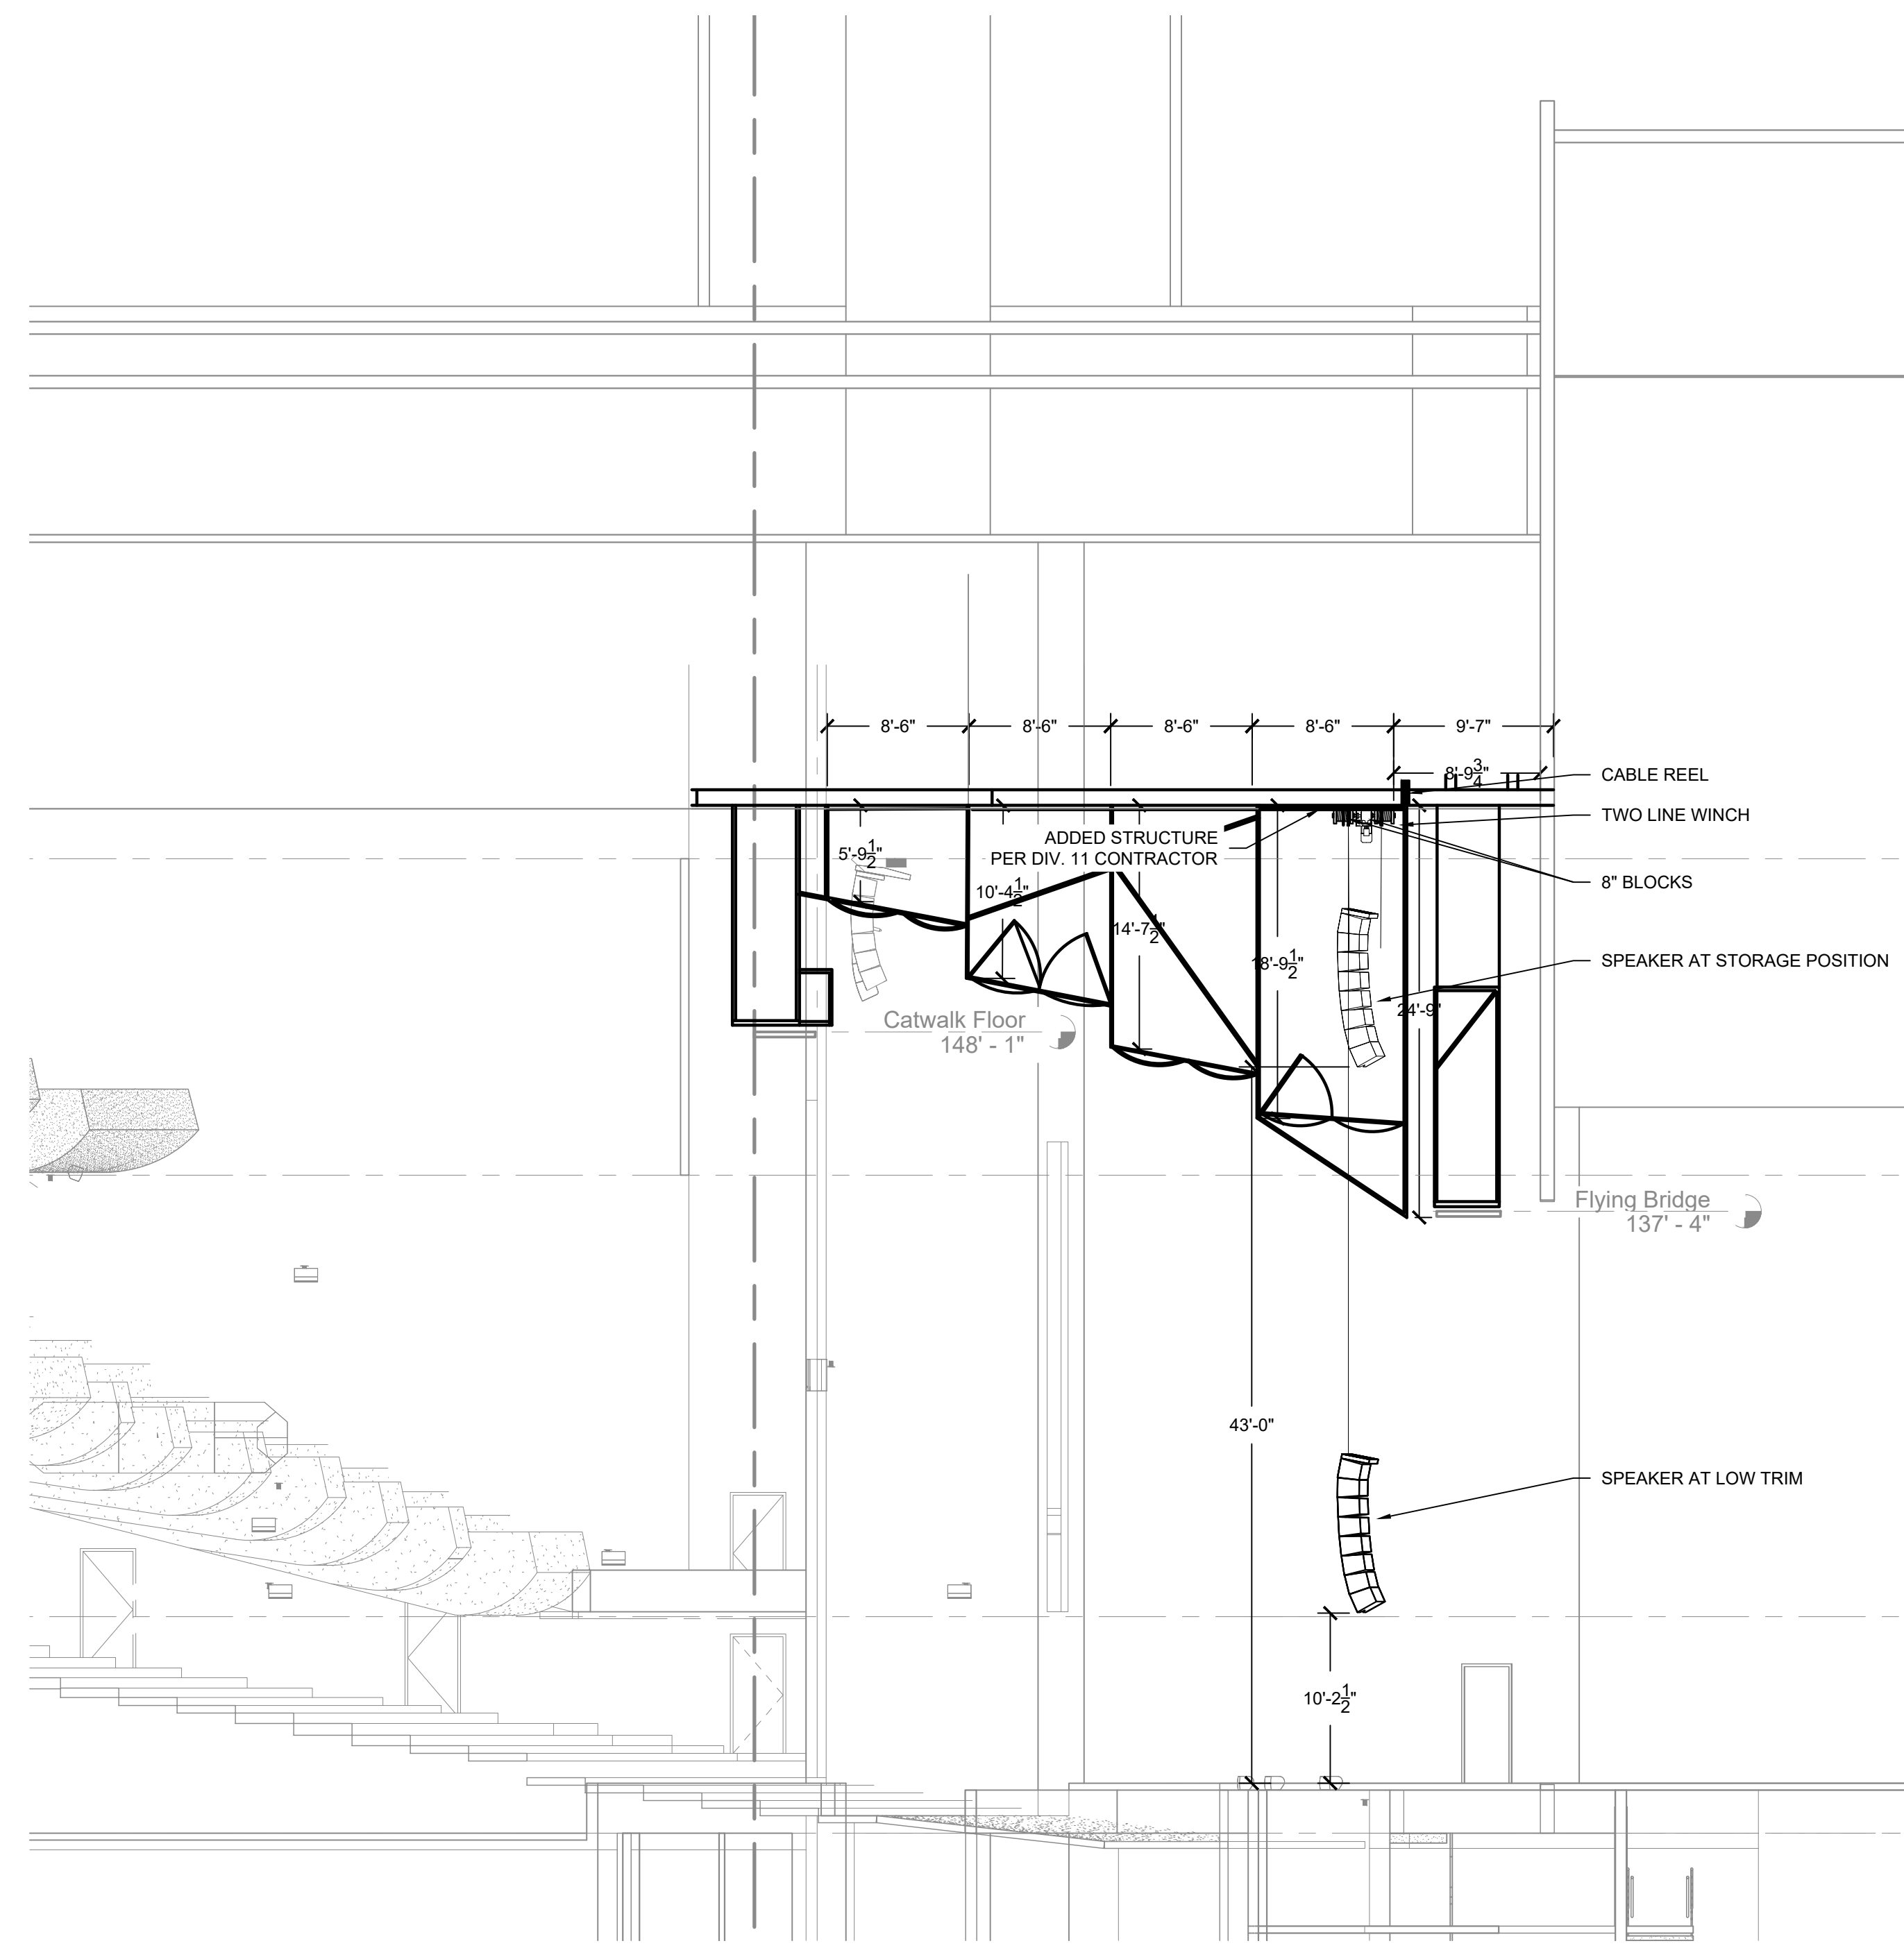
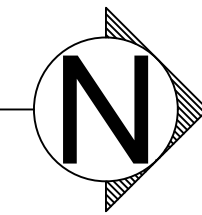


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1 CHAPMAN SPEAKER RIGGING
SCALE: 1/8" = 1'-0"



2 SECTION AT SPEAKER RIGGING
SCALE: 1/8" = 1'-0"

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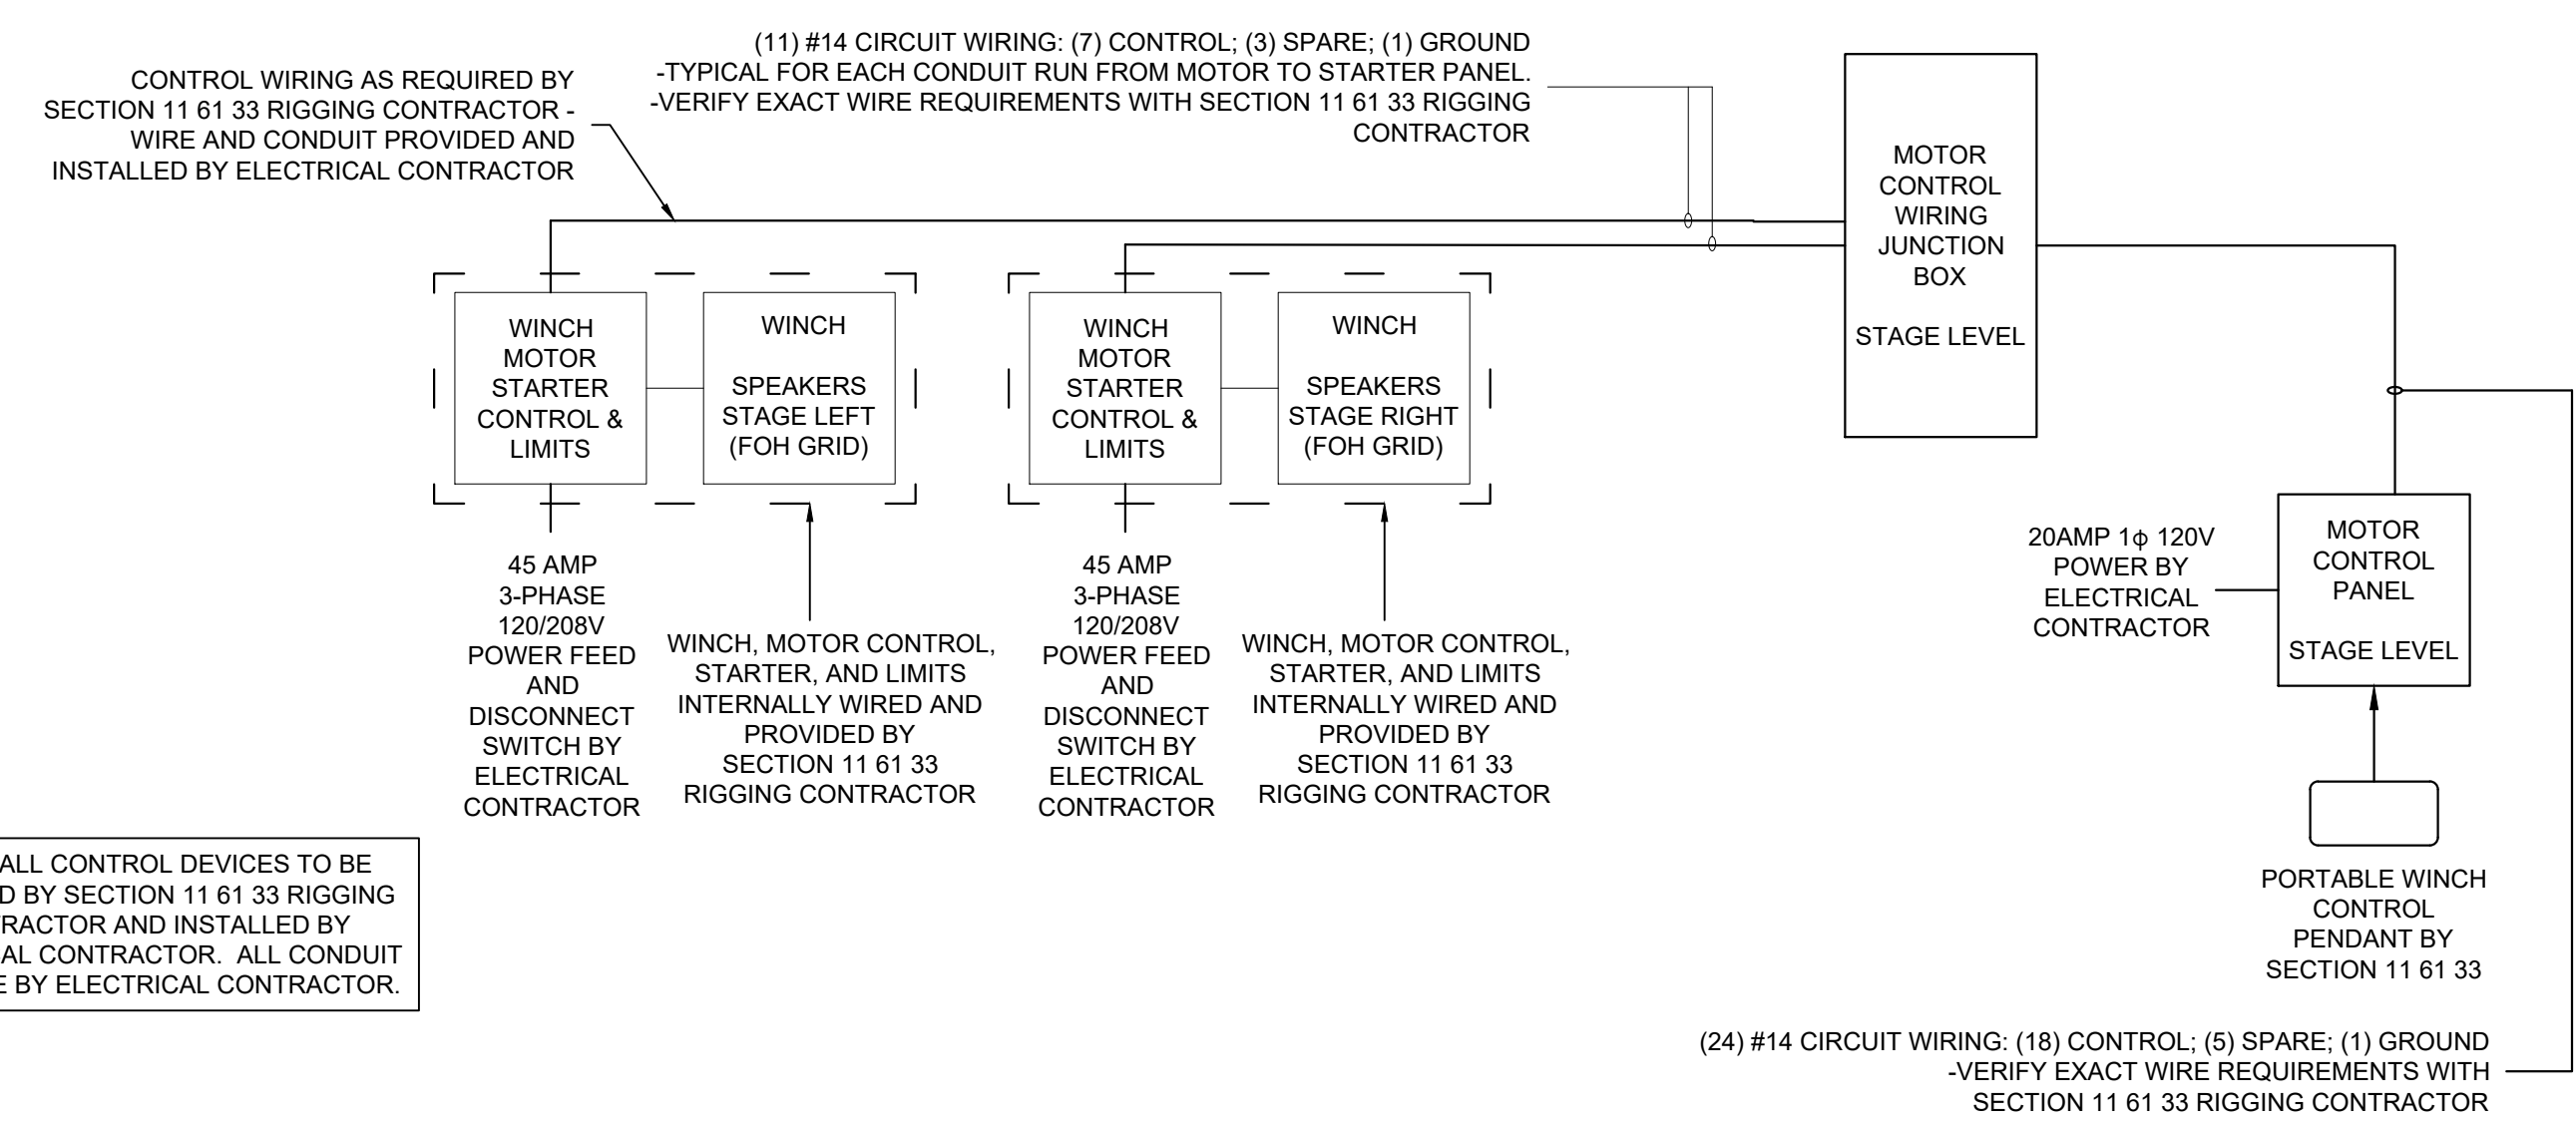
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SHEET NUMBER:
TR101
CHAPMAN
SPEAKER RIGGING

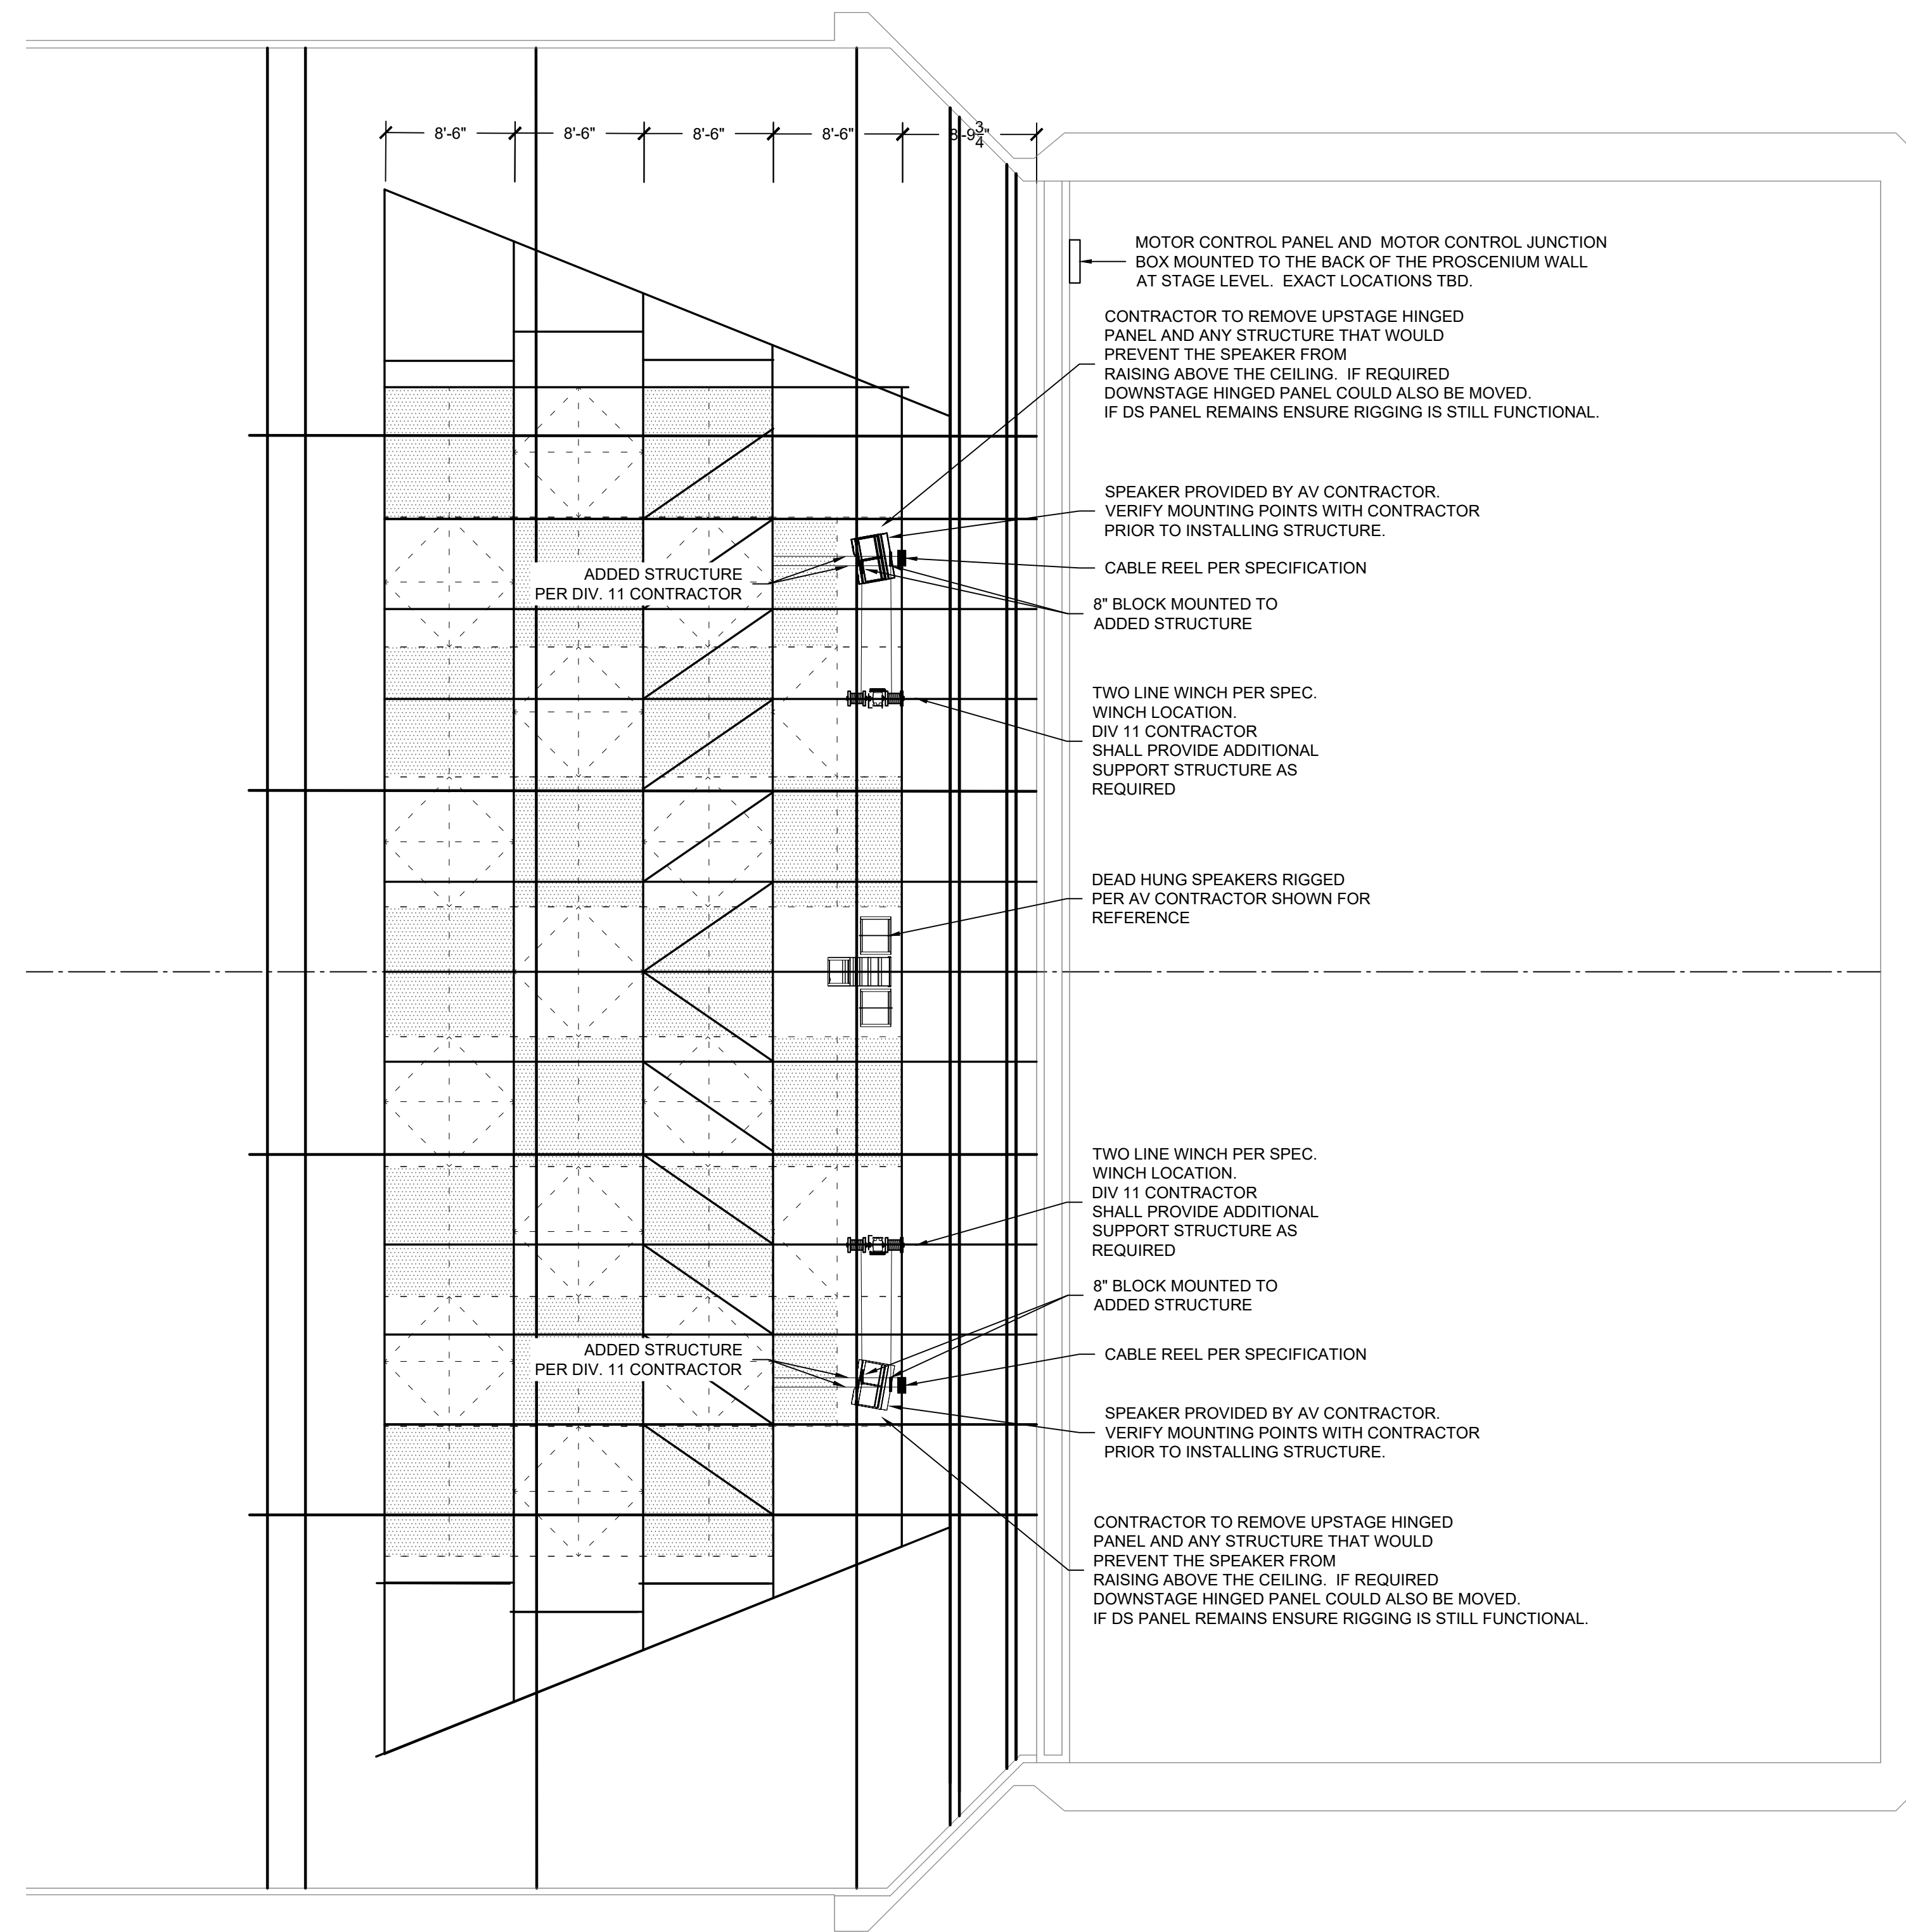

NOTE: ALL CONTROL DEVICES TO BE PROVIDED BY SECTION 11 61 33 RIGGING CONTRACTOR AND INSTALLED BY ELECTRICAL CONTRACTOR. ALL CONDUIT AND WIRE BY ELECTRICAL CONTRACTOR.

3 CHAPMAN SPEAKER RIGGING - MOTOR CONTROL RISER
SCALE: NO SCALE

GENERAL NOTES:

- A. INSTALLATION SHALL CONFORM TO ALL APPLICABLE NEC, UL, STATE AND LOCAL CODES.
- B. STRUCTURAL MEMBERS ARE SHOWN FOR DESIGN INTENT ONLY.
- C. FIELD VERIFY ALL DIMENSIONS AND MOUNTING CONDITIONS PRIOR TO INSTALLATION.
- D. COORDINATE INSTALLATION OF SPEAKERS WITH AV CONTRACTOR. FINAL LOCATION OF ADDED STRUCTURE AND BLOCKS MUST BE COORDINATED ON SITE WITH AV CONTRACTOR.